

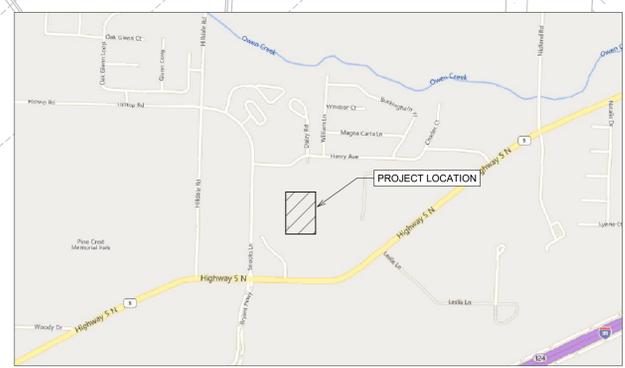
**GENERAL CONSTRUCTION NOTES**

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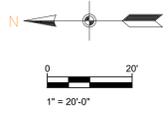
**SITE PLAN**

1. 64 PARKING SPACES PROVIDED INCLUDING 3 ADA ACCESSIBLE PARKING SPACES
2. ALL DIMENSIONS ARE TO THE BACK OF CURB AND/OR EDGE OF PAVEMENT
3. DAMAGE TO PUBLIC AND PRIVATE PROPERTY DUE TO HAULING OPERATIONS OR OPERATIONS OF CONSTRUCTION RELATED EQUIPMENT FROM A CONSTRUCTION SITE SHALL BE REPAIRED BY THE RESPONSIBLE PARTY PRIOR TO THE ISSUANCE OF A CERTIFICATE OF OCCUPANCY.
4. REPAIR, REPLACE, OR EXTEND EXISTING DAMAGED OR MISSING CURB AND GUTTER, SIDEWALK OR RAMPS WITHIN THE PUBLIC RIGHT OF WAY.
5. ALL SIGNAGE, PAVEMENT MARKING AND PARKING LOT STRIPING SHALL CONFORM TO REQUIREMENTS GIVEN IN MANUAL OF UNIFORM TRAFFIC CONTROL DEVICES (MUTCD). MUTCD REQUIRES THAT PARKING SPACES BE MARKED IN WHITE.

SCALE 1" = 20'



**VICINITY MAP**  
SCALE 1" = 1000'



**PHILLIP LEWIS ENGINEERING, INC.**  
Structural + Civil Consultants  
23620 Interstate 30 | Bryant, Arkansas  
PH: 501-350-9840



REVISION:

**SUMMERWOOD SPORTS GYMNASIUM #3**  
7817 Hwy 5 N  
Bryant, Arkansas




PROJECT NUMBER:

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1/10/2024

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SITE PLAN

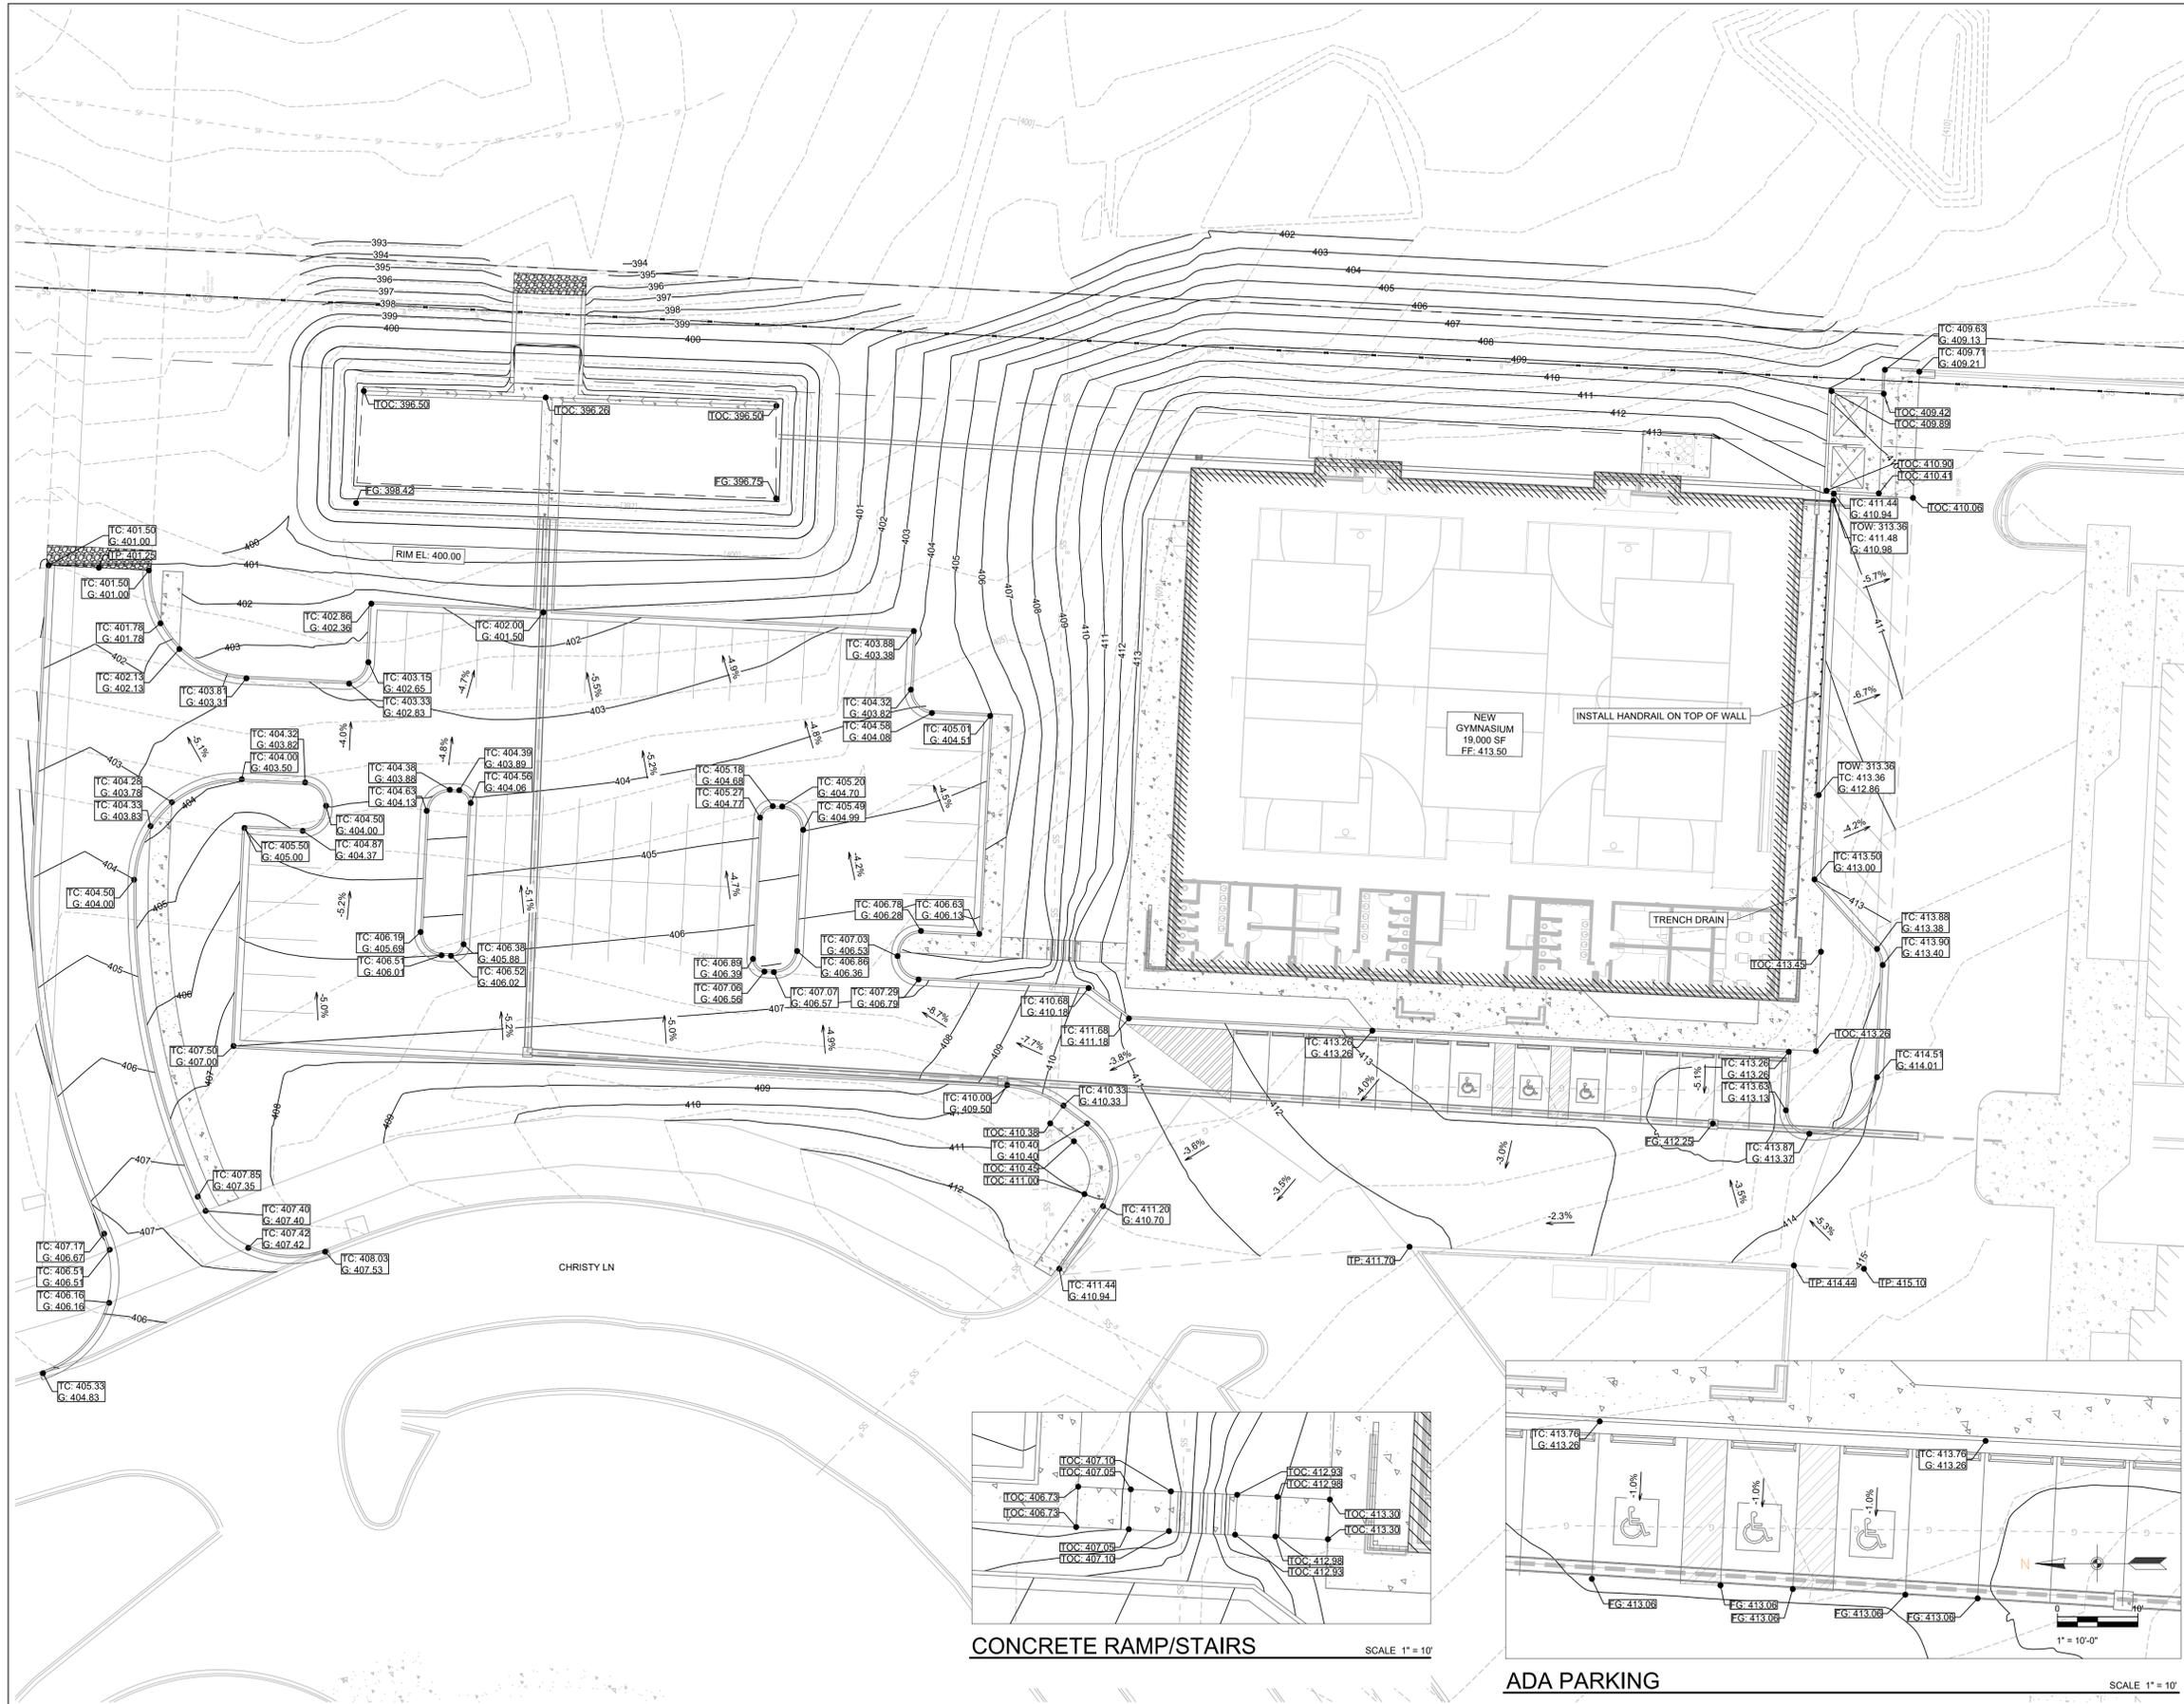
SHEET NUMBER:  
C1.1



### GRADING PLAN


- G = GUTTER ELEVATION
- TP = TOP OF PAVEMENT ELEVATION
- TOC = TOP OF CONCRETE ELEVATION
- FG = FINAL GRADE ELEVATION (NON PAVED AREAS)
- TC = TOP OF CURB ELEVATION
- TOW = TOP OF WALL

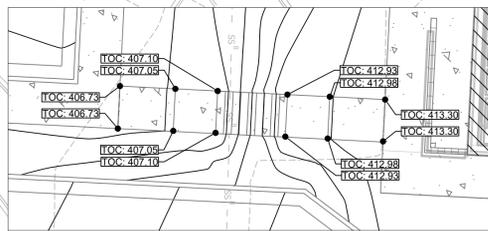SCALE 1" = 20'



CONCRETE RAMP/STAIRS

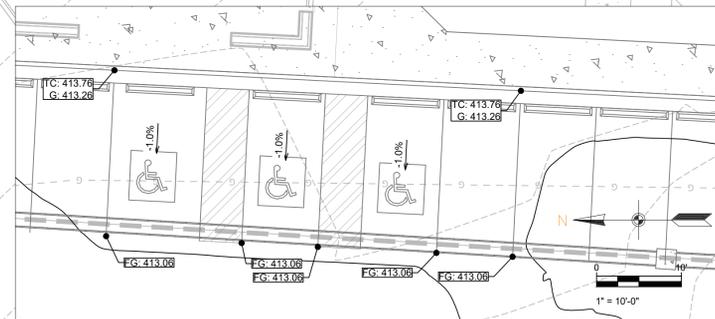SCALE 1" = 10'



ADA PARKING

SCALE 1" = 10'

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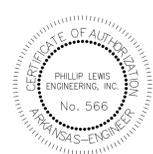
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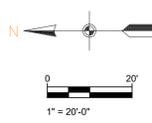
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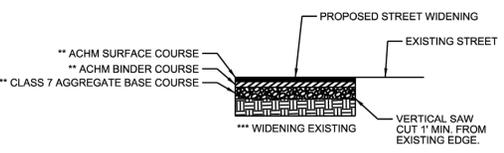
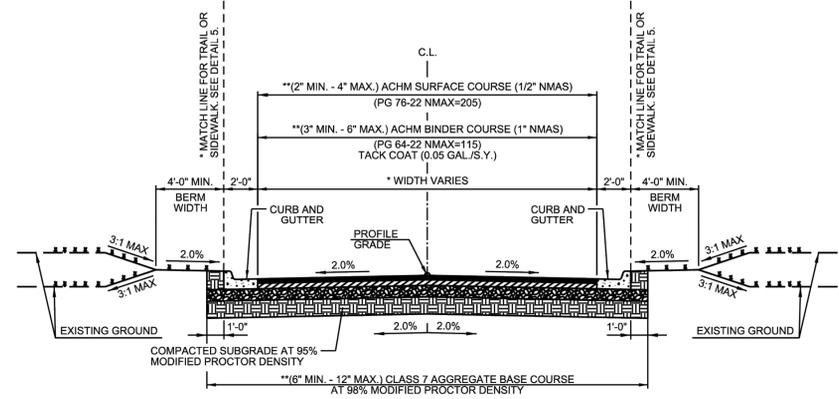
REVISION:

**SUMMERWOOD SPORTS GYMNASIUM #3**  
7817 Hwy 5 N  
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PROJECT NUMBER:  
SHEET ISSUE DATE:  
1/10/2024  
PAGE TITLE:  
**GRADING PLAN**  
SHEET NUMBER:  
**C1.2**





- GENERAL NOTES**
- IN AREAS TO RECEIVE BITUMINOUS PAVING, CONCRETE DRIVEWAYS OR CURB AND GUTTER, SUBGRADE SHALL BE COMPACTED TO A DENSITY NOT LESS THAN 95% OF MAXIMUM MODIFIED DENSITY OBTAINED AT OPTIMUM MOISTURE CONTENT.
  - FOR AREAS OF SUBGRADE PREPARATION TO RECEIVE CONCRETE SIDEWALKS, SUBGRADE SHALL BE COMPACTED TO DENSITY OF 90% MAXIMUM MODIFIED DENSITY.
  - CRUSHED STONE - MATERIAL IN EACH COURSE SHALL BE COMPACTED TO A DENSITY OF 98% MAXIMUM MODIFIED DENSITY.
  - ACHM BASE COURSE (4" MIN. - 12" MAX.) (1 1/2" NMAS) MAY BE USED IF INCLUDED IN AN APPROVED PAVEMENT DESIGN.
- CROSS SECTIONS AND RIGHT-OF-WAY SHALL ADHERE TO THE MINIMUM WIDTH REQUIREMENTS SHOWN IN THE CITY OF BRYANT MASTER TRANSPORTATION PLAN. THE DEVELOPMENT REVIEW COMMITTEE SHALL DETERMINE WHICH VERSION OF STREET CLASSIFICATION AND WHAT WIDTHS WILL BE REQUIRED.**
- THICKNESS TO BE DETERMINED BY PAVEMENT DESIGN IN ACCORDANCE WITH SECTION 5.0 OF THE MINIMUM STANDARD SPECIFICATIONS FOR STREETS.**
- PAVEMENT RECONSTRUCTION TO CENTERLINE IS REQUIRED WHEN EXISTING STREET DOES NOT MEET THESE STANDARDS.**



**CITY OF BRYANT**

**TYPICAL SECTION MINOR ARTERIAL**

ISSUE DATE: AUGUST 2021

REVISION DATE:

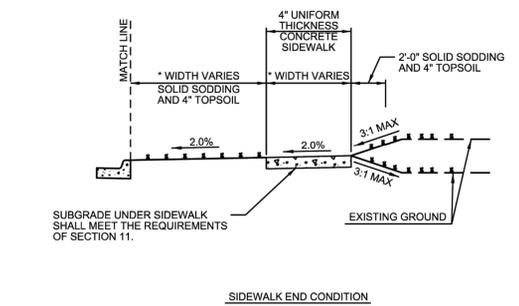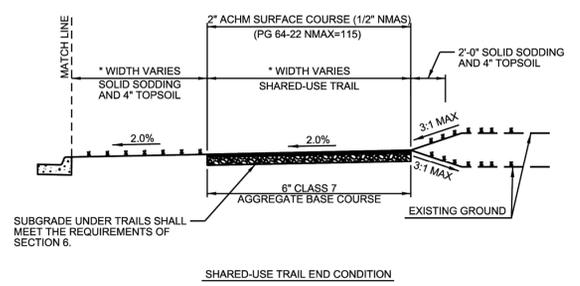**DETAIL 1**



**\* WIDTH SHALL ADHERE TO THE MINIMUM WIDTH REQUIREMENTS SHOWN IN THE CITY OF BRYANT MASTER TRANSPORTATION PLAN. THE DEVELOPMENT REVIEW COMMITTEE SHALL DETERMINE WHICH VERSION OF STREET CLASSIFICATION AND WHAT WIDTHS WILL BE REQUIRED.**


**CITY OF BRYANT**

**TYPICAL SECTION END CONDITIONS**


ISSUE DATE: AUGUST 2021

REVISION DATE:

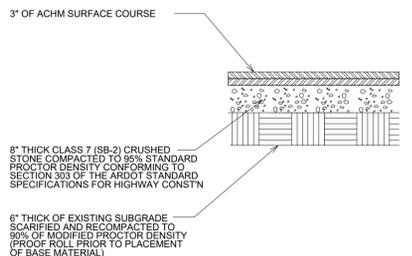
**DETAIL 5**



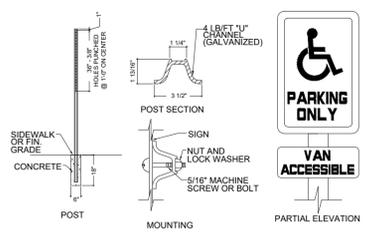
**HMAC ASPHALT SURFACE COURSE MEDIUM DUTY** NOT TO SCALE




**HANDICAP SIGN DETAIL** NOT TO SCALE

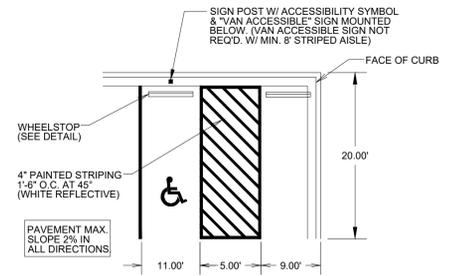


**TYPICAL ACCESSIBLE PARKING STALLS**

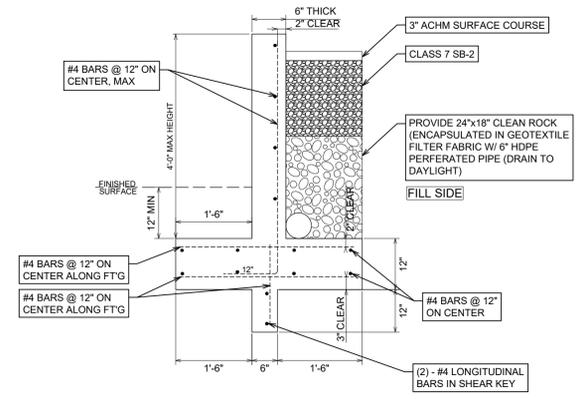


**RETAINING WALL** NOT TO SCALE

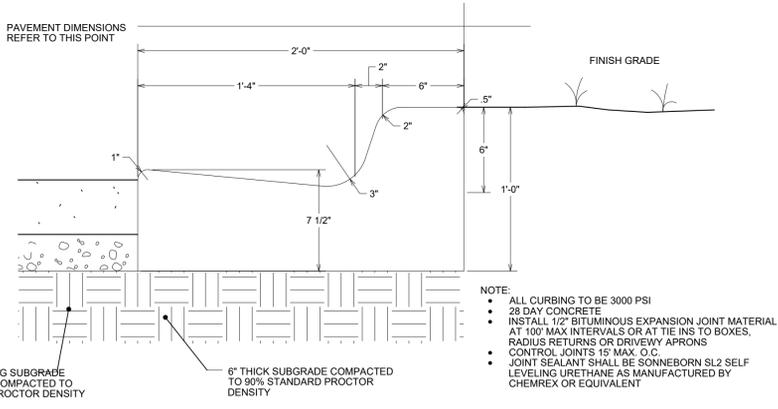


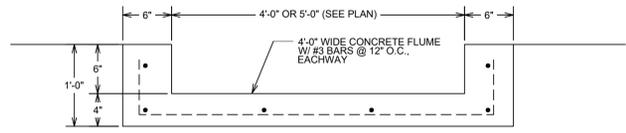
**2-0" CONCRETE CURB & GUTTER** NOT TO SCALE



**CONCRETE FLUME DETAIL** NOT TO SCALE

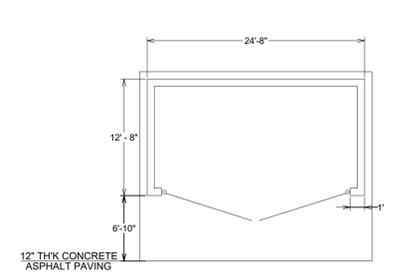

**DUMPSTER PAD/ENCLOSURE DETAIL**

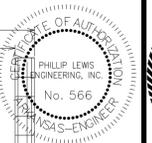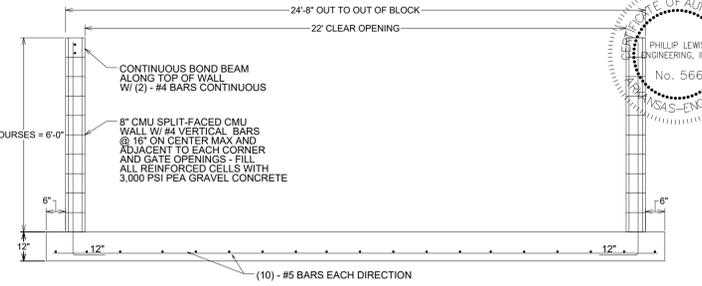

PROJECT NUMBER:

SHEET ISSUE DATE: 1/10/2024

PAGE TITLE: SITE DETAILS

SHEET NUMBER: C1.3


**SUMMERWOOD SPORTS GYMNASIUM #3**

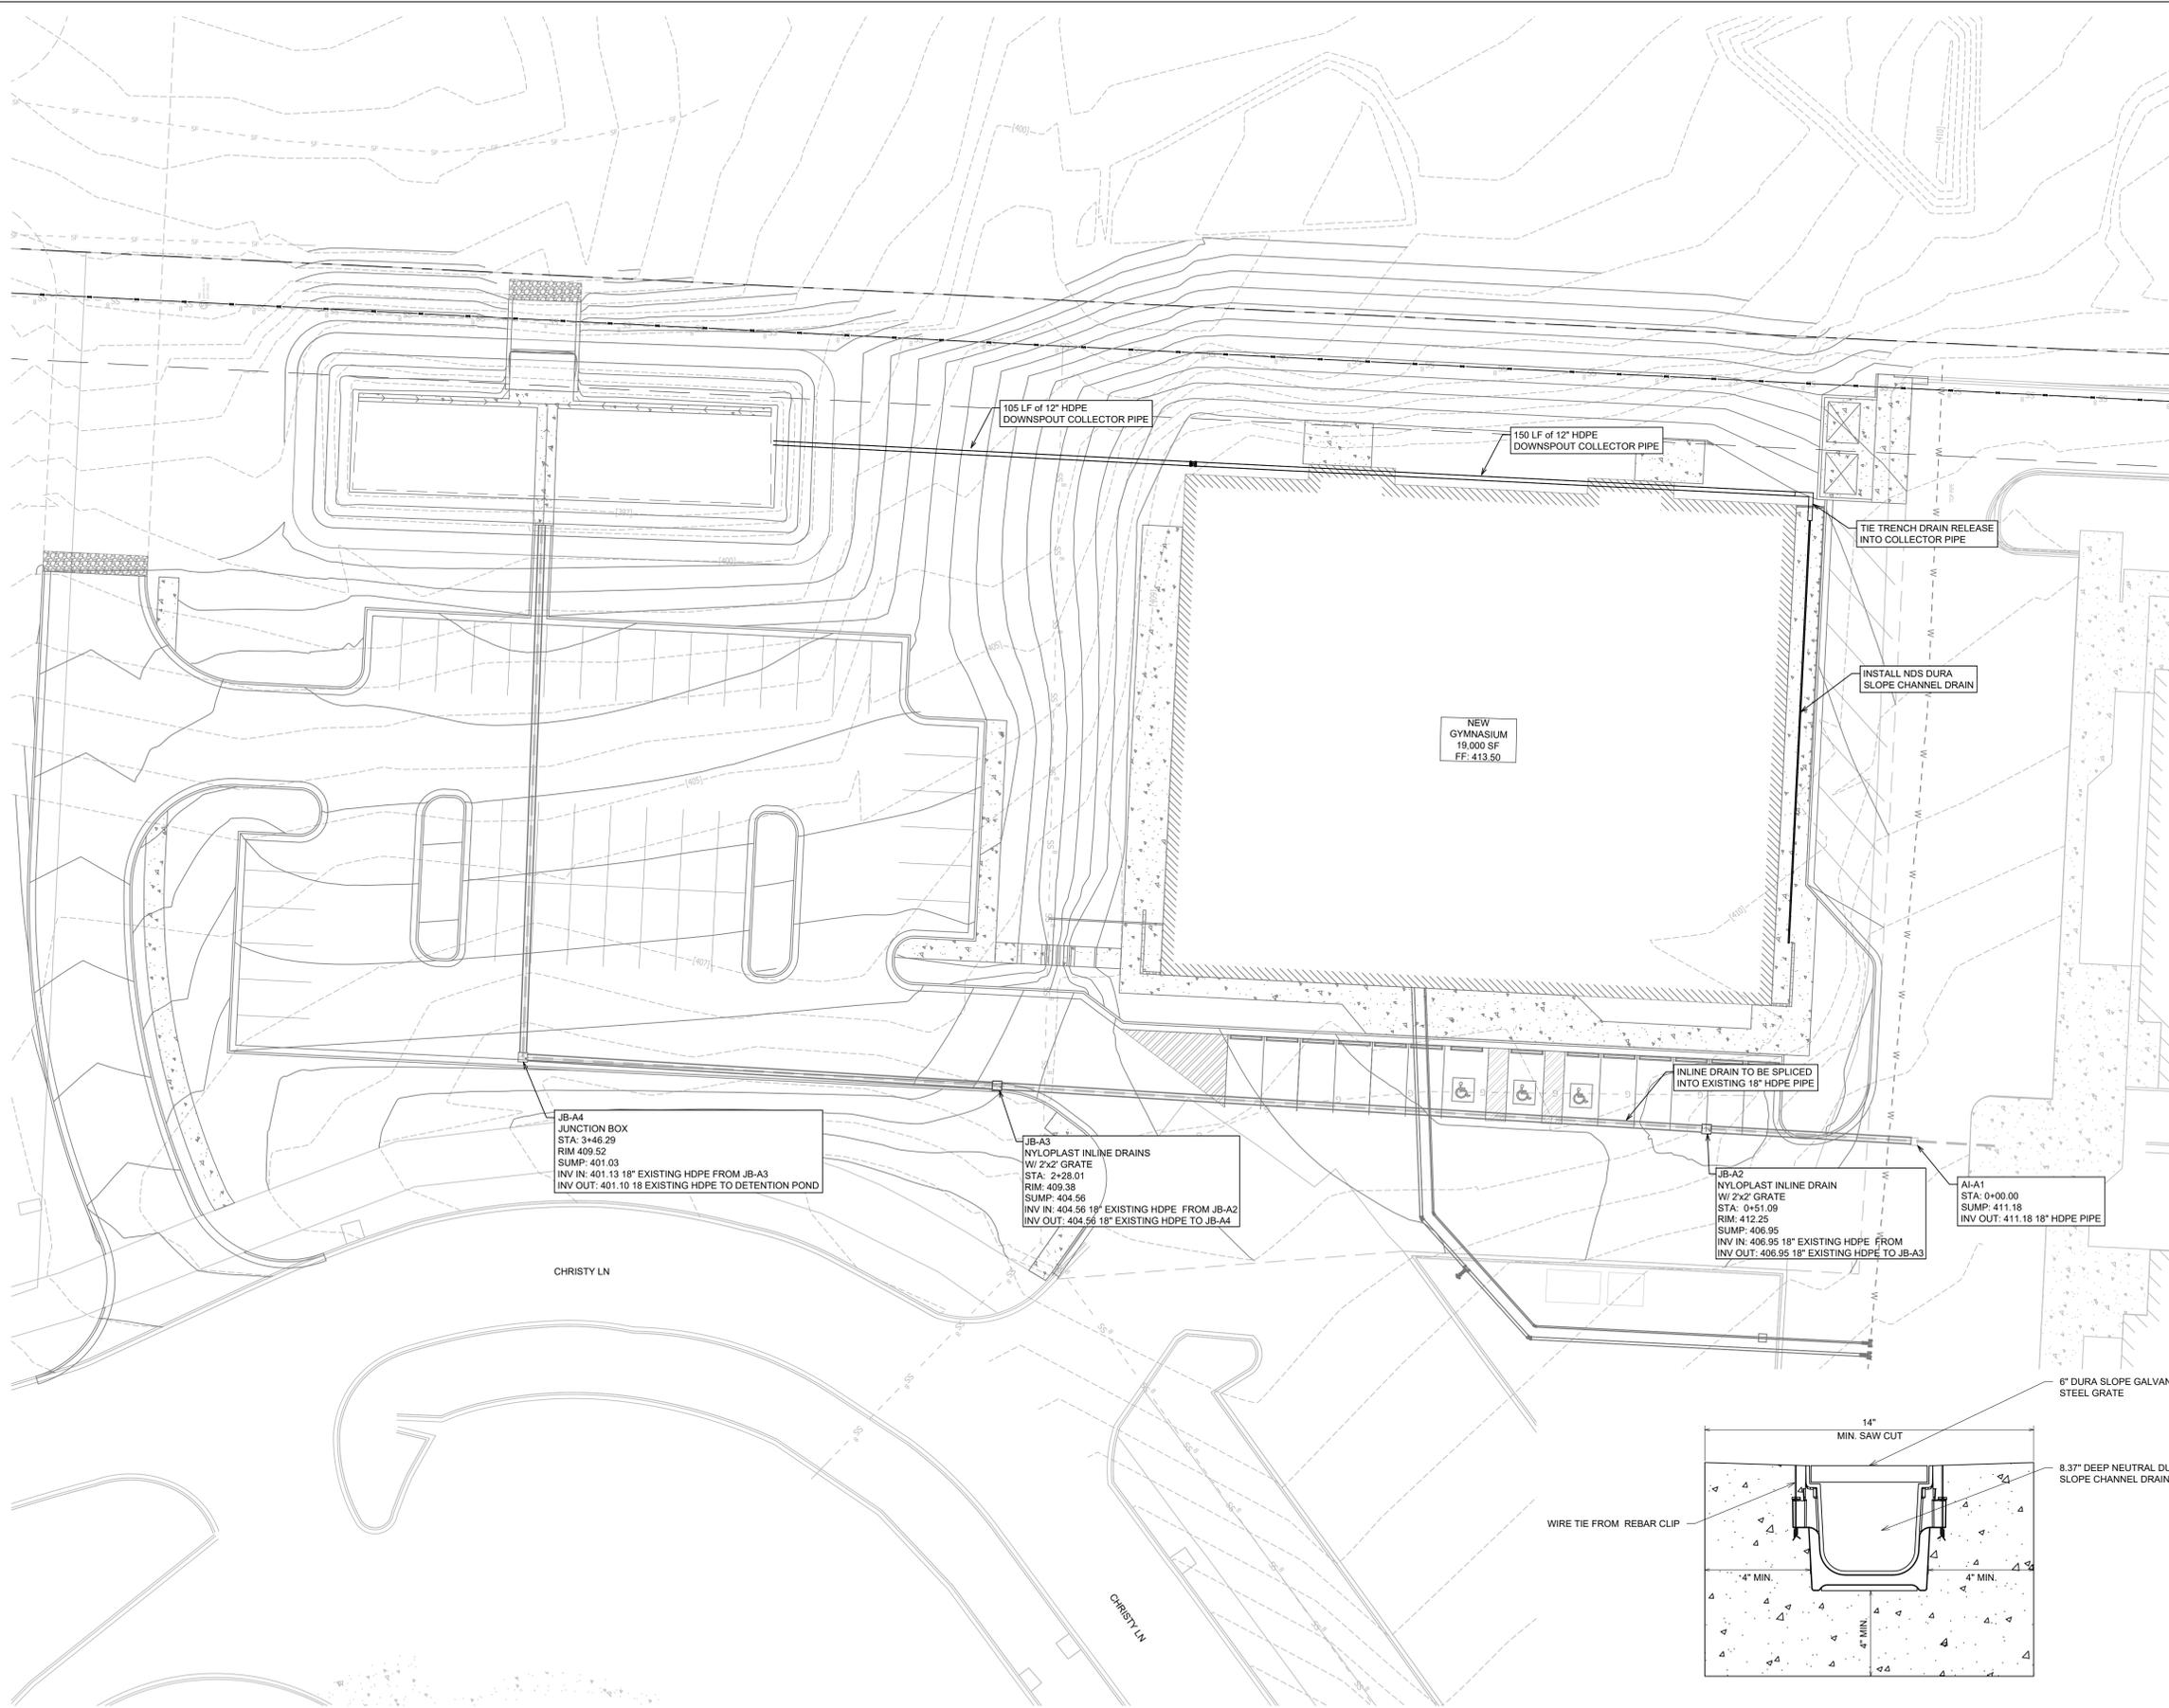7817 Hwy 5 N  
Bryant, Arkansas

**PHILLIP LEWIS ENGINEERING, INC.**

Structural + Civil Consultants

23620 Interstate 30 | Bryant, Arkansas  
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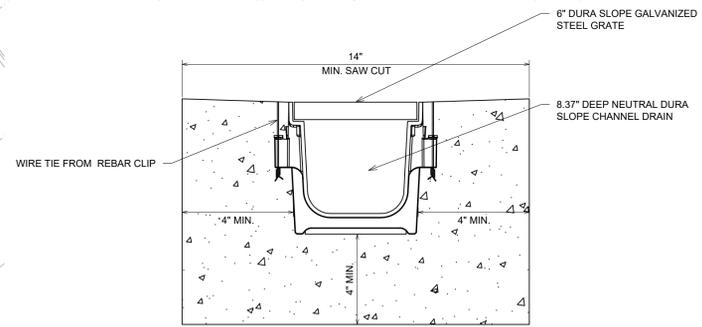
**SUMMERWOOD SPORTS GYMNASIUM #3**  
 7817 Hwy 5 N  
 Bryant, Arkansas

JB-A4  
 JUNCTION BOX  
 STA: 3+46.29  
 RIM: 409.52  
 SUMP: 401.03  
 INV IN: 401.13 18" EXISTING HDPE FROM JB-A3  
 INV OUT: 401.10 18" EXISTING HDPE TO DETENTION POND

JB-A3  
 NYLOPLAST INLINE DRAINS  
 W/ 2x2" GRATE  
 STA: 2+28.01  
 RIM: 409.38  
 SUMP: 404.56  
 INV IN: 404.56 18" EXISTING HDPE FROM JB-A2  
 INV OUT: 404.56 18" EXISTING HDPE TO JB-A4

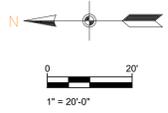
JB-A2  
 NYLOPLAST INLINE DRAIN  
 W/ 2x2" GRATE  
 STA: 0+51.09  
 RIM: 412.25  
 SUMP: 406.95  
 INV IN: 406.95 18" EXISTING HDPE FROM  
 INV OUT: 406.95 18" EXISTING HDPE TO JB-A3

AI-A1  
 STA: 0+00.00  
 SUMP: 411.18  
 INV OUT: 411.18 18" HDPE PIPE



- NOTES:  
 1. CHANNELS TO BE INSTALLED WITH GRATE. GRATE TO BE PROTECTED FROM CONCRETE POUR.  
 2. INSTALLATION TO BE COMPLETED IN ACCORDANCE WITH MANUFACTURER'S SPECIFICATIONS.

**NDS DURA SLOPE CHANNEL DRAIN SYSTEM**  
 TYPICAL CHANNEL DRAIN DETAIL. INSTALL SPECIFIED DRAIN SERIES OR SIMILAR LOAD RATING SERIES.




**STORMWATER PLAN**

SCALE 1" = 20'



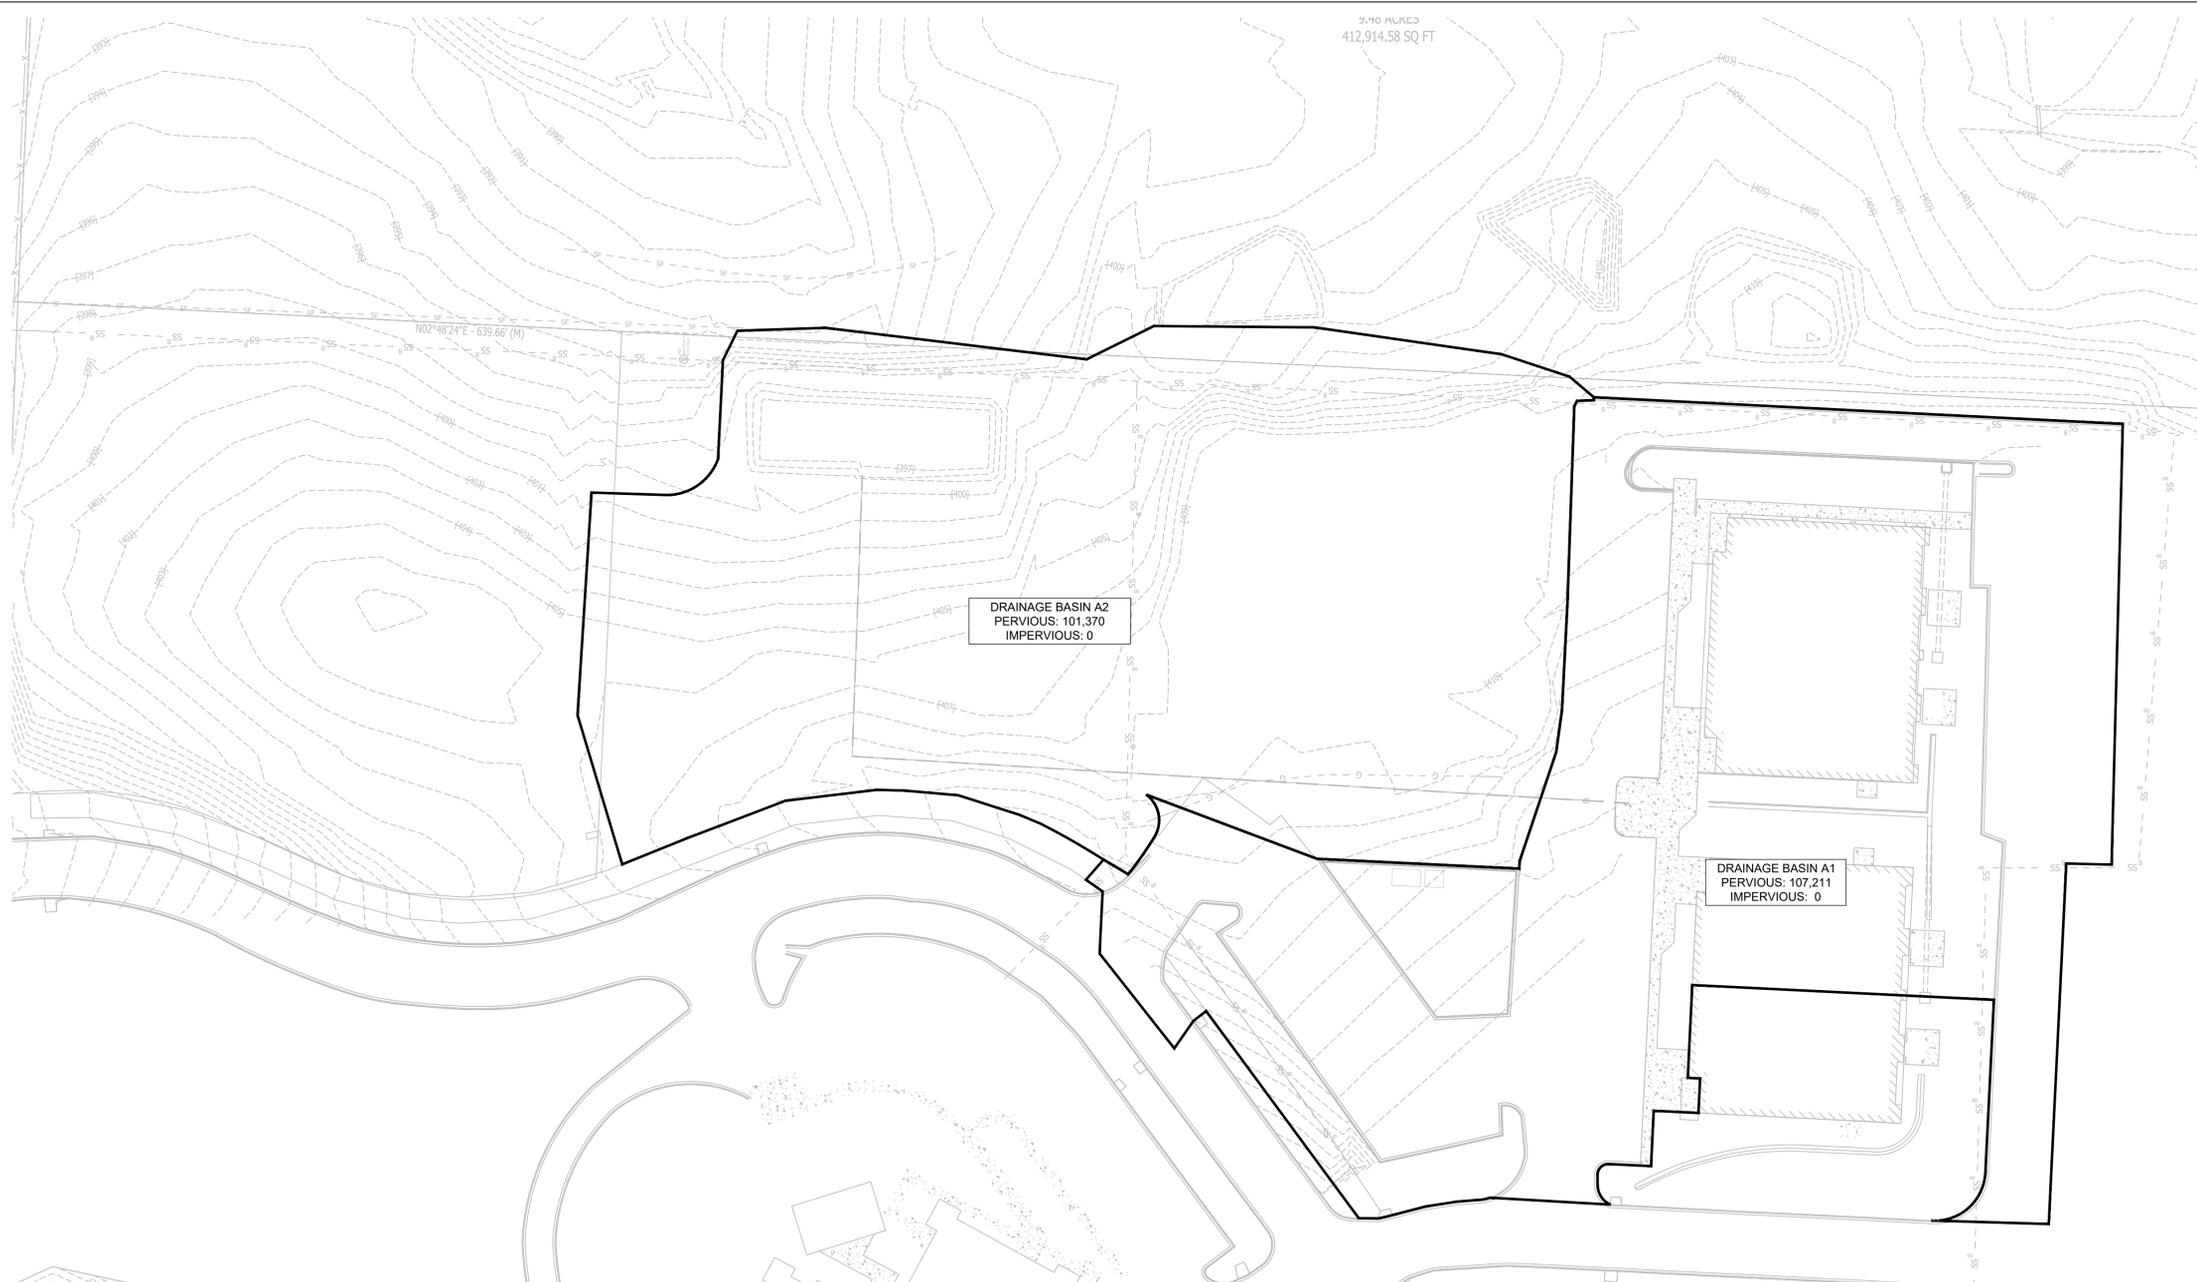PROJECT NUMBER:  
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 1/10/2024  
 PAGE TITLE:  
**STORMWATER PLAN**  
 SHEET NUMBER:  
**C1.4**





3.40 ALKED  
412,914.58 SQ FT

DRAINAGE BASIN A2  
PERVIOUS: 101,370  
IMPERVIOUS: 0

DRAINAGE BASIN A1  
PERVIOUS: 107,211  
IMPERVIOUS: 0

PRE-DEV DRAINAGE MAP

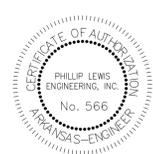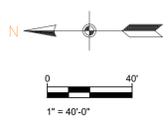SCALE 1" = 40'



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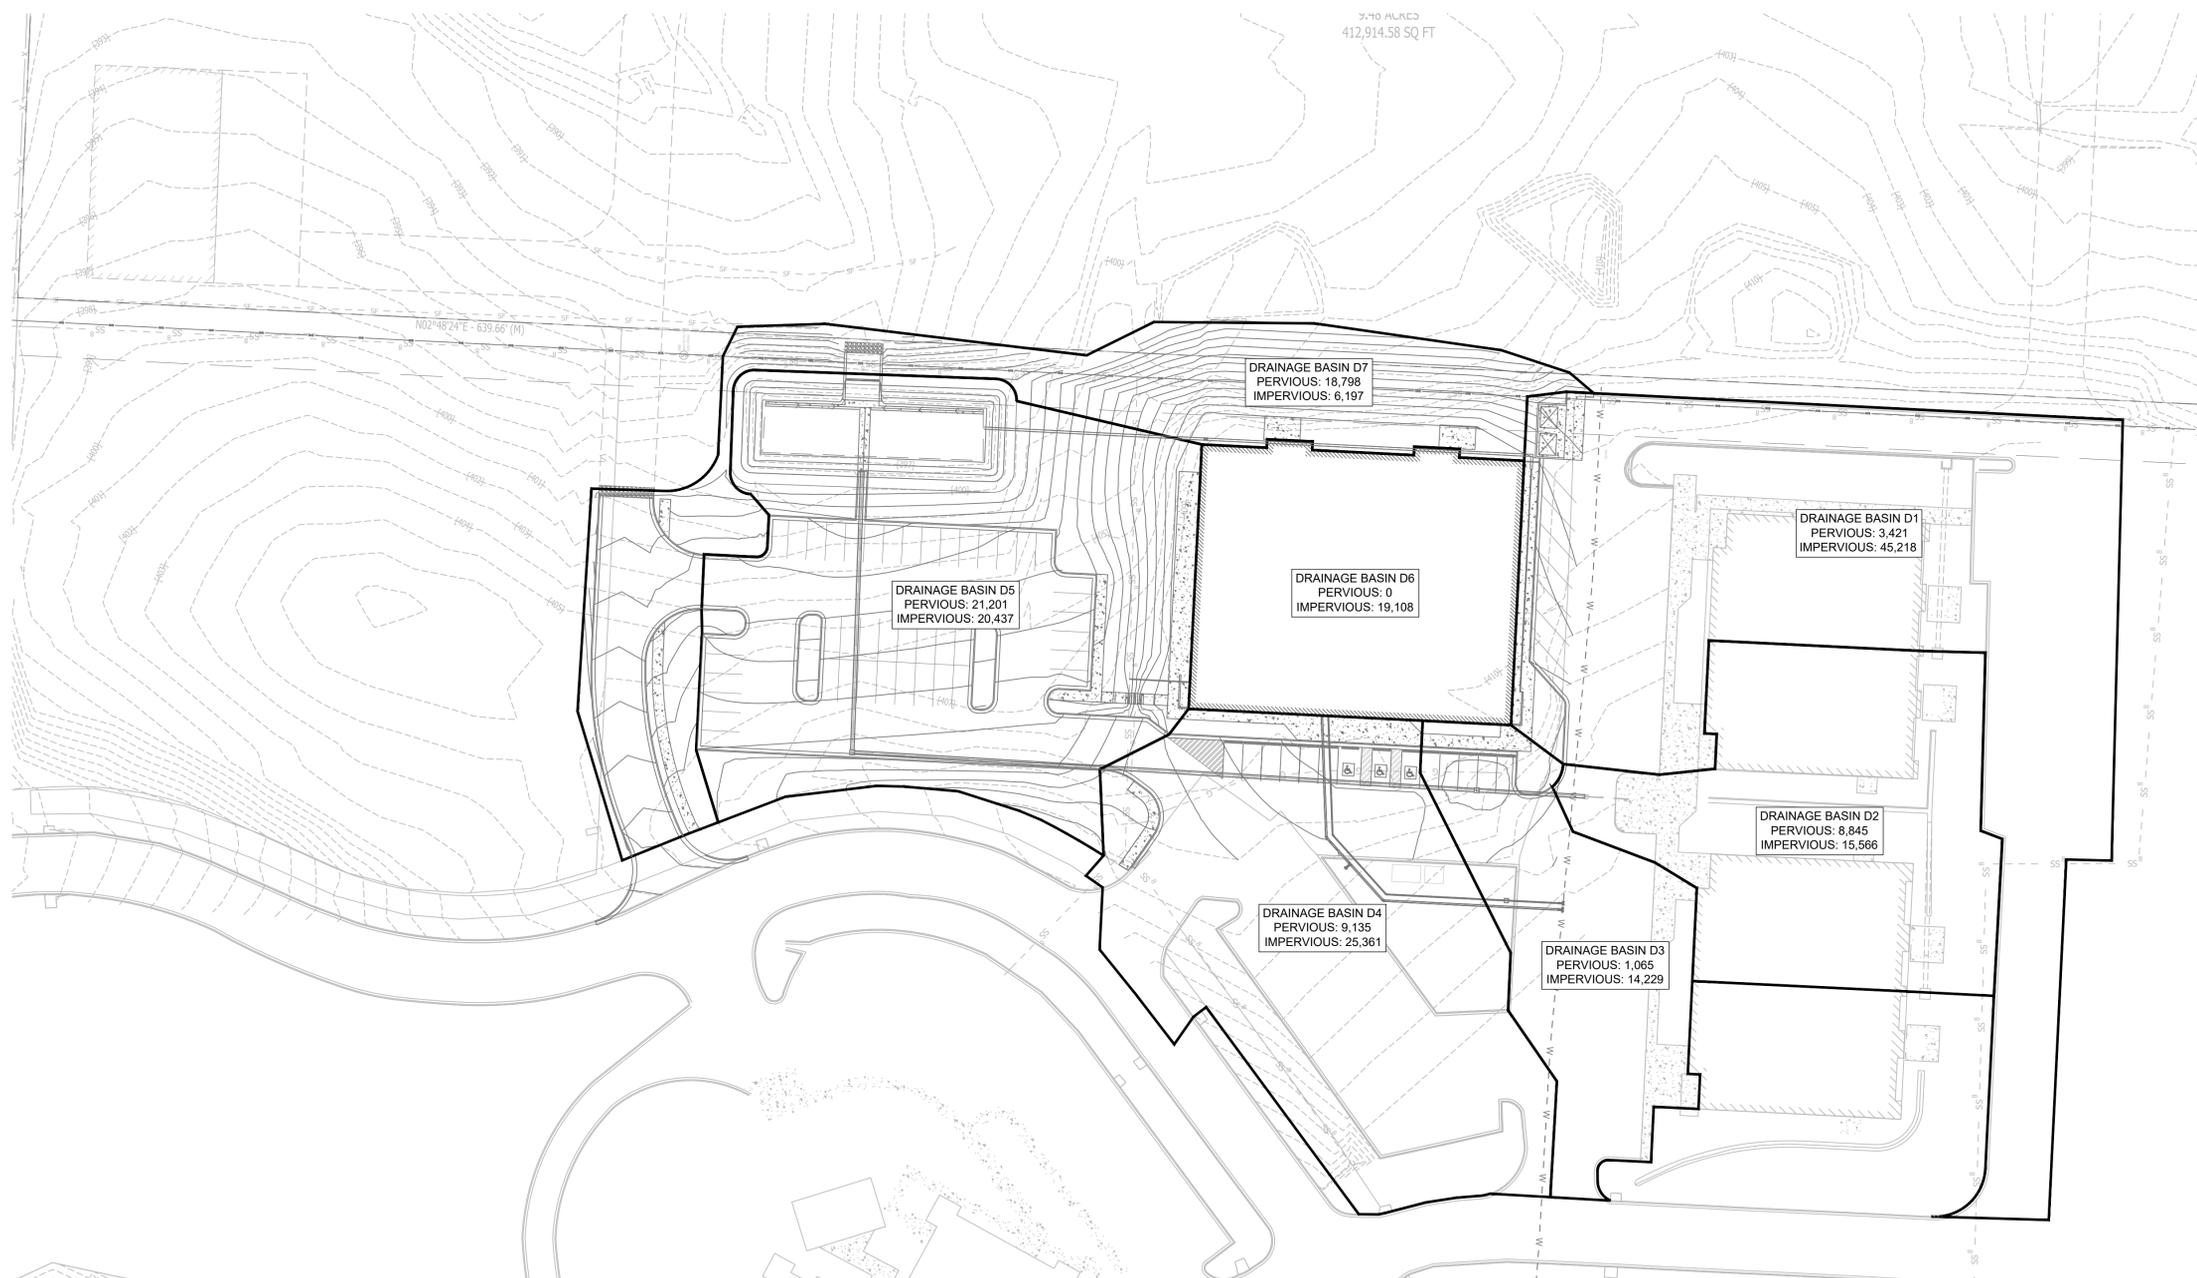
SHEET ISSUE DATE:  
1/10/2024

PAGE TITLE:

PRE-DEV DRAINAGE MAP

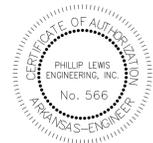
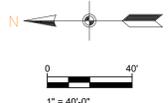
SHEET NUMBER:

C1.5



POST-DEV DRAINAGE MAP

SCALE 1" = 40'



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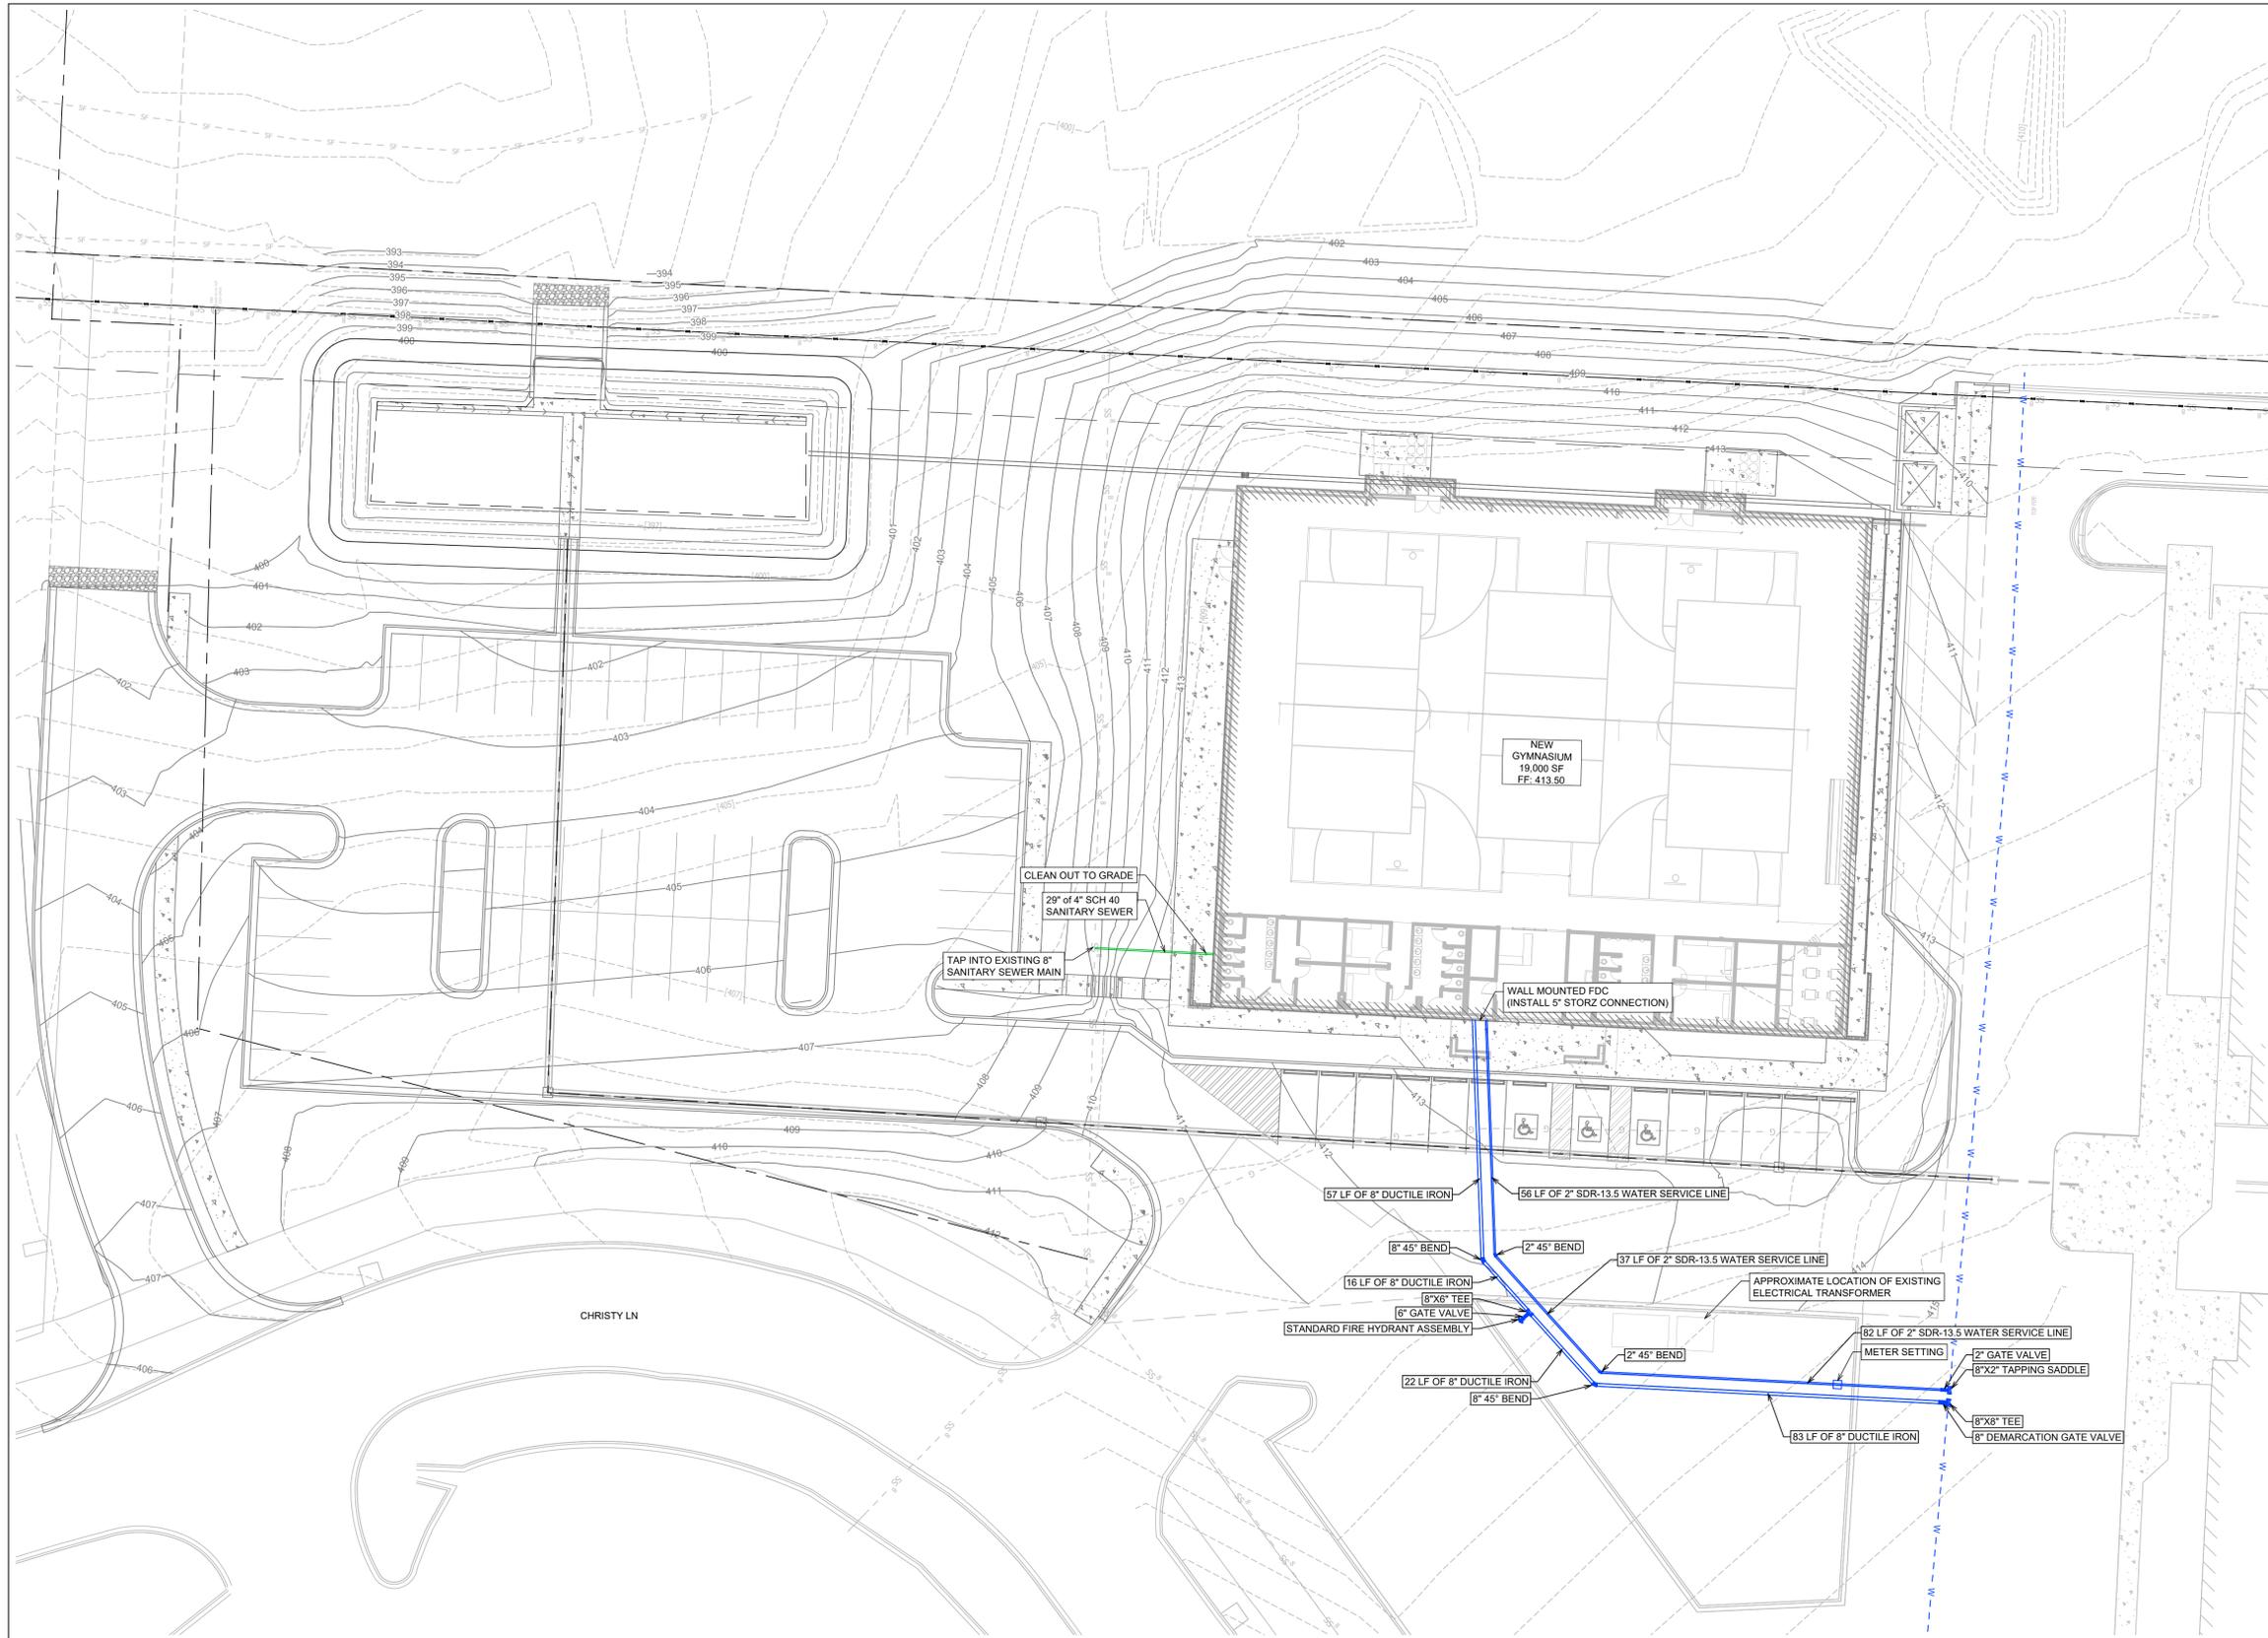
SHEET ISSUE DATE:  
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PAGE TITLE:

POST-DEV DRAINAGE MAP

SHEET NUMBER:

C1.6




**UTILITY PLAN**

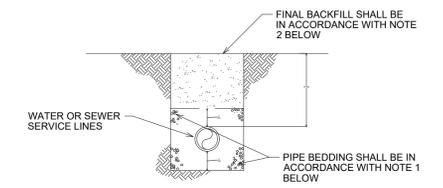SCALE 1" = 20'

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- B. IN ACCORDANCE WITH GENERALLY ACCEPTED CONSTRUCTION PRACTICES, THE CONTRACTOR WILL SOLELY AND COMPLETELY BE RESPONSIBLE FOR CONDITIONS OF THE JOB SITE, INCLUDING SAFETY WORK. THIS REQUIREMENT WILL APPLY CONTINUOUSLY AND WILL NOT BE LIMITED TO NORMAL WORKING HOURS.
- C. THE DUTY OF BRYANT UTILITIES TO CONDUCT CONSTRUCTION INSPECTION REVIEWS OF THE CONTRACTOR'S PERFORMANCE IS NOT AN INSPECTION OR REVIEW OF THE ADEQUACY OF THE CONTRACTOR'S SAFETY MEASURES IN, ON, OR NEAR THE CONSTRUCTION SITE.
- D. ALL WATER AND SEWER IMPROVEMENTS SHALL BE CONSTRUCTED IN ACCORDANCE WITH THE LATEST REVISION TO THE CITY OF BRYANT'S WATER AND WASTEWATER (SANITARY SEWER) STANDARD SPECIFICATIONS.
- E. THE CONTRACTOR IS SPECIFICALLY CAUTIONED THAT THE LOCATION AND/OR ELEVATION OF EXISTING UTILITIES AS SHOWN ON THESE PLANS IS BASED ON RECORDS OF THE VARIOUS UTILITY COMPANIES AND, WHERE POSSIBLE, MEASUREMENTS TAKEN IN THE FIELD. THE INFORMATION IS NOT TO BE RELIED ON AS BEING EXACT OR COMPLETE. THE CONTRACTOR MUST CALL THE APPROPRIATE UTILITY COMPANY AT LEAST 48 HOURS BEFORE ANY EXCAVATION TO REQUEST EXACT FIELD LOCATION OF ALL UTILITIES. IT SHALL BE THE RESPONSIBILITY OF THE CONTRACTOR TO LOCATE ALL EXISTING UTILITIES WHICH CONFLICT WITH PROPOSED IMPROVEMENTS SHOWN ON THE PLAN.
- F. CONTRACTOR IS TO REMOVE AND DISPOSE OF ALL DEBRIS, RUBBISH, AND OTHER MATERIALS RESULTING FROM PREVIOUS AND CURRENT DEMOLITION OPERATIONS. DISPOSAL WILL BE IN ACCORDANCE WITH ALL LOCAL, STATE AND/OR FEDERAL REGULATIONS GOVERNING SUCH OPERATIONS.
- G. PRIOR TO INSTALLATION OF ANY UTILITIES, THE CONTRACTOR IS TO EXCAVATE, VERIFY AND CALCULATE ALL CROSSINGS AND INFORM ANY AND ALL UTILITIES OF ANY CONFLICTS PRIOR TO CONSTRUCTION.
- H. CONSTRUCTION SHALL NOT START ON ANY WATER UTILITY TIE-INS UNTIL APPROVAL IS GIVEN BY BRYANT UTILITIES. SAID CONTRACTOR SHALL NOT OPERATE ANY VALVE, HYDRANT, OR WATER UTILITY APPURTENANCE NOR SHALL HE ATTACH TO OR TAP ANY WATER UTILITY MAIN WITHOUT APPROVAL. THE CONTRACTOR SHALL BEAR THE COST AND CONSEQUENCE OF ANY DISRUPTION OF UTILITY OPERATION CAUSED BY CONSTRUCTION.
- I. FIBER OPTIC CABLE ON AND/OR ADJACENT TO THIS SITE WERE NOT LOCATED BY THE SURVEY AND ARE NOT SHOWN. IT IS THE RESPONSIBILITY OF THE CONTRACTOR TO LOCATE ANY FIBER OPTIC CABLES ASSOCIATED WITH THIS SITE AND TAKE ALL NECESSARY AND REQUIRED PRECAUTIONS TO PROTECT ANY EXISTING FIBER OPTIC CABLES. CONTRACTORS SHALL COORDINATE ALL EFFORTS WITH OWNER OF FIBER OPTIC CABLES OR THEIR DESIGNATED REPRESENTATIVE.
- J. THE CONTRACTOR IS RESPONSIBLE FOR CONTACTING "ONECALL" SERVICE TO MARK ALL UTILITIES PRIOR TO ANY DEMOLITION, EARTHWORK, OR UTILITY WORK ON THIS SITE.



**WATER AND SEWER LINES BEDDING DETAIL**  
NOT TO SCALE

- NOTES:
- 1. BEDDING SHALL BE "GRIT" PER ASTM 2774 OR ASTM D448 SIZE 67 A MINIMUM OF 6" ALL AROUND PIPE.
- 2. INITIAL BACKFILL NOT UNDER PAVED AREAS CAN BE CLASS III COMPACTED TO 90% STANDARD PROCTOR. ALL BACKFILL UNDER PAVED AREAS SHALL BE CLASS 7 CRUSHED STONE (SB-2) COMPACTED TO 95% STANDARD PROCTOR DENSITY.
- 3. ALL MATERIALS ARE CLASSIFIED IN ACCORDANCE WITH ASTM D2321-89.
- 4. ALL MATERIALS SHALL BE INSTALLED IN MAXIMUM 8" LIFTS IN ACCORDANCE WITH ASTM D998. CLASS III AND IV-A MATERIALS SHALL BE COMPACTED TO NEAR OPTIMUM MOISTURE CONTENT.
- 5. FILL SALVAGED FROM EXCAVATION SHALL BE FREE OF DEBRIS, ORGANICS, AND ROCKS LARGER THAN 3".
- 6. ALL TRENCH EXCAVATIONS SHALL BE SLOPED, SHORED, SHEETED, BRACED, OR OTHERWISE SUPPORTED IN COMPLIANCE WITH OSHA REGULATIONS AND LOCAL ORDINANCES.

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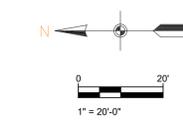



REVISION:

**SUMMERWOOD SPORTS GYMNASIUM #3**  
7817 Hwy 5 N  
Bryant, Arkansas

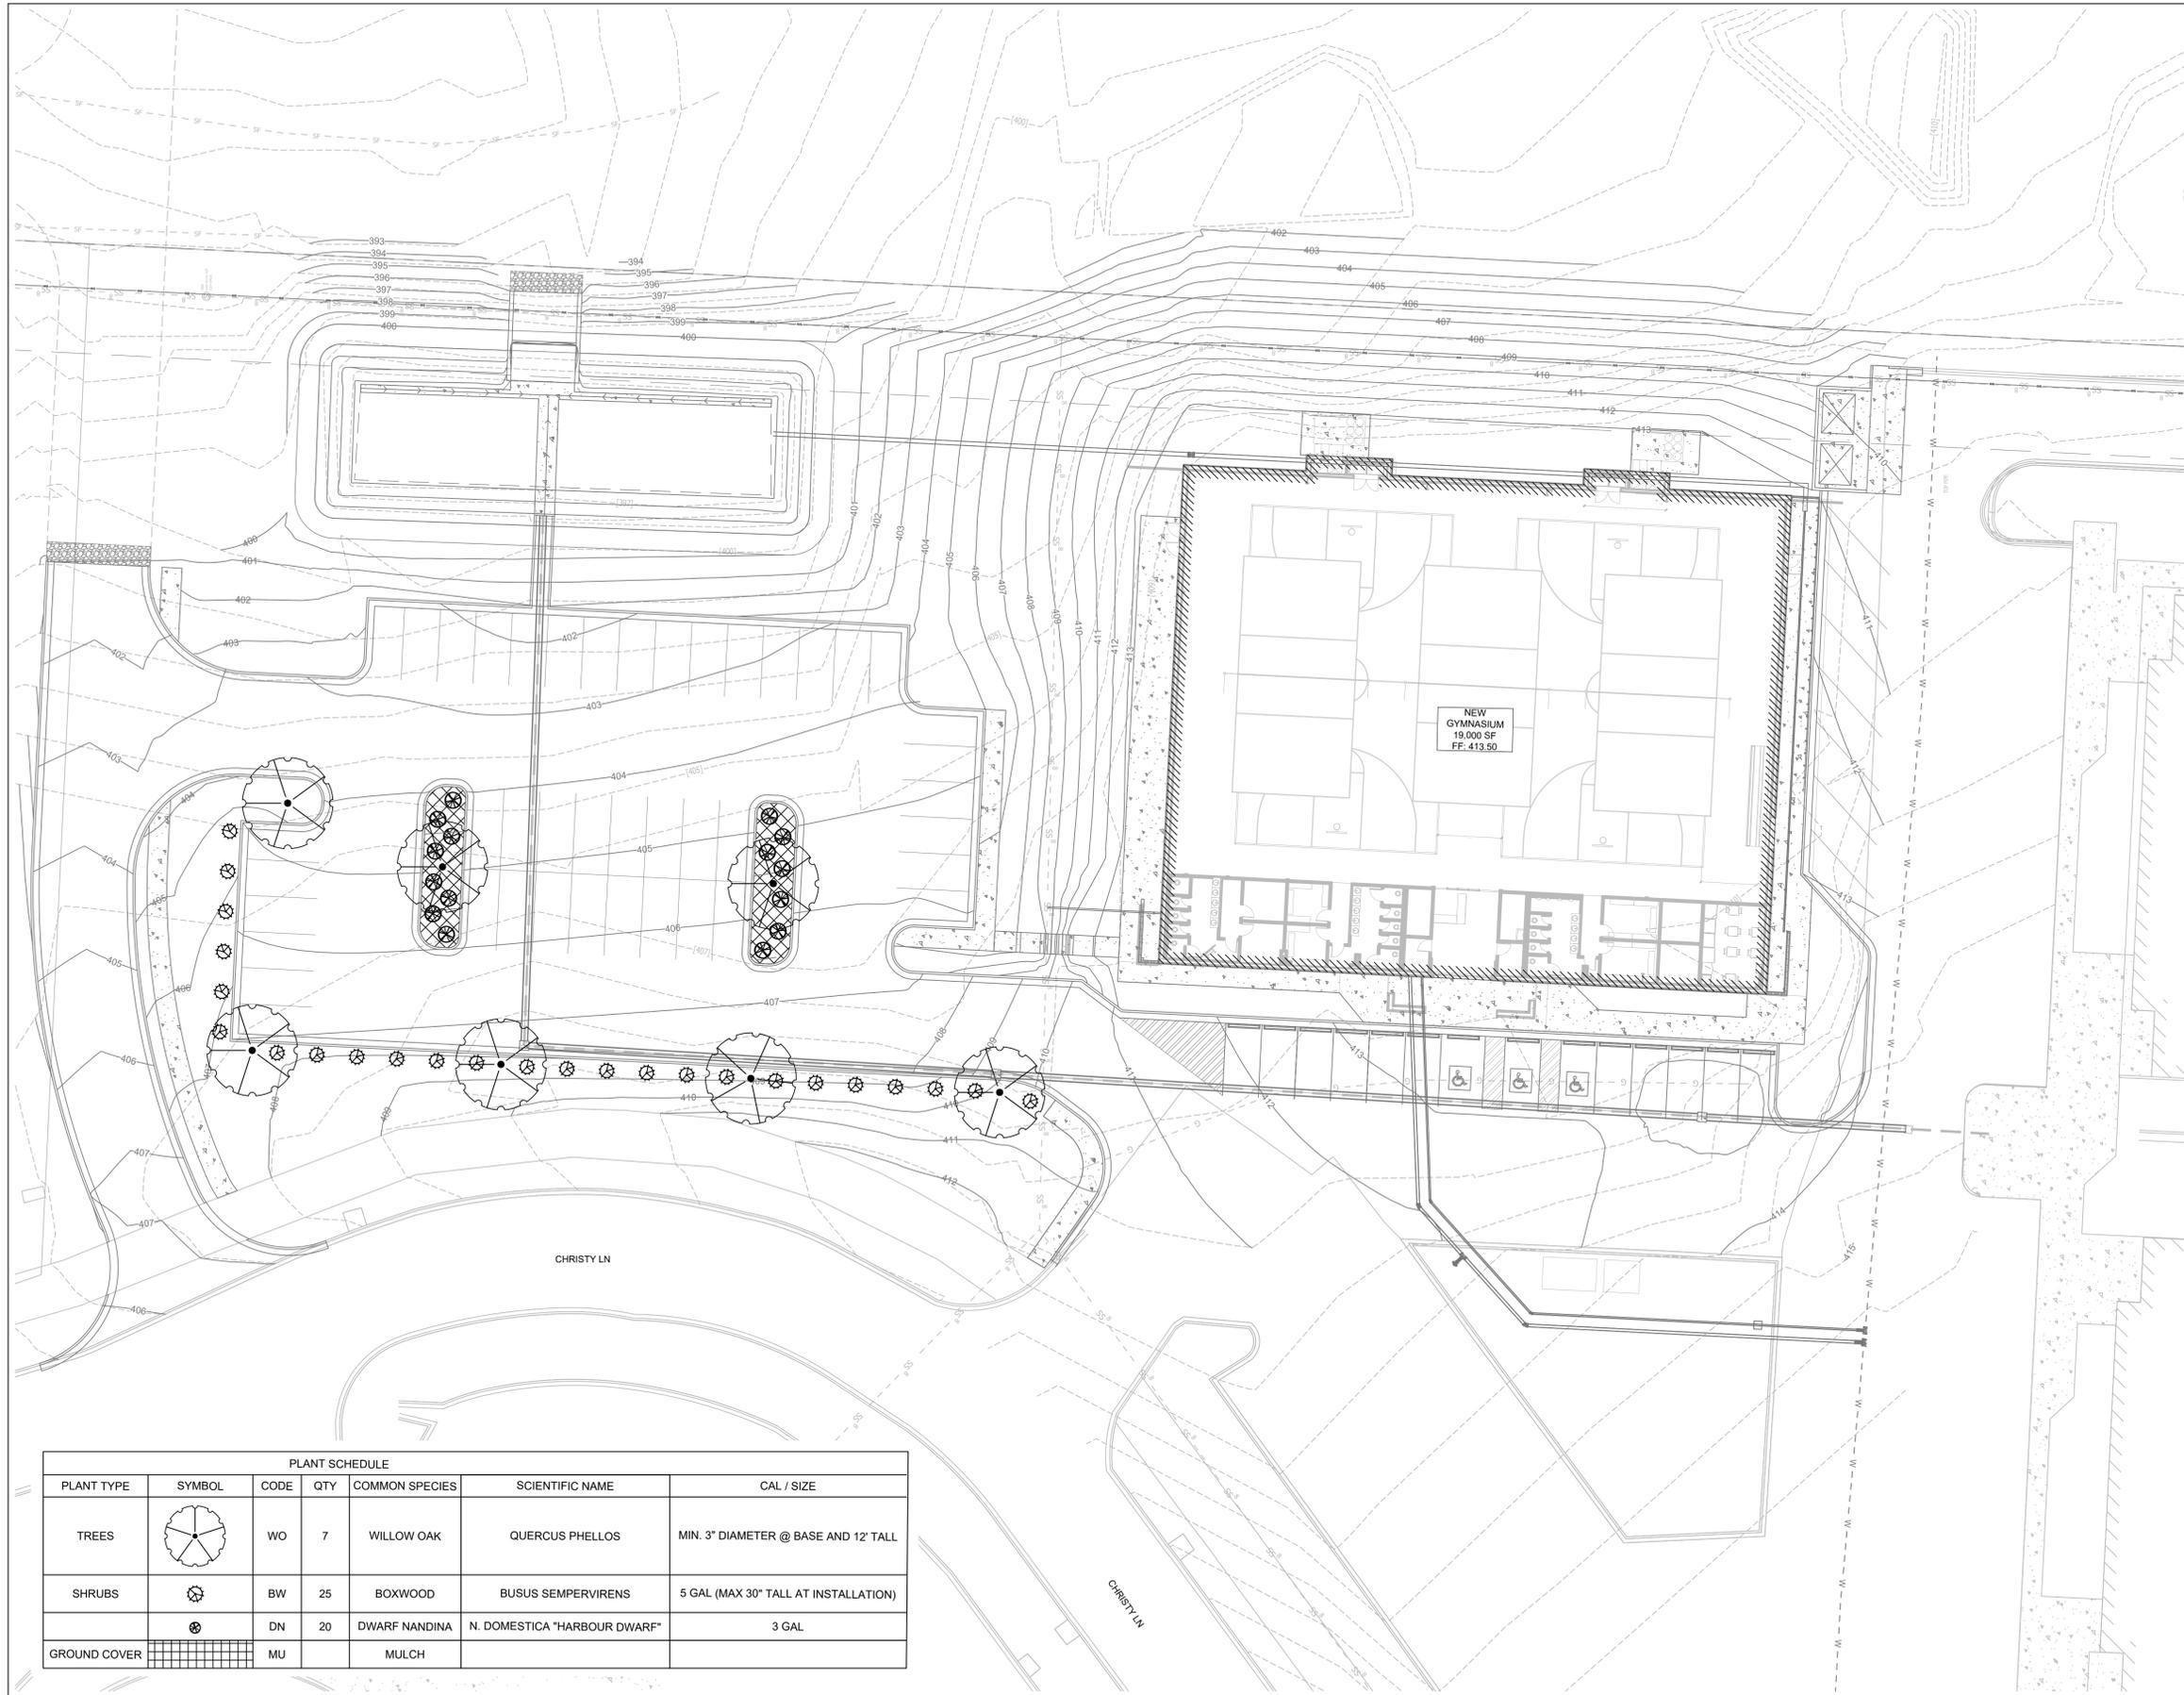PRELIMINARY  
NOT FOR CONSTRUCTION

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**UTILITY PLAN**  
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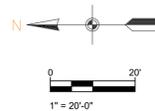


PLANT SCHEDULE						
PLANT TYPE	SYMBOL	CODE	QTY	COMMON SPECIES	SCIENTIFIC NAME	CAL / SIZE
TREES		WO	7	WILLOW OAK	QUERCUS PHELLOS	MIN. 3" DIAMETER @ BASE AND 12' TALL
SHRUBS		BW	25	BOXWOOD	BUSUS SEMPERVIRENS	5 GAL (MAX 30" TALL AT INSTALLATION)
		DN	20	DWARF NANDINA	N. DOMESTICA "HARBOUR DWARF"	3 GAL
GROUND COVER		MU		MULCH		

### LANDSCAPING PLAN

THE ABOVE SPECIES IS OPTIONAL IF OWNER WANTS TO GO WITH THE SAME SPECIES AS ADJACENT PROPERTY

SCALE 1" = 20'



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### SUMMERWOOD SPORTS GYMNASIUM #3

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Bryant, Arkansas



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LANDSCAPING PLAN

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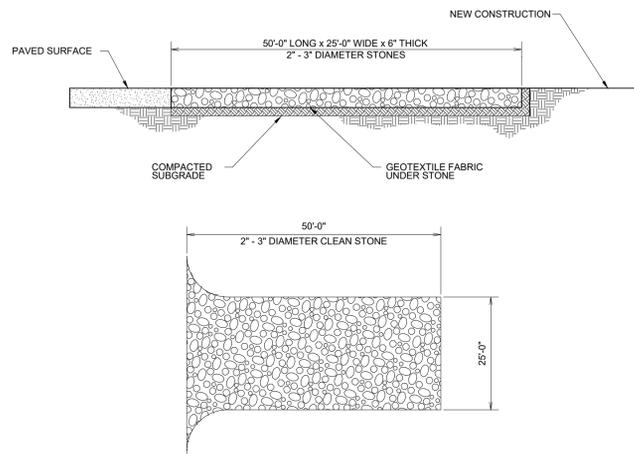


SWPPP PH. 1


SCALE 1" = 50'

**LEGEND**

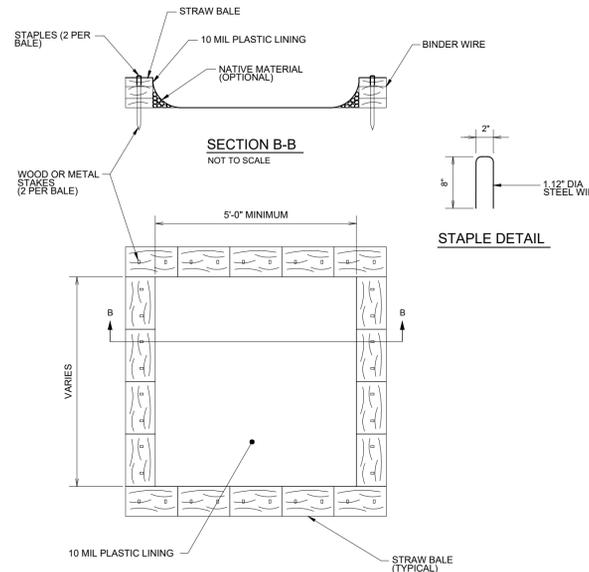
- DISTURBED AREA
- UNDISTURBED AREA
- GRASS SEED
- SEDIMENT FENCE WITH WIRE BACKING
- DRAINAGE DIRECTION



CONSTRUCTION ENTRANCE NOT TO SCALE



CONCRETE WASHOUT NOT TO SCALE

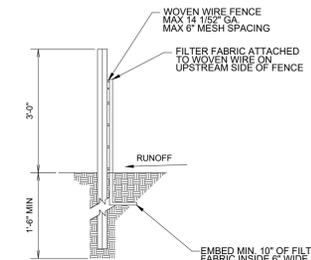


SILT FENCE NOT TO SCALE

**NOTES AND SPECIFICATIONS:**

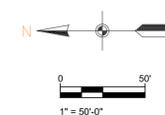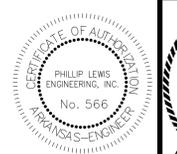
1. POSTS SHALL BE A MINIMUM OF 36 INCHES CONSTRUCTED OF EITHER OF THE FOLLOWING MATERIALS: STEEL 1" OR 1 1/2" TYPE, OR 2" x 2" HARDWOOD.
2. WOVEN WIRE USED AS ADDITIONAL FENCE SUPPORT SHALL BE MINIMUM 14.5 GA. WITH 6" MAXIMUM SPACING.
3. WOVEN WIRE SHALL BE PLACED ALONG THE UPHILL SIDE OF THE FENCE AND FASTENED WITH WIRE TIES OR 1" STAPLES ALONG THE UPHILL SIDE OF THE POSTS.
4. FILTER FABRIC SHALL BE FASTENED TO WOVEN WIRE ACCORDING TO MANUFACTURER'S RECOMMENDATION, OR WITH TIES EVERY 24" AT THE TOP AND MID-SECTIONS.
5. WHERE TWO PIECES OF FILTER FABRIC ADJOIN EACH OTHER THEY SHALL BE OVERLAPPED BY 6 INCHES AND FOLDED TOGETHER.
6. WHERE TWO POSTS MEET TO JOIN FENCE SECTIONS, THE TOPS OF THE POSTS SHALL BE SECURED TOGETHER WITH WIRE.
7. THE FENCE SHALL BE CONSTRUCTED ALONG THE CONTOUR AS MUCH AS POSSIBLE.
8. ENDS OF FENCES SHALL BE EXTENDED UP THE SLOPE TO PREVENT RUNOFF FROM MIGRATING AROUND THE END OF THE FENCE.
9. INSPECTION OF THE FENCE SHALL BE PERFORMED WEEKLY, OR IMMEDIATELY AFTER A RAIN EVENT, OR WHEN BULGES APPEAR IN THE FENCE. ACCUMULATED SILT SHALL NOT BE ALLOWED TO EXCEED HALF THE HEIGHT OF THE FABRIC. REPAIR AND OR REPLACEMENT OF DAMAGED FENCE SHALL BE COMPLETED PROMPTLY.
10. ACCUMULATED SILT SHALL BE REMOVED AND DISPOSED OF IN AN APPROVED SITE IN SUCH A MANNER THAT IT WILL NOT CONTRIBUTE TO OFF-SITE SILTATION.
11. ALL FENCING SHALL BE REMOVED WITH THE CONSTRUCTION SITE IS FULLY STABILIZED SO AS TO NOT IMPEDE STORM FLOW OR DRAINAGE.
12. PRE-FABRICATED UNITS DO NOT REQUIRE THE USE OF WOVEN WIRE FENCE.

**NOTES (GENERAL):**

1. SEE EROSION CONTROL DETAILS IN SWPPP FOR EROSION CONTROL FACILITIES.
2. SEE SWPPP FOR INSTALLATION, MAINTENANCE, INSPECTION, AND RECORD KEEPING REQUIREMENTS.
3. CONTRACTOR SHALL SHOW EROSION CONTROL MEASURE ON SITE MAP.
4. EROSION AND SEDIMENT CONTROL STRUCTURES TO MEET SWPPP DETAILS - APPENDIX D
5. INSTALL ROCK DITCH, CHECK, OR SAND BAG CHECKS AS NECESSARY TO PREVENT SCOUR UNTIL LANDSCAPING IS ESTABLISHED.
6. CONTRACTOR MUST PLACE SEDIMENT BASIN WITH SEDIMENT FENCE OUTLET FOR ANY SEDIMENT CONTAMINATED DEWATERING DISCHARGE.
7. FINAL SLOPE WILL BE SAME DIRECTION AS EXISTING SLOPE.



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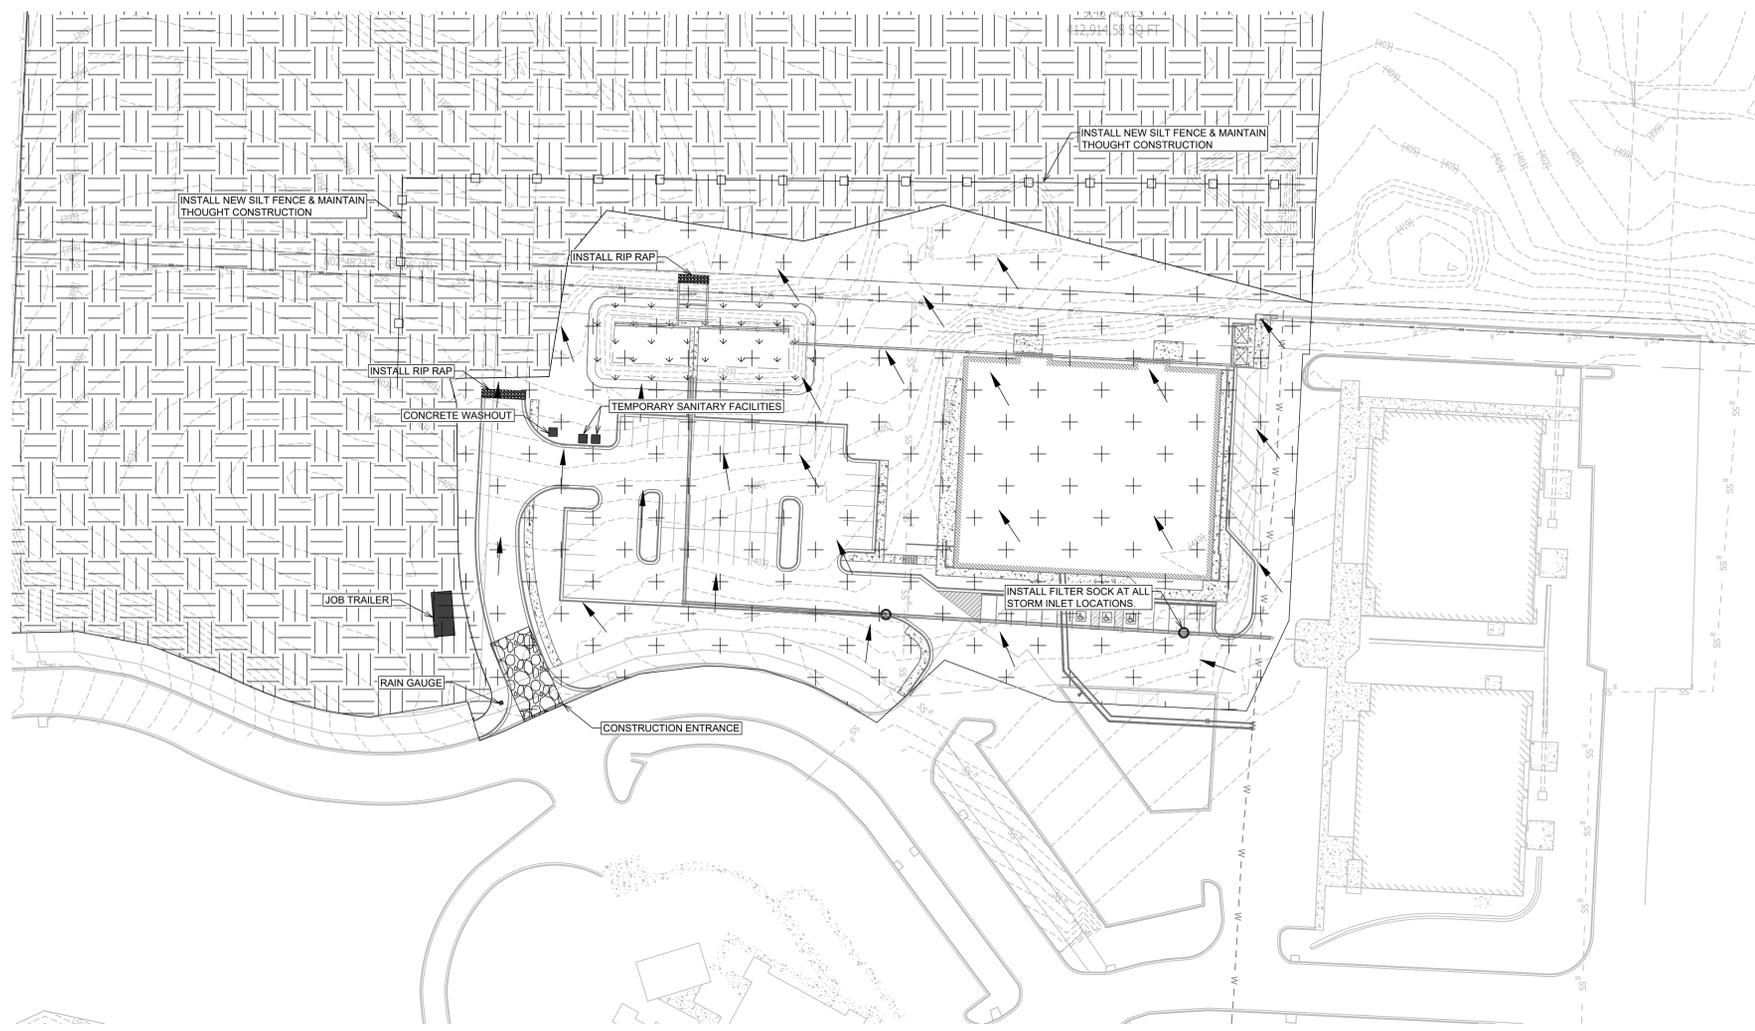
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**SWPPP PH. 2**



SCALE 1" = 50'

**LEGEND**

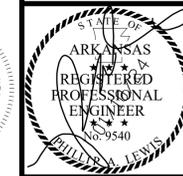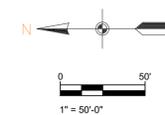-  DISTURBED AREA
-  UNDISTURBED AREA
-  GRASS SEED
-  SEDIMENT FENCE WITH WIRE BACKING
-  DRAINAGE DIRECTION

**NOTES (GENERAL):**

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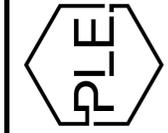
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