		6	0.70014.00		
<b>©</b>	GAS METER	<u> </u>	STORM DRAIN MANHOLE		Constitution of the consti
<b>@</b>	WATER METER	C/0	SEWER CLEANOUT		ASPHALT
-•	GUY WIRE	N	NORTH		
0	POWER/UTILITY POLE	S	SOUTH	4	CONCRETE
T	TELEPHONE PEDESTAL	Е	EAST		4. g. 1 - 1 4
<u>(S)</u>	SEWER MANHOLE	W	WEST		
₩v	WATER VALVE	(M)	AS MEASURED	•	SET 1/2" REBAR w/ CAP #1853
$\ddot{x}$	FIRE HYDRANT	(D)	PER DEED	•	SET COTTON-PICKER SPINDLE
; ;=	SIGNS	(R)	RECORDED	$\circ$	FOUND MONUMENT (DESC. NO
-&-	LIGHT POLE	R/W	RIGHT-OF-WAY	$\triangle$	COMPUTED CORNER (NOT SE
<b>(</b>	TELEPHONE MANHOLE	L.A.	LANDSCAPED AREA		CORRESPONDS TO DRAWING
_	— SANITARY SEWER LINE	CR4	CAPPED 1/2" REBAR		
w	— WATER LINE	CONC.	CONCRETE		
	■ STORM SEWER PIPE	P.O.C.	POINT OF COMMENCEMENT		
	— ROADWAY CENTERLINE	P.O.B.	POINT OF BEGINNING		
	— UTILITY EASEMENT	CMP	CORRUGATED METAL PIPE		
	— BUILDING SETBACK LINE	RCP	REINFORCED CONCRETE PI	PE	
— — RW — — —	— ROADWAY RIGHT-OF-WAY	ESMT	EASEMENT		
- · — OHE — · —	— OVERHEAD ELECTRIC LINES	HDPE	HIGH DENSITY POLYETHYLE	ENE	
UGT	<ul> <li>UNDERGROUND TELEPHONE</li> </ul>	SUBD	SUBDIVISION		
— G —	— UNDERGROUND GAS	FDC	FIRE DEPARTMENT CONNEC	CTION	
- · - F.O · -	— UNDERGROUND FIBER OPTIC	CPS P5	COTTON PICKER SPINDLE 5/8" PIPE		

Vicinity Map

SCALE 1" = 500'

PROJECT LOCATION —

# NEW BEGINNINGS

# HIGHWAY 5 BRYANT, AR


Sheet List Table				
Sheet Number	Sheet Title			
C1.0	COVER SHEET			
C1.1	OVERALL SITE PLAN			
C1.2	ENLARGED SITE PLAN			
C1.3	SITE DETAILS			
C1.4	GRADING PLAN			
C1.5	ENLARGED GRADING PLAN			
C1.6	UTILITY PLAN			
C1.7	UTILITY PROFILES			
C1.8	UTILITY DETAILS I			
C1.9	UTILITY DETAILS II			
C1.10	PRE-DEV DRAINAGE			
C1.11	POST-DEV DRAINAGE			
C1.12	LANDSCAPE PLAN			
C1.13	SWPPP			



OCCURRING TO ANY PROPERTY DURING THE CONSTRUCTION OF THIS PROJECT. SAID CONTRACTOR SHALL TAKE ALL NECESSARY PRECAUTIONS TO PREVENT PROPERTY DAMAGE.

GENERAL CONSTRUCTION NOTES


- B. IN ACCORDANCE WITH GENERALLY ACCEPTED CONSTRUCTION PRACTICES, THE CONTRACTOR WILL SOLELY AND COMPLETELY BE RESPONSIBLE FOR CONDITIONS OF THE JOB SITE, INCLUDING SAFETY WORK. THIS REQUIREMENT WILL APPLY CONTINUOUSLY AND WILL NOT BE LIMITED TO NORMAL WORKING
- C. THE DUTY OF THE LOCAL UTILITY PROVIDER TO CONDUCT CONSTRUCTION INSPECTION REVIEWS OF THE CONTRACTOR'S PERFORMANCE IS NOT AN INSPECTION OR REVIEW OF THE ADEQUACY OF THE CONTRACTOR'S SAFETY MEASURES IN, ON, OR NEAR THE CONSTRUCTION SITE.
- D. ALL WATER AND SEWER IMPROVEMENTS SHALL BE CONSTRUCTED IN ACCORDANCE WITH THE LATEST REVISION TO THE LOCAL PROVIDER'S WATER AND WASTEWATER (SANITARY SEWER) STANDARD SPECIFICATIONS.
- E. THE CONTRACTOR IS SPECIFICALLY CAUTIONED THAT THE LOCATION AND/OR ELEVATION OF EXISTING UTILITIES AS SHOWN ON THESE PLANS IS BASED ON RECORDS OF THE VARIOUS UTILITY COMPANIES AND, WHERE POSSIBLE, MEASUREMENTS TAKEN IN THE FIELD. THE INFORMATION IS NOT TO BE RELIED ON AS BEING EXACT OR COMPLETE. THE CONTRACTOR MUST CALL THE APPROPRIATE UTILITY COMPANY AT LEAST 48 HOURS BEFORE ANY EXCAVATION TO REQUEST EXACT FIELD LOCATION OF ALL UTILITIES. IT SHALL BE THE RESPONSIBILITY OF THE CONTRACTOR TO LOCATE ALL EXISTING UTILITIES WHICH CONFLICT WITH PROPOSED IMPROVEMENTS SHOWN ON THE PLAN.
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- G. PRIOR TO INSTALLATION OF ANY UTILITIES, THE CONTRACTOR IS TO EXCAVATE, VERIFY AND CALCULATE ALL CROSSINGS AND INFORM ANY AND ALL UTILITIES OF ANY CONFLICTS PRIOR TO CONSTRUCTION.
- H. CONSTRUCTION SHALL NOT START ON ANY WATER UTILITY TIE-INS UNTIL APPROVAL IS GIVEN BY THE LOCAL UTILITY PROVIDER. SAID CONTRACTOR SHALL NOT OPERATE ANY VALVE, HYDRANT, OR WATER UTILITY APPURTENANCE NOR SHALL HE ATTACH TO OR TAP ANY WATER UTILITY MAIN WITHOUT APPROVAL. THE CONTRACTOR SHALL BEAR THE COST AND CONSEQUENCE OF ANY DISRUPTION OF UTILITY OPERATION CAUSED BY CONSTRUCTION.
- FIBER OPTIC CABLE ON AND/OR ADJACENT TO THIS SITE WERE NOT LOCATED BY THE SURVEY AND ARE NOT SHOWN. IT IS THE RESPONSIBILITY OF THE CONTRACTOR TO LOCATE ANY FIBER OPTIC CABLES ASSOCIATED WITH THIS SITE AND TAKE ALL NECESSARY AND REQUIRED PRECAUTIONS TO PROTECT ANY EXISTING FIBER OPTIC CABLES. CONTRACTORS SHALL COORDINATE ALL EFFORTS WITH OWNER OF FIBER OPTIC CABLES OR THEIR DESIGNATED REPRESENTATIVE.
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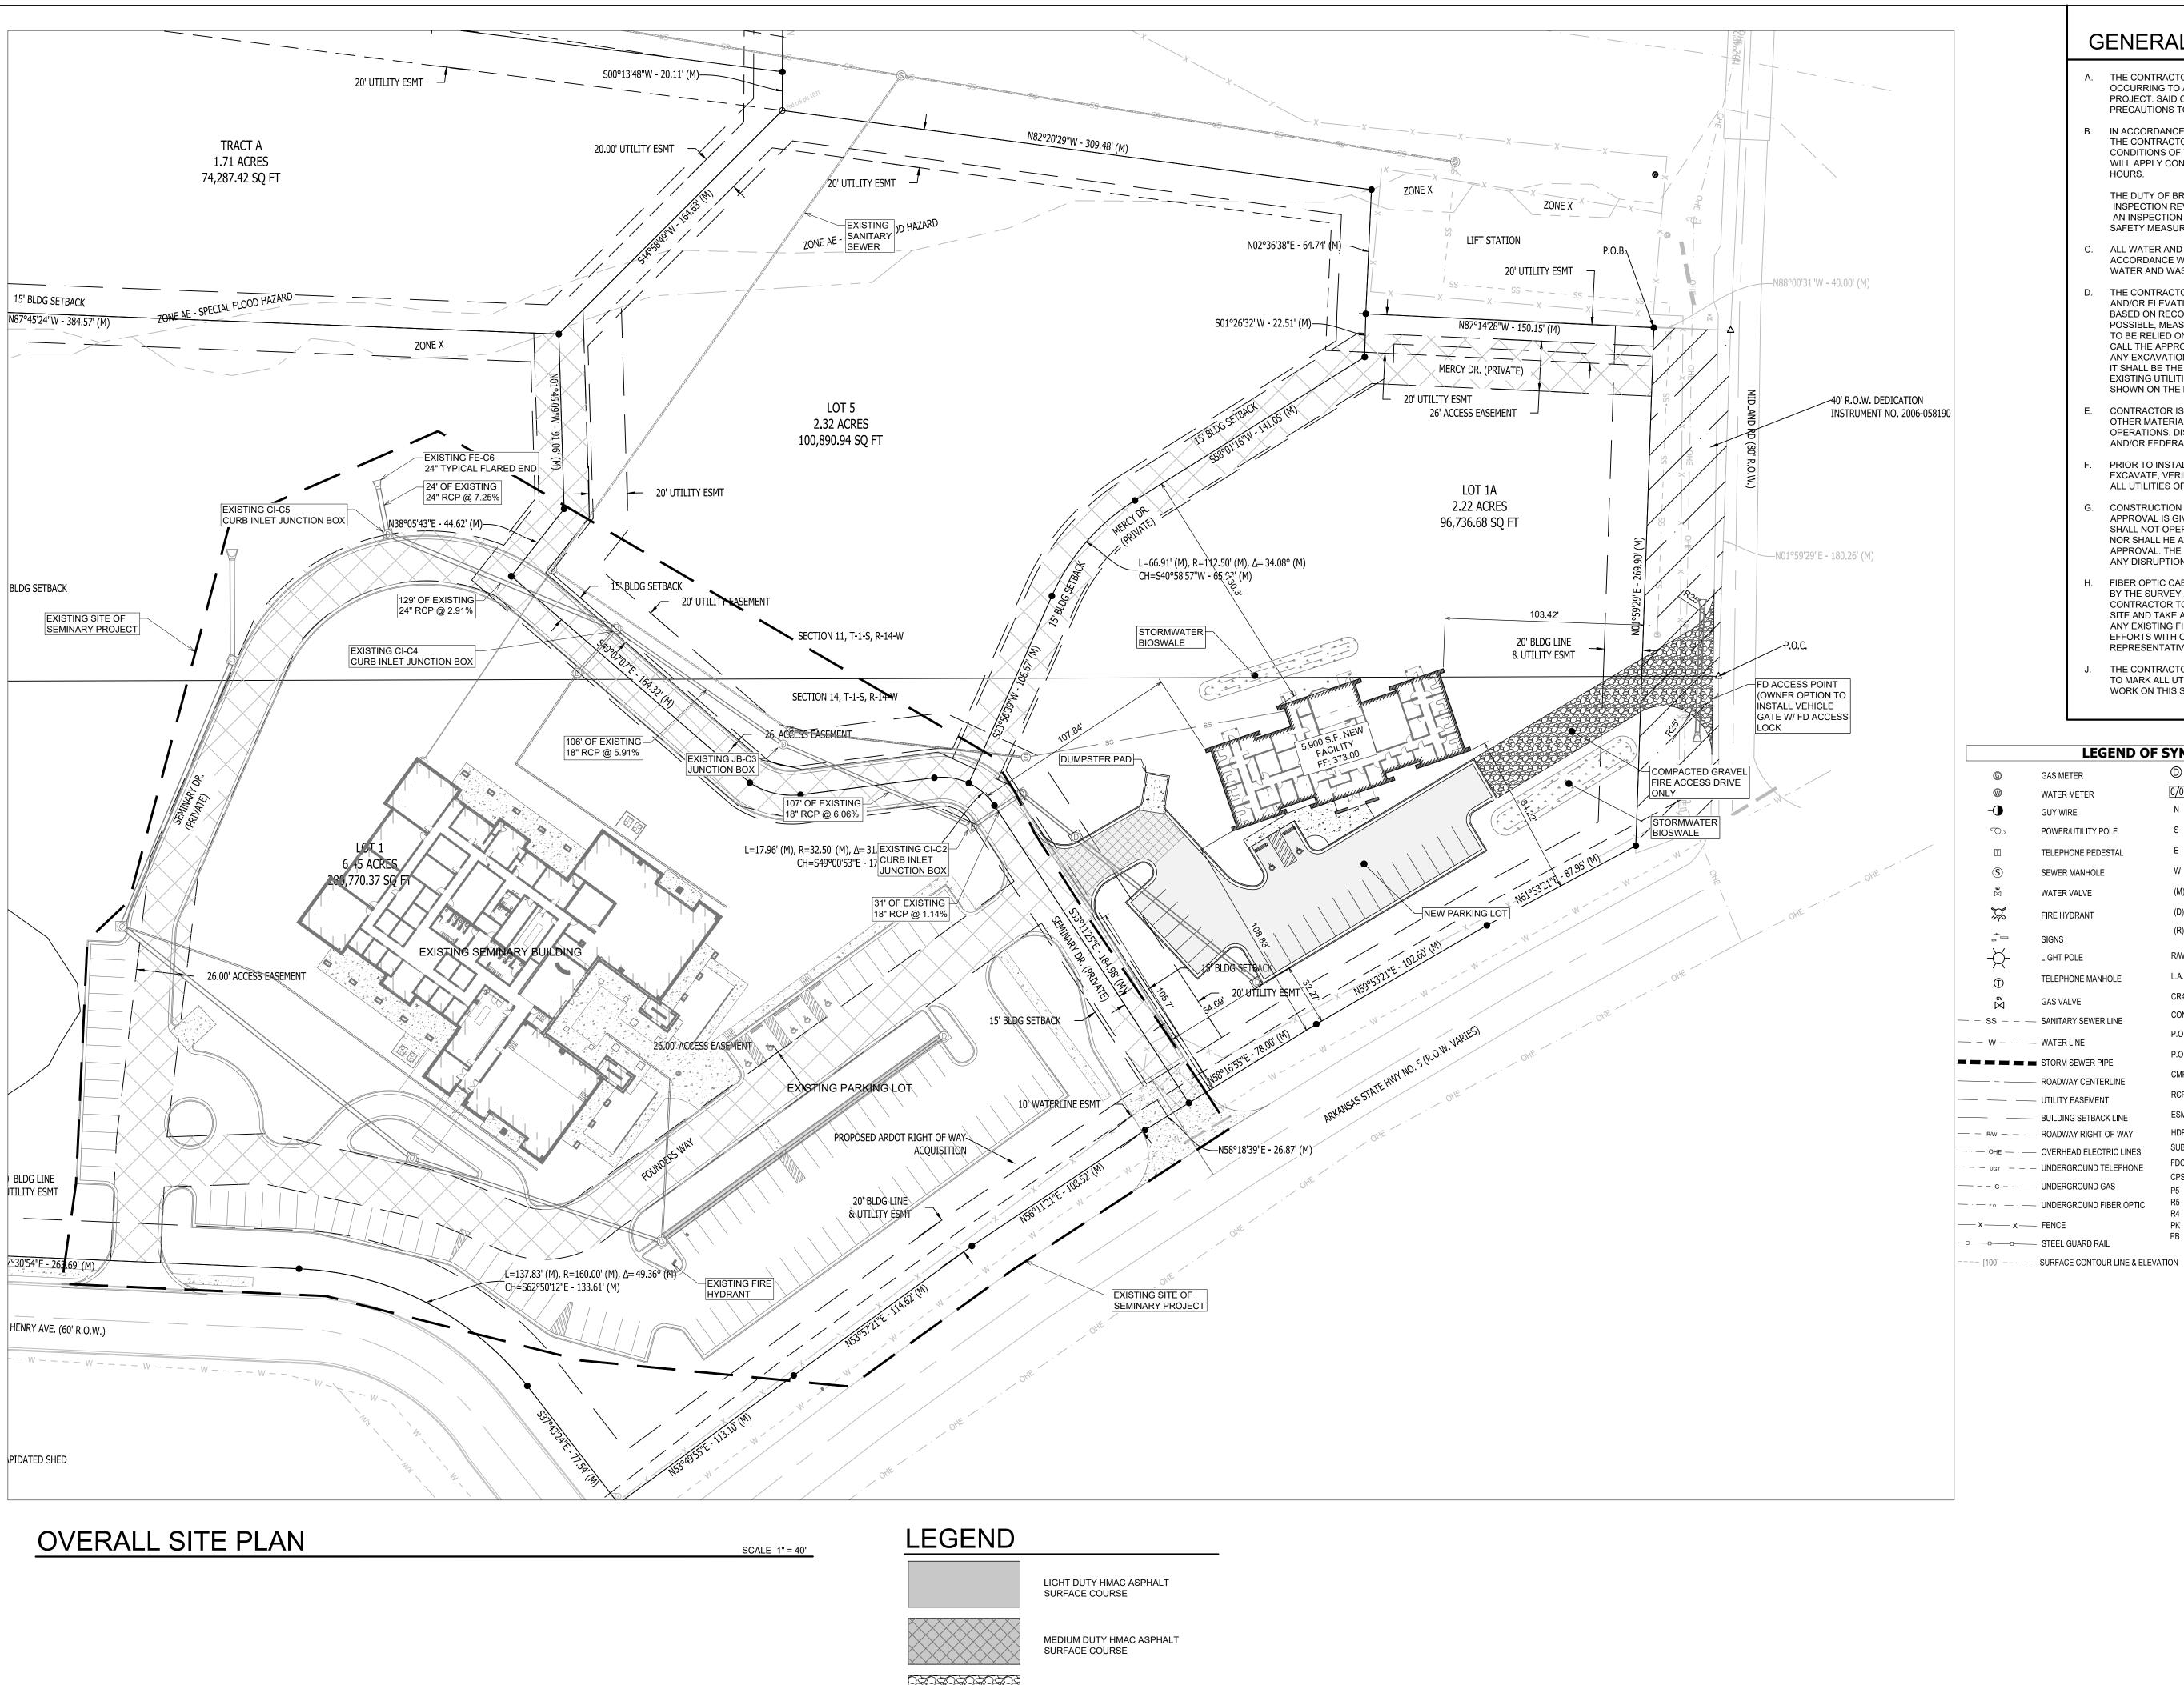
DEVIATIONS/VARIANCES

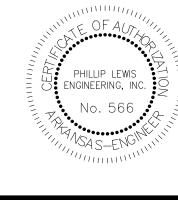

PHILLIP LEWIS ENGINEERING, INC.

Structural + Civil Consultants

23620 Interstate 30 | Bryant, Arkansas PH: 501-350-9840

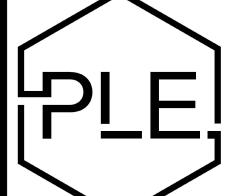

MEDIUM DUTY HMAC ASPHALT

SURFACE COURSE

#### **GENERAL CONSTRUCTION NOTES**

- A. THE CONTRACTOR WILL BE HELD SOLELY RESPONSIBLE FOR DAMAGES OCCURRING TO ANY PROPERTY DURING THE CONSTRUCTION OF THIS PROJECT. SAID CONTRACTOR SHALL TAKE ALL NECESSARY PRECAUTIONS TO PREVENT PROPERTY DAMAGE.
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ENGINEERING,

LEWIS

PHILLIP

REVISION:

THE DUTY OF BRYANT TO CONDUCT CONSTRUCTION INSPECTION REVIEWS OF THE CONTRACTOR'S PERFORMANCE IS NOT AN INSPECTION OR REVIEW OF THE ADEQUACY OF THE CONTRACTOR'S

SAFETY MEASURES IN, ON, OR NEAR THE CONSTRUCTION SITE. C. ALL WATER AND SEWER IMPROVEMENTS SHALL BE CONSTRUCTED IN

ACCORDANCE WITH THE LATEST REVISION TO THE CITY OF BRYANT'S

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#### I ECEND OF CYMROLS & ARRDEVIATIONS

LEGEND OF SYMBOLS & ABBREVIATIONS							
<b>©</b>	GAS METER	<b>(D)</b>	STORM DRAIN MANHOLE				
<b>@</b>	WATER METER	C/0	SEWER CLEANOUT				
-•	GUY WIRE	N	NORTH				
O	POWER/UTILITY POLE	S	SOUTH				
Ī	TELEPHONE PEDESTAL	Е	EAST				
<u>\$</u>	SEWER MANHOLE	W	WEST				
wv ⊠	WATER VALVE	(M)	AS MEASURED	•	SET 1/2" REBAR w/ CAP #1853		
*	FIRE HYDRANT	(D)	PER DEED	•	SET COTTON-PICKER SPINDLE		
<u>.</u>	SIGNS	(R)	RECORDED	$\circ$	FOUND MONUMENT (DESC. NOTED		
<del>-</del> >	LIGHT POLE	R/W	RIGHT-OF-WAY	$\triangle$	COMPUTED CORNER (NOT SET)		
(T)	TELEPHONE MANHOLE	L.A.	LANDSCAPED AREA				
gv ⊠	GAS VALVE	CR4	CAPPED 1/2" REBAR				
- SS	— SANITARY SEWER LINE	CONC.	CONCRETE				
- w	— WATER LINE	P.O.C.	POINT OF COMMENCEMENT				
	■ STORM SEWER PIPE	P.O.B.	POINT OF BEGINNING				
	— ROADWAY CENTERLINE	CMP	CORRUGATED METAL PIPE				
	— UTILITY EASEMENT	RCP	REINFORCED CONCRETE PIPE				
	— BUILDING SETBACK LINE	ESMT	EASEMENT				
- R/W	— ROADWAY RIGHT-OF-WAY	HDPE	HIGH DENSITY POLYETHYLENE				
— ОНЕ — · —	— OVERHEAD ELECTRIC LINES	SUBD	SUBDIVISION				
_ uct	— LINDERGROUND TELEPHONE	FDC	FIRE DEPARTMENT CONNECTION				

COTTON PICKER SPINDLE


1/2" REBAR SURVEY NAIL TELEPHONE PULL BOX


07-24-2025

OVERALL SITE PLAN


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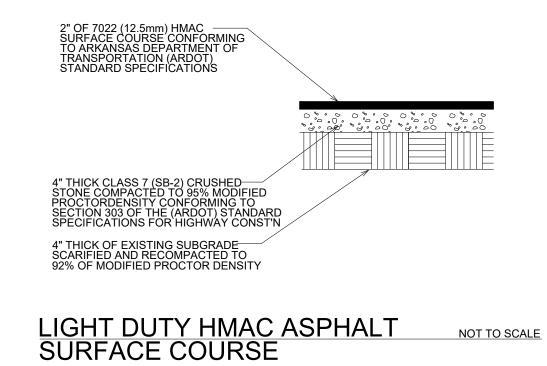
C1.1




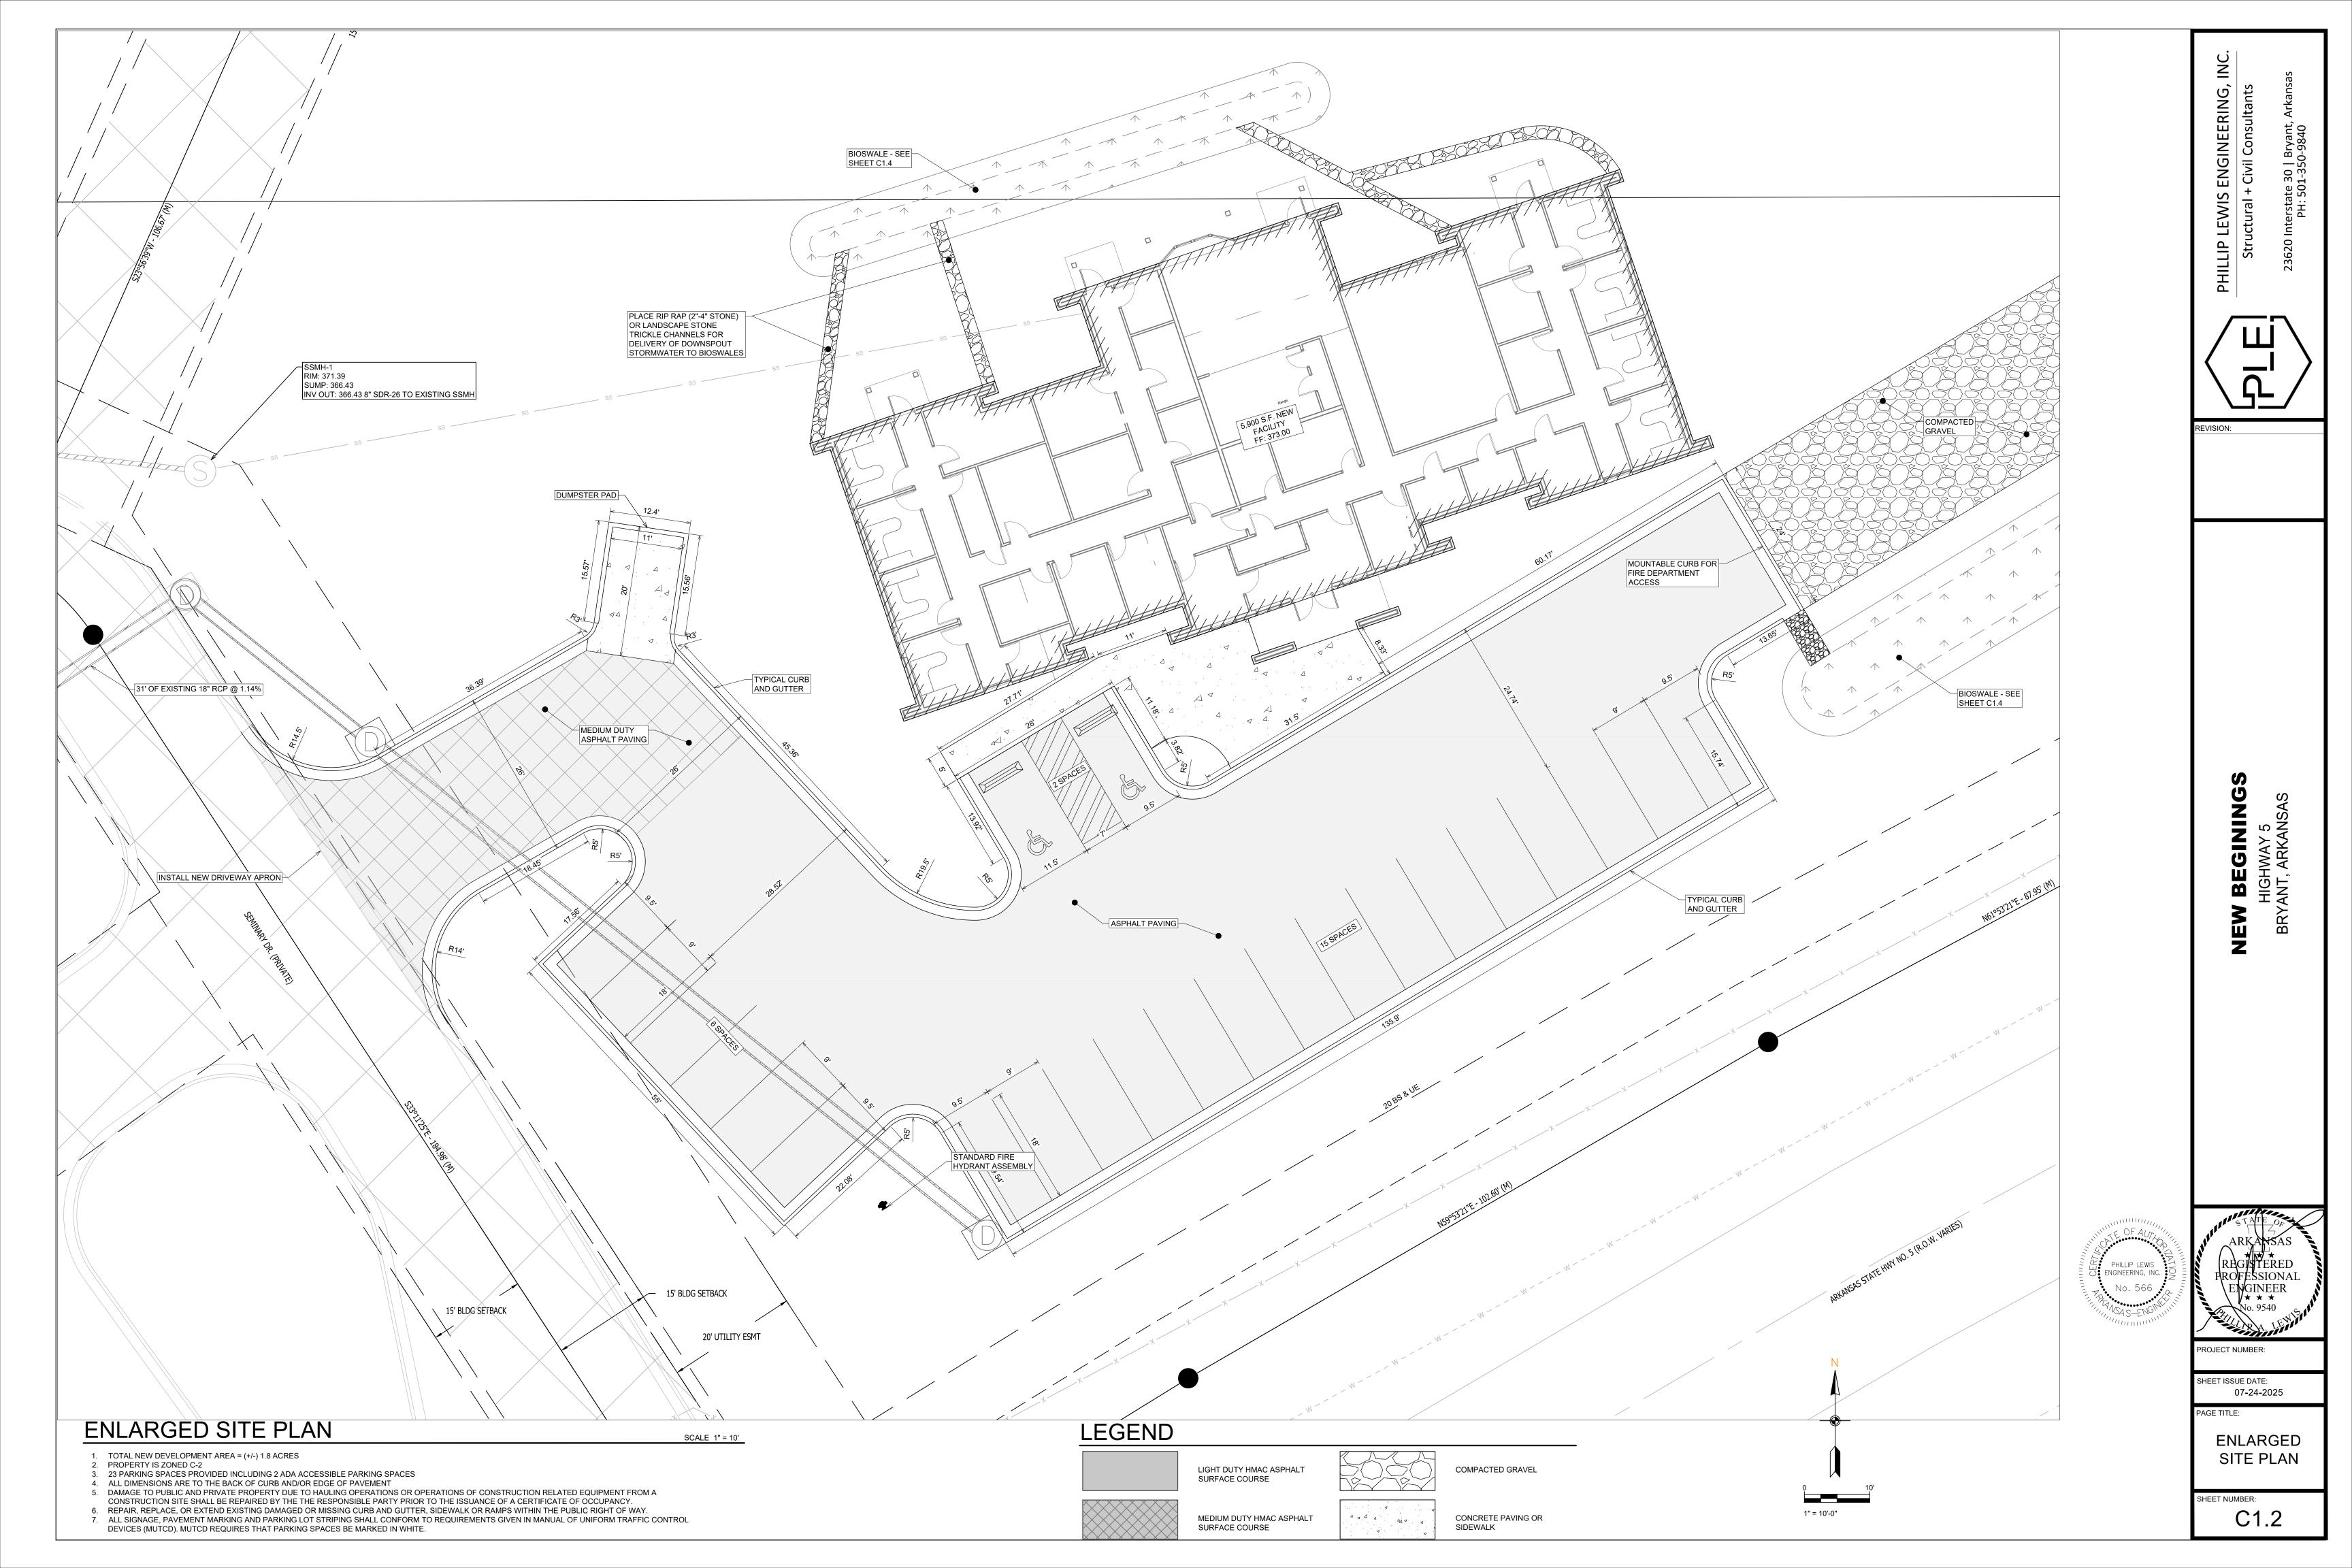


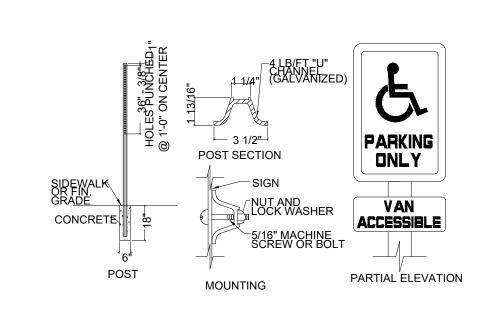




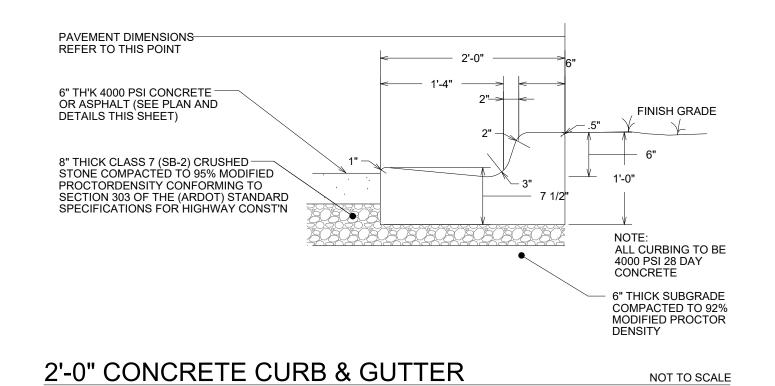

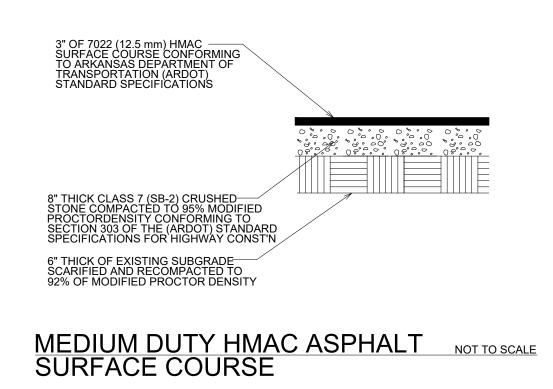

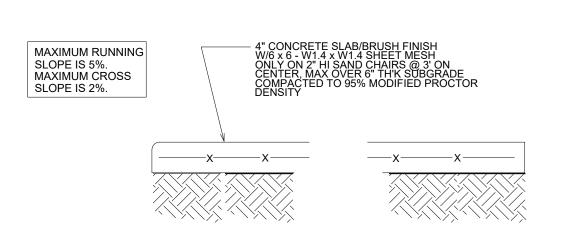




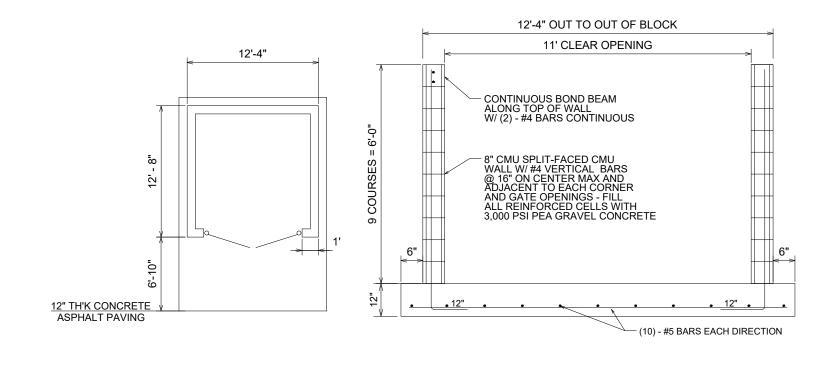

DUMPSTER PAD/ENCLOSURE DETAIL





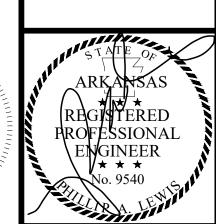

LEWIS ENGINEERING,

PHILLIP

REVISION:

NGS


NEW


IEW BEGININ HIGHWAY 5 BRYANT, ARKANS,

07-24-2025

SITE **DETAILS** 

SHEET NUMBER: C1.3

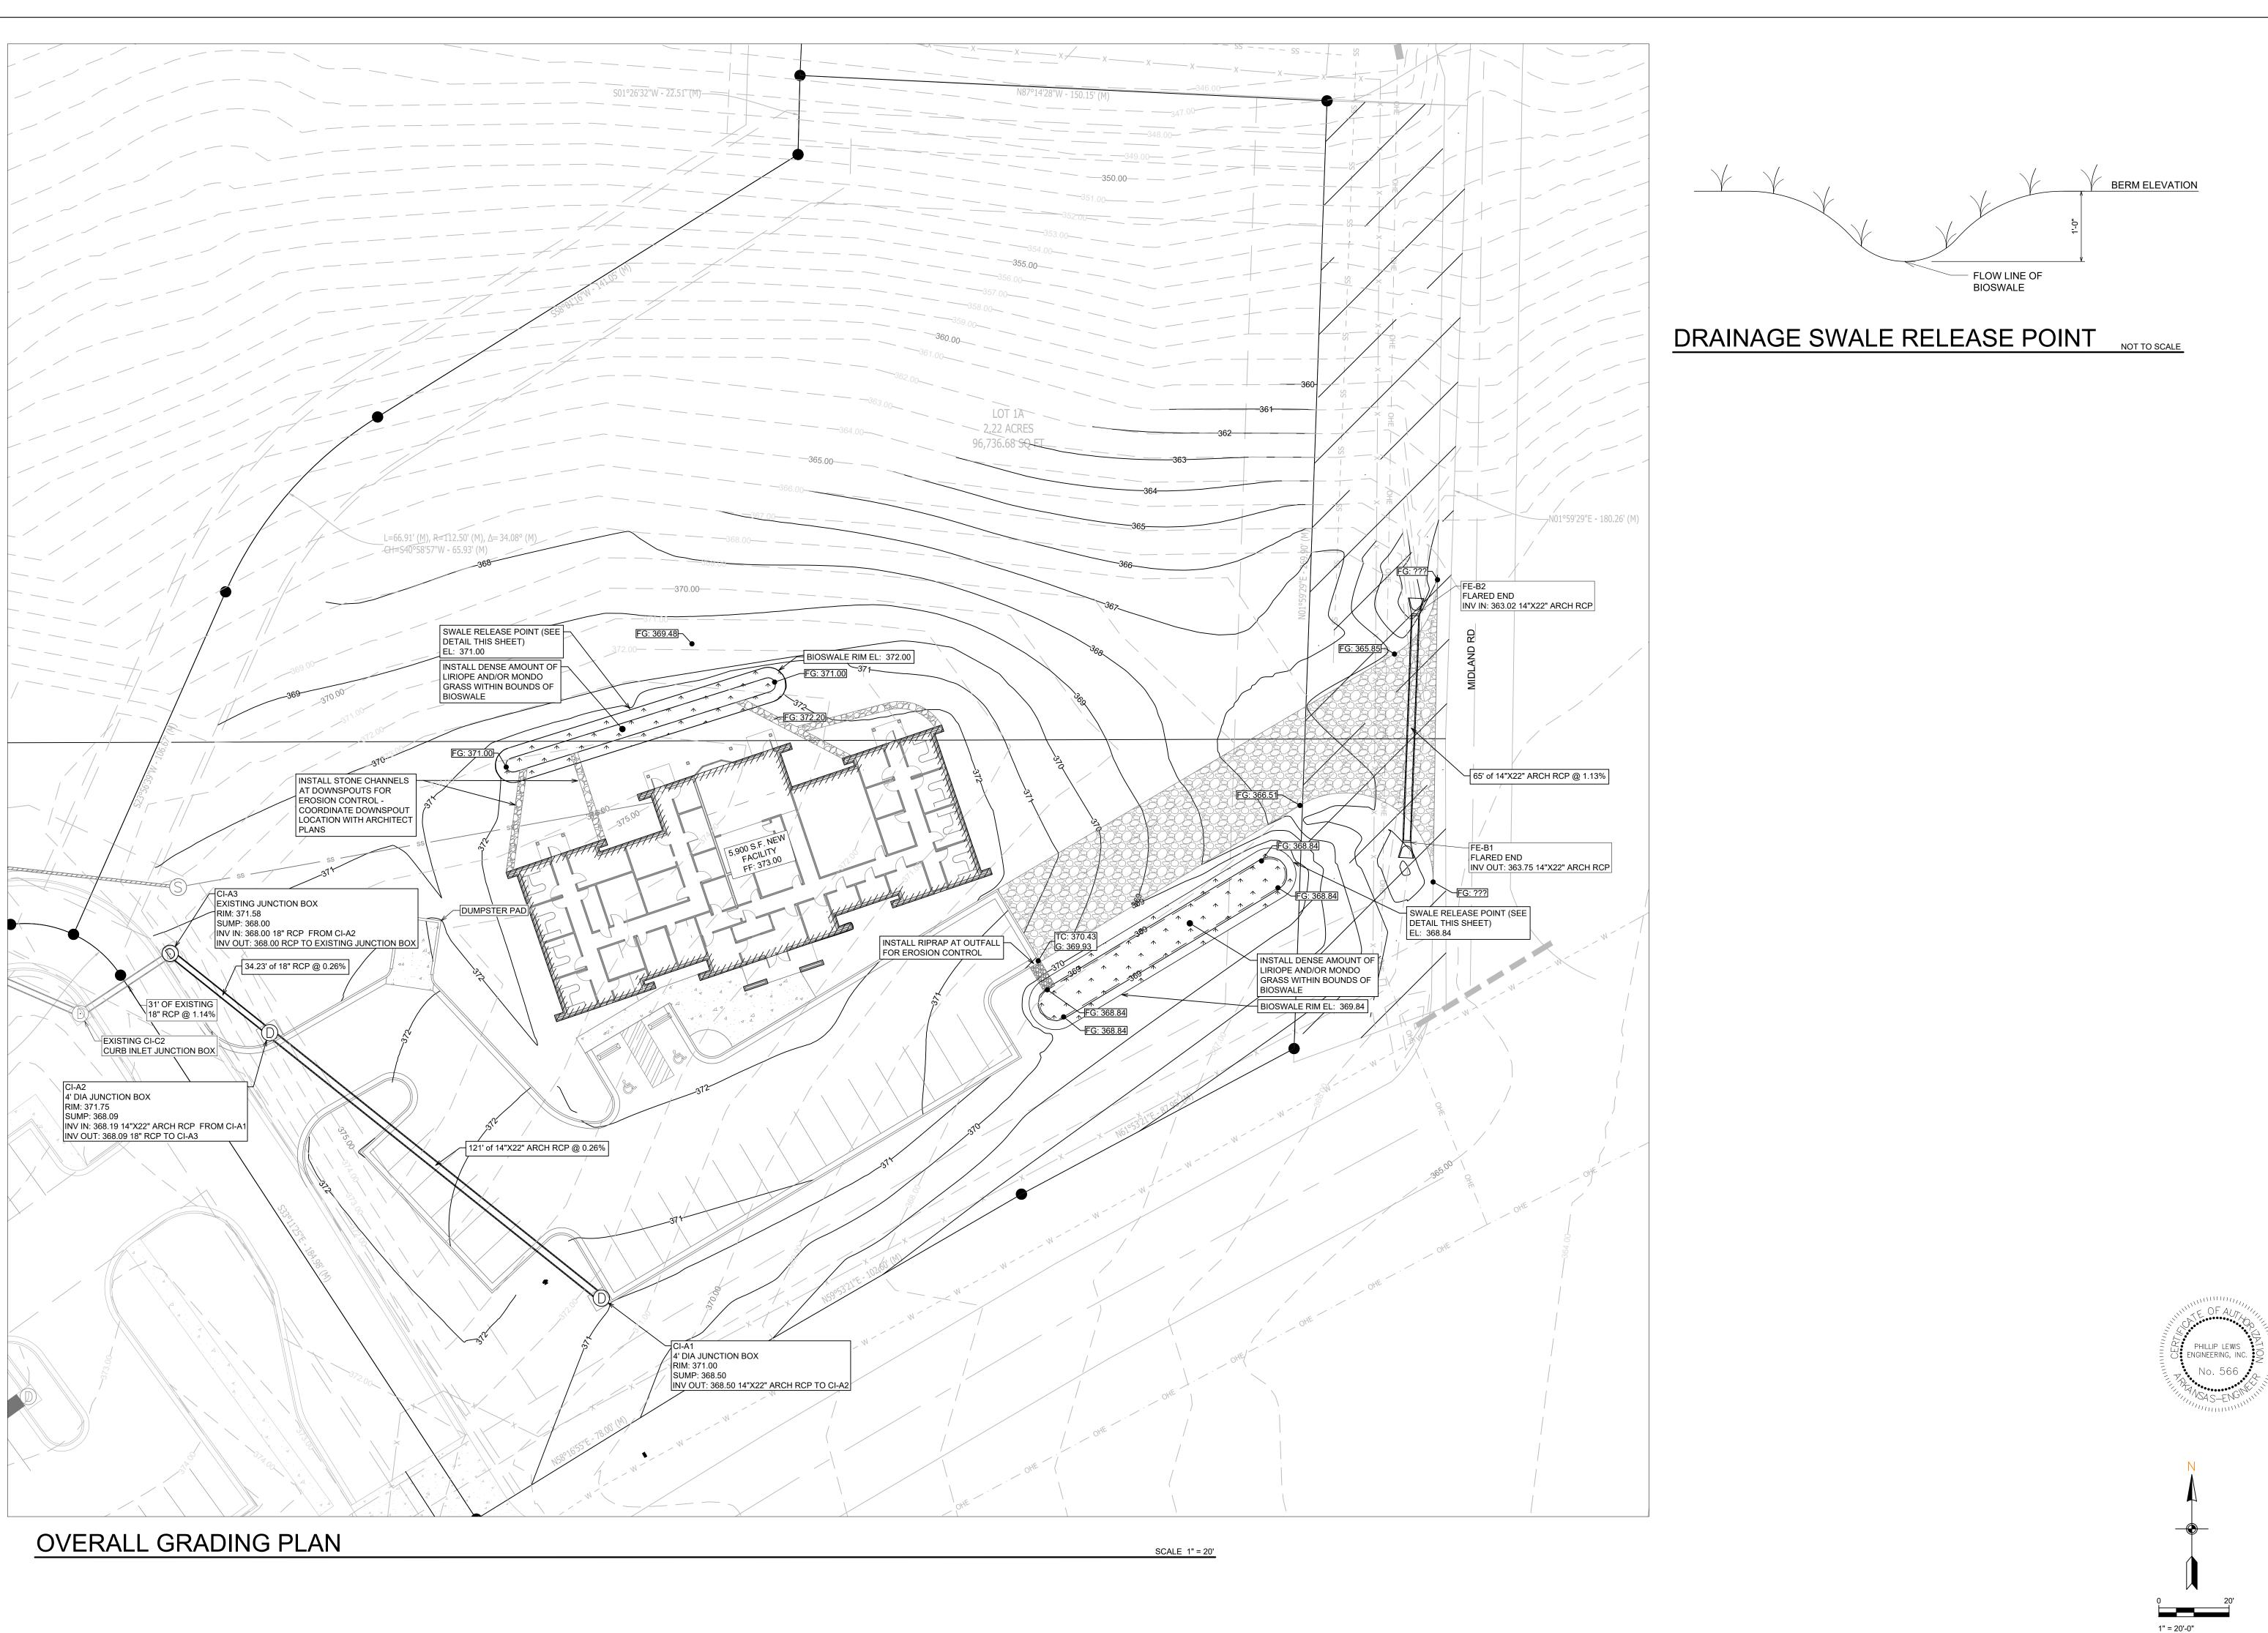

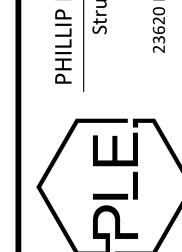

EVISION:

HIGHWAY 5 RYANT, ARKANSAS

REGISTEREI
PROFESSION
ENGINEER
No. 9540


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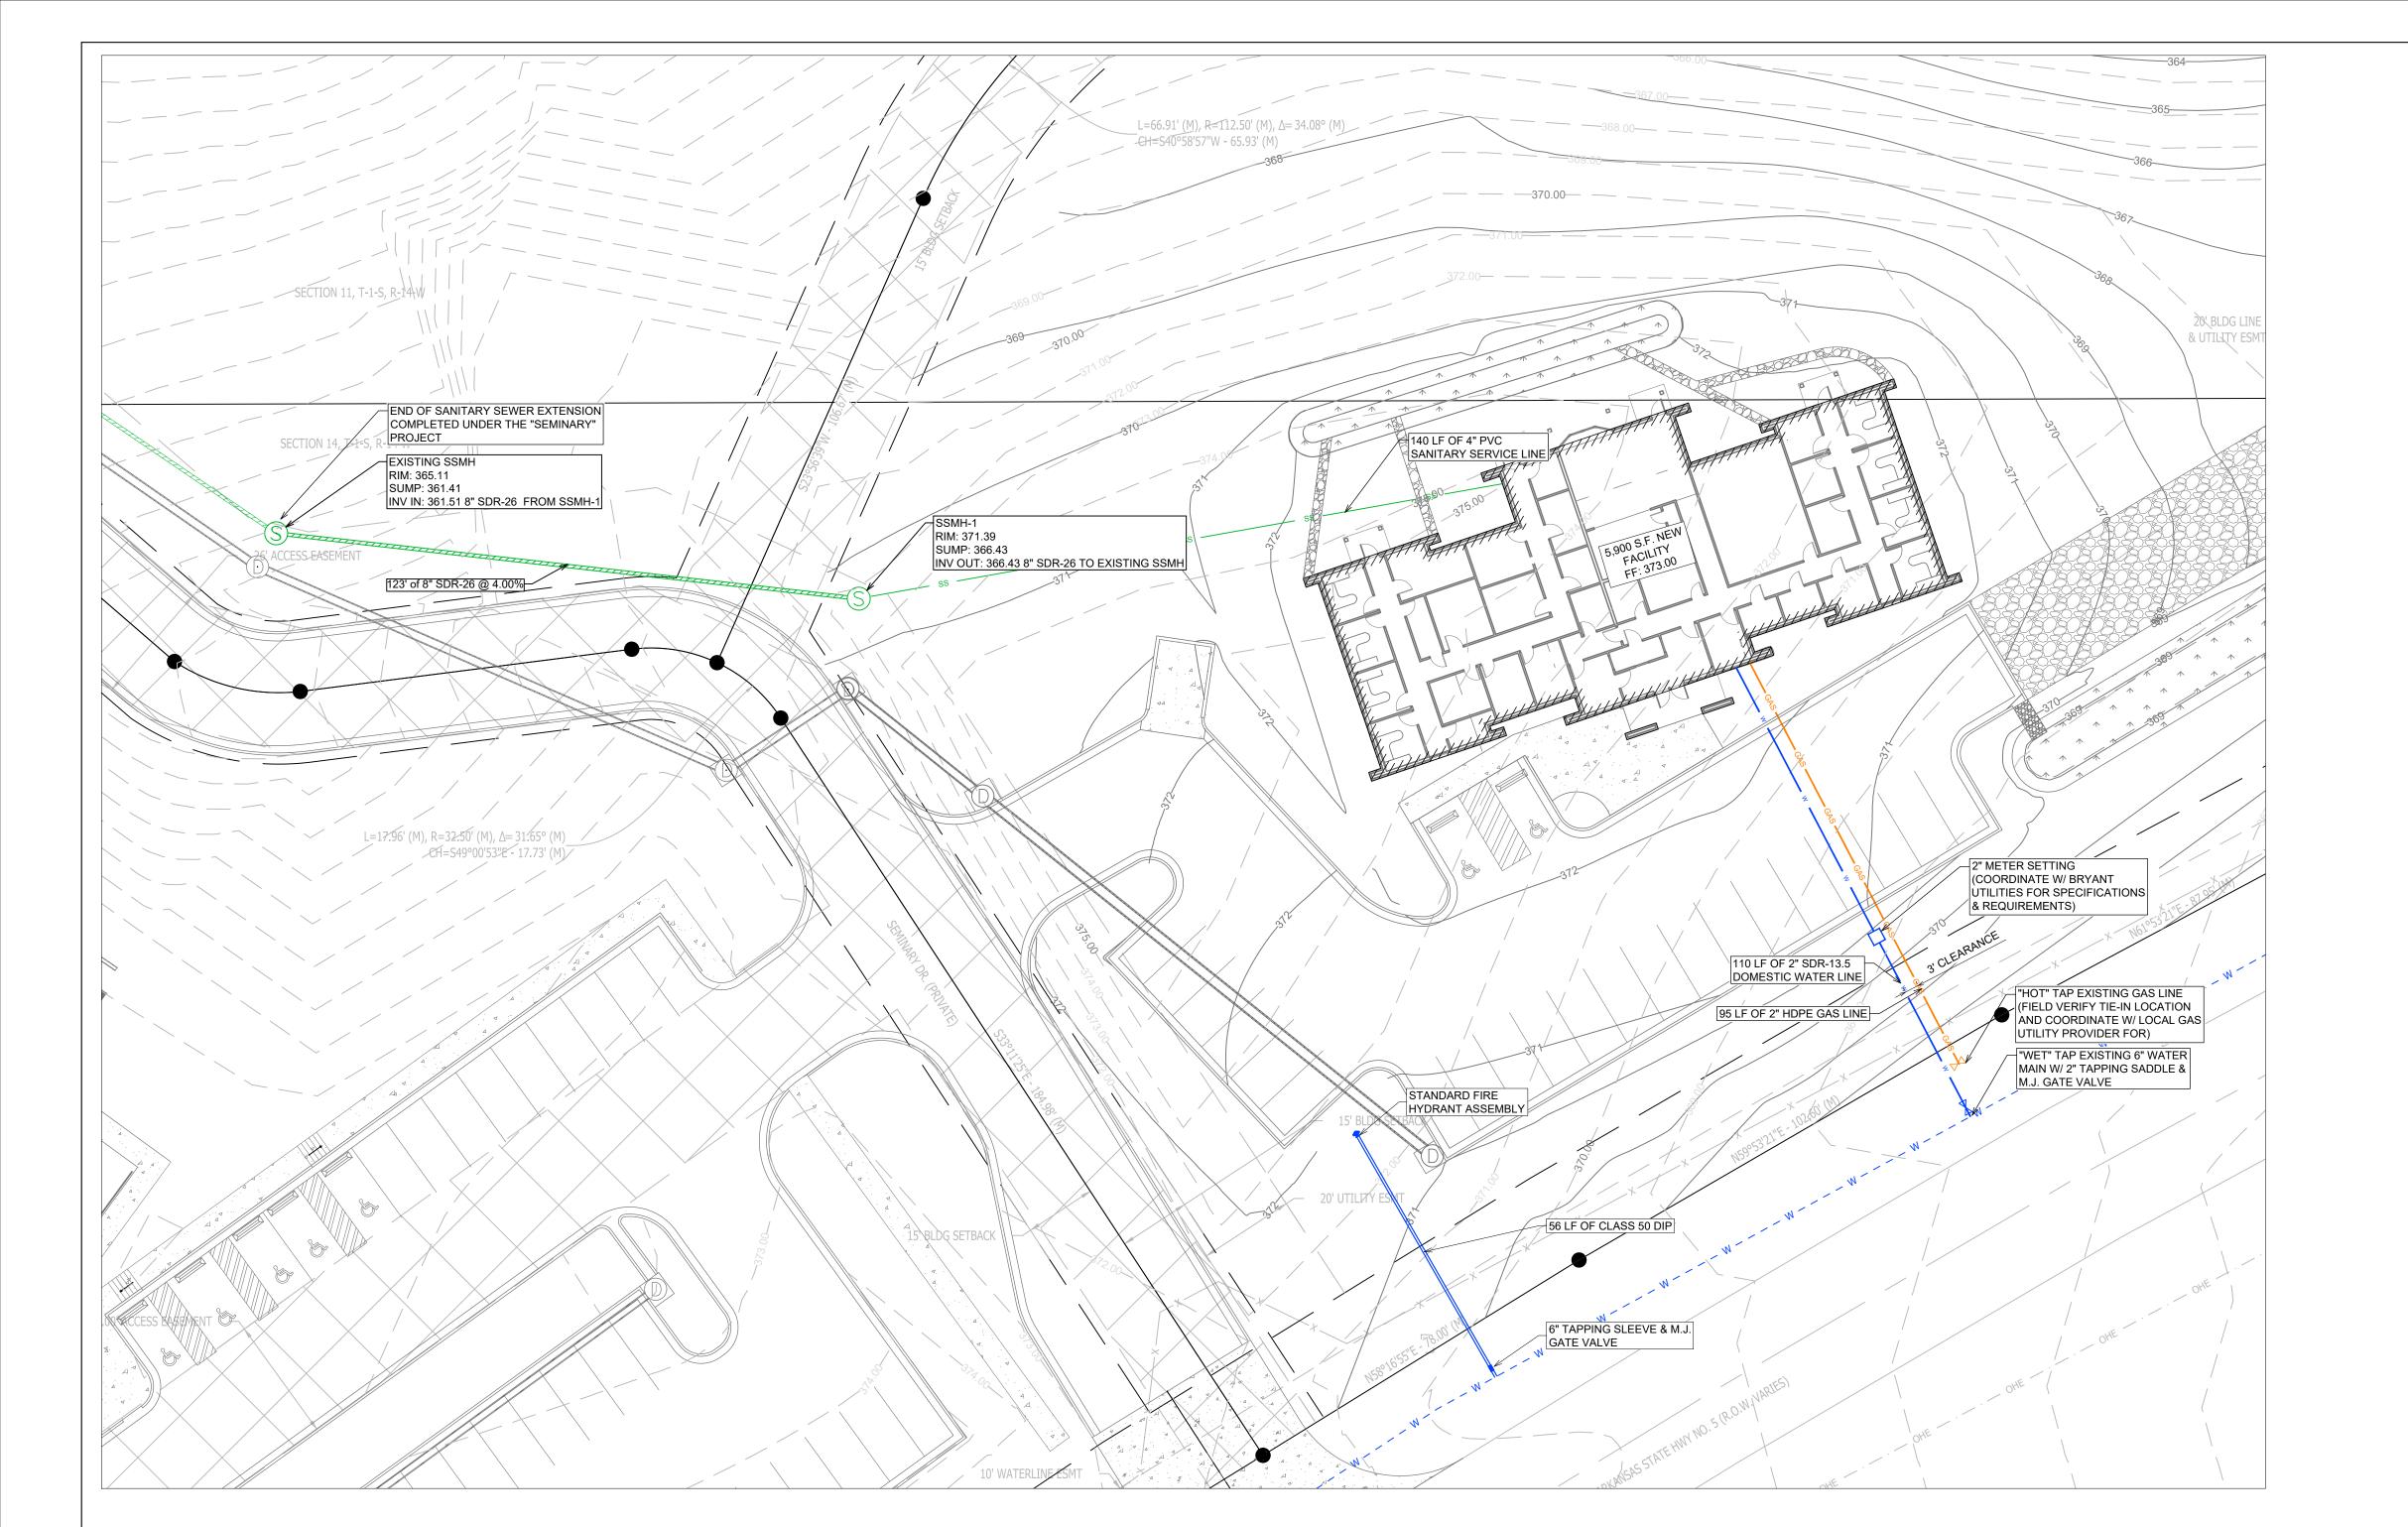
SHEET ISSUE DATE: 07-24-2025

07-24-2025
PAGE TITLE:

GRADING PLAN


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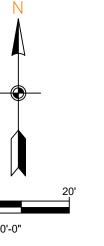
IEW BEGININ HIGHWAY 5 BRYANT, ARKANS,

07-24-2025

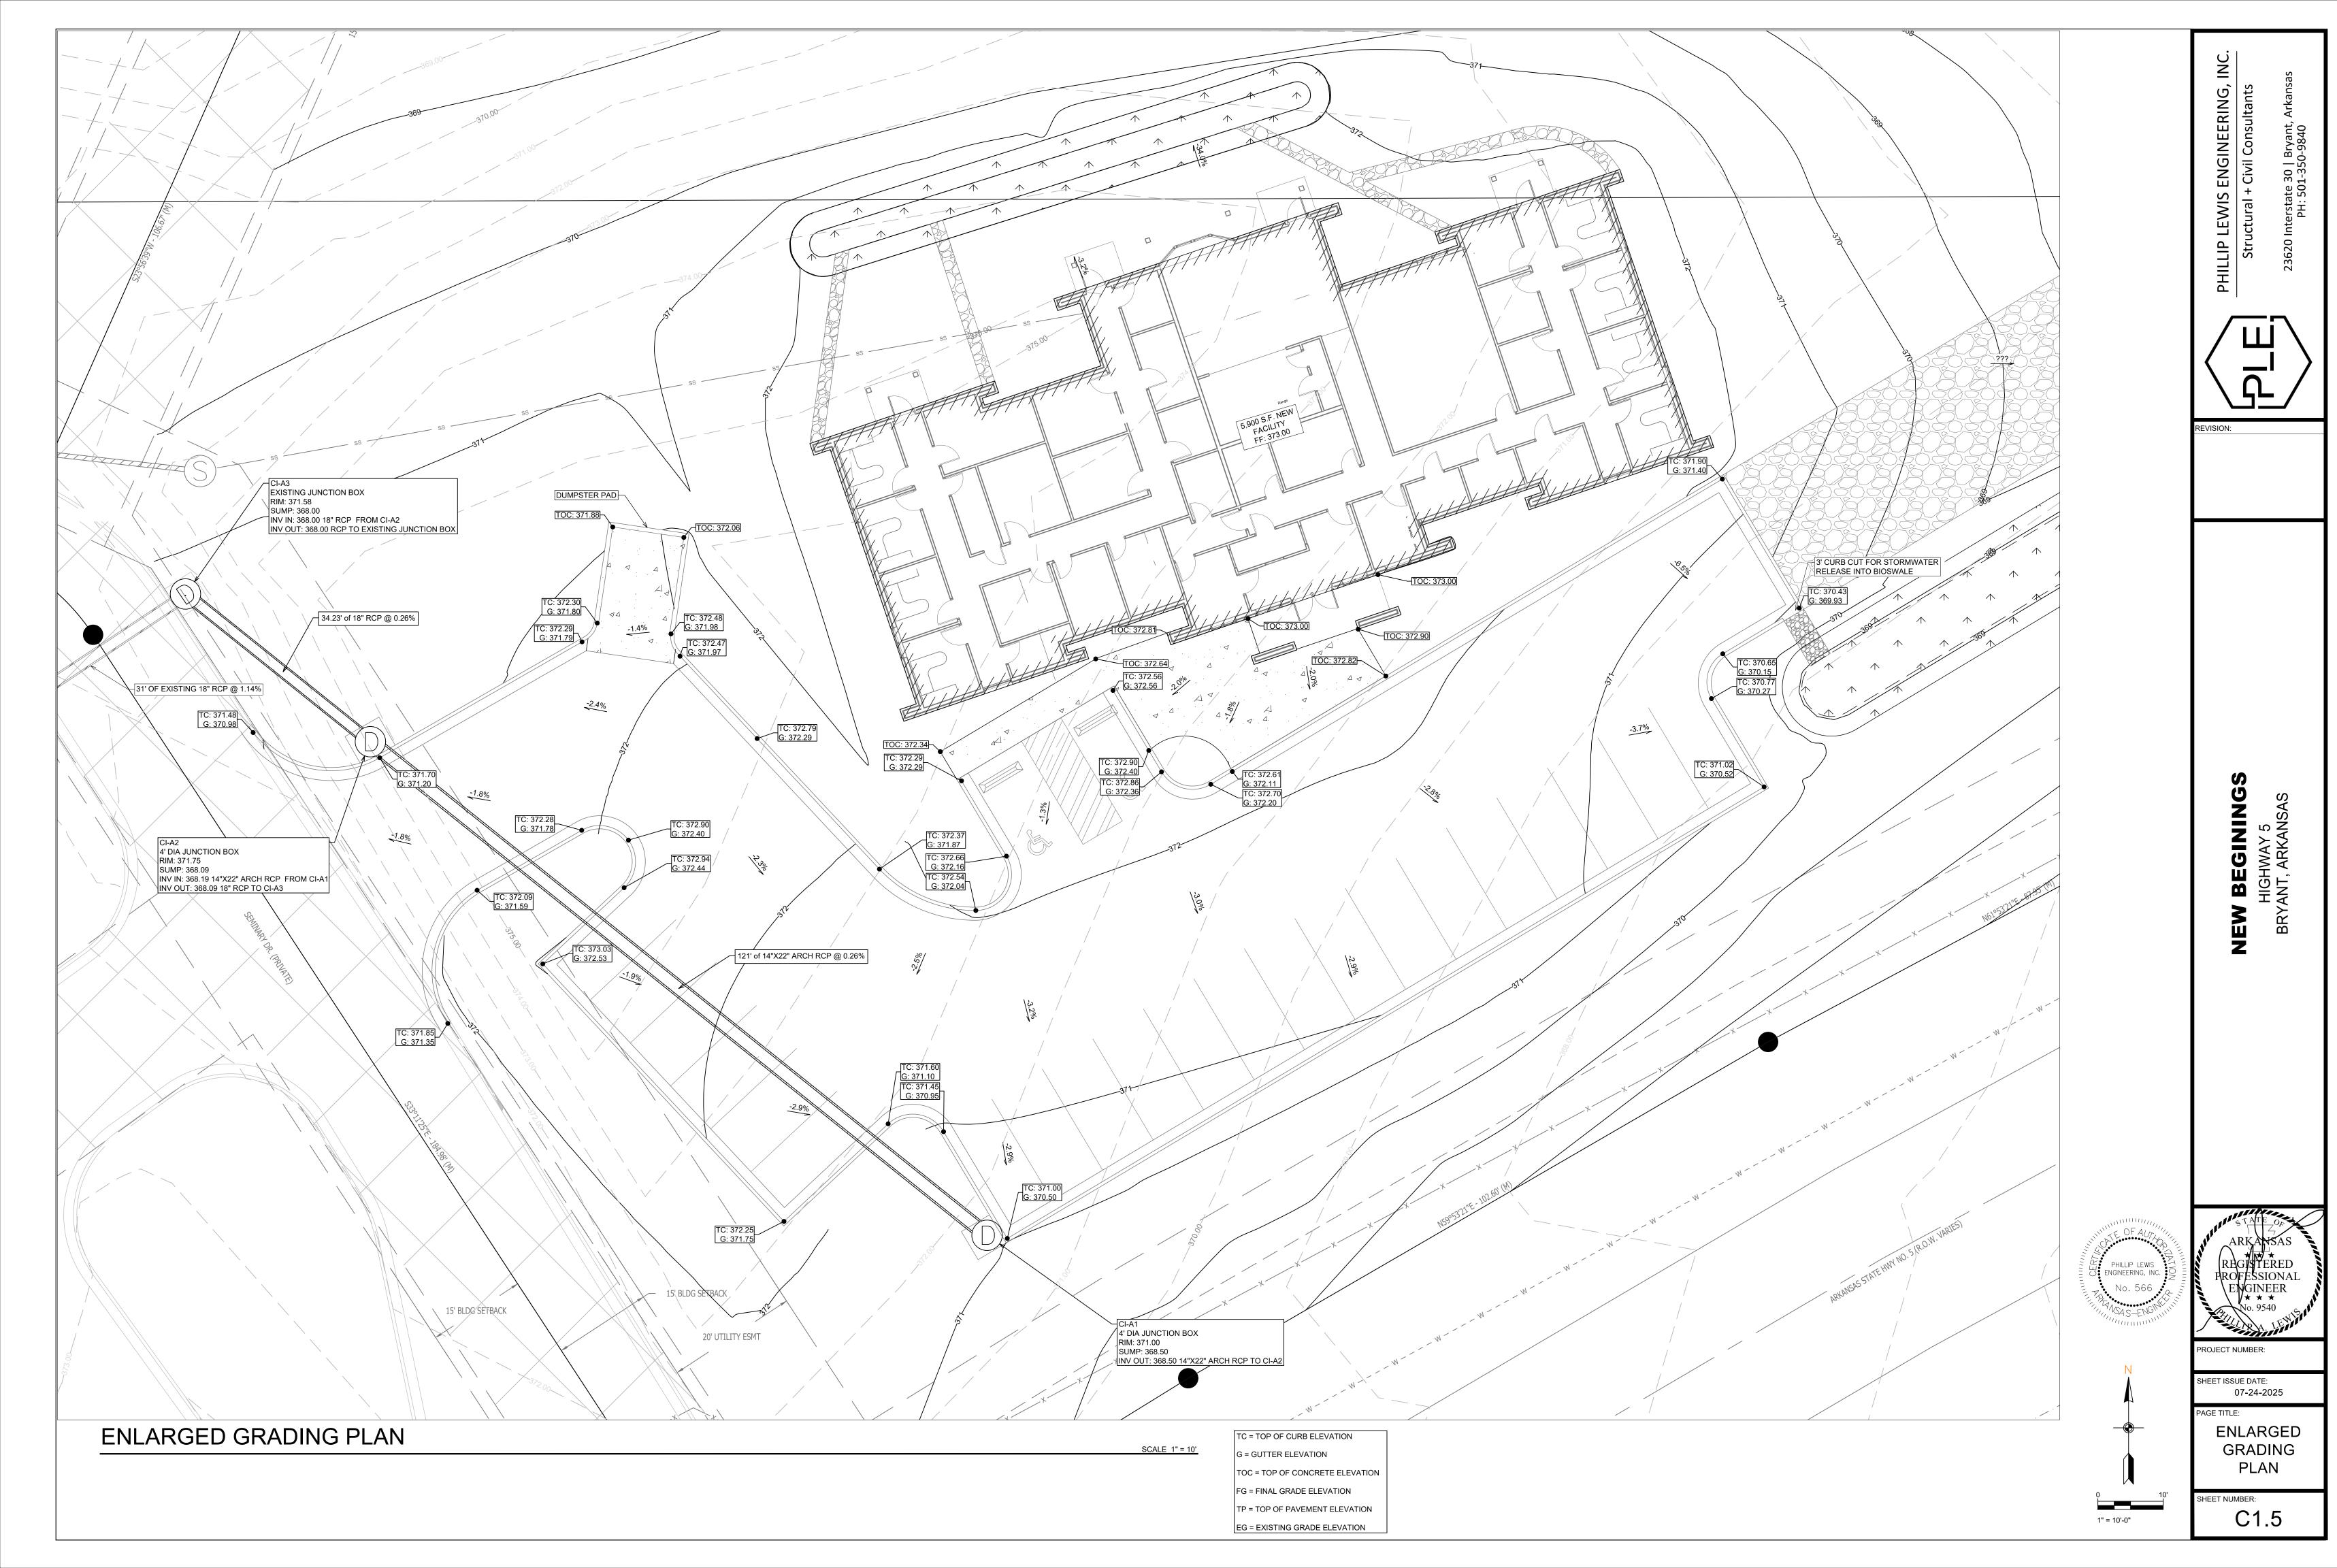UTILITY PLAN

SHEET NUMBER: C1.6



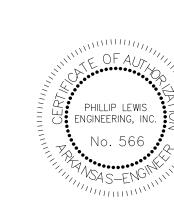

UTILITY PLAN

SCALE 1" = 20'

ENGINEERING, + Civil Consultants

LEWIS


PHILLIP

REVISION:


PRECAUTIONS TO PREVENT PROPERTY DAMAGE.


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## STORM SEWER

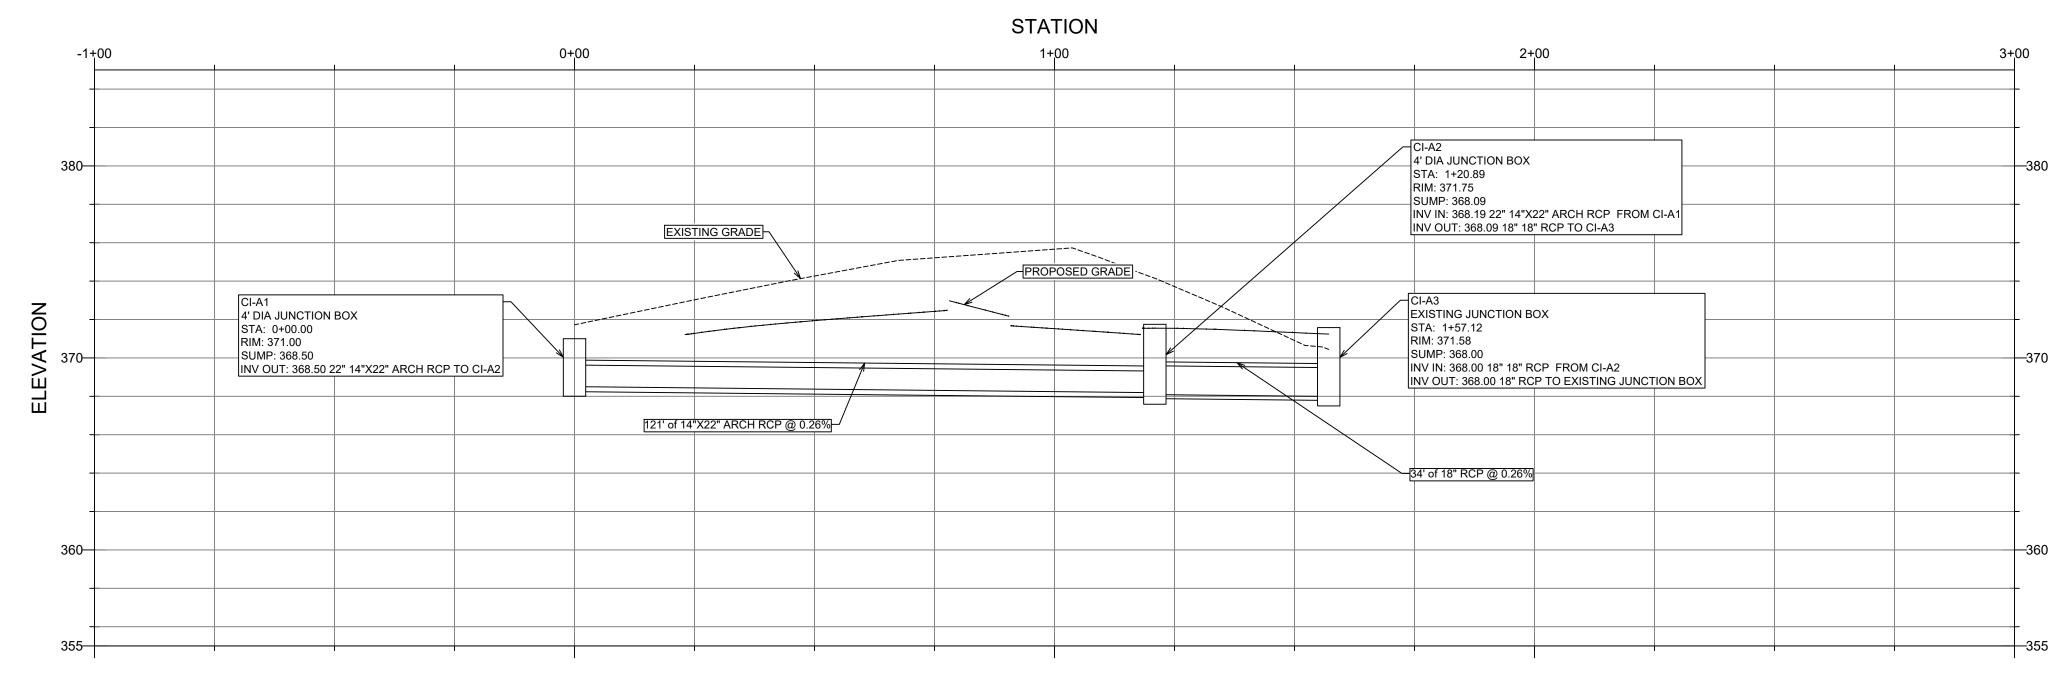


# SANITARY SEWER




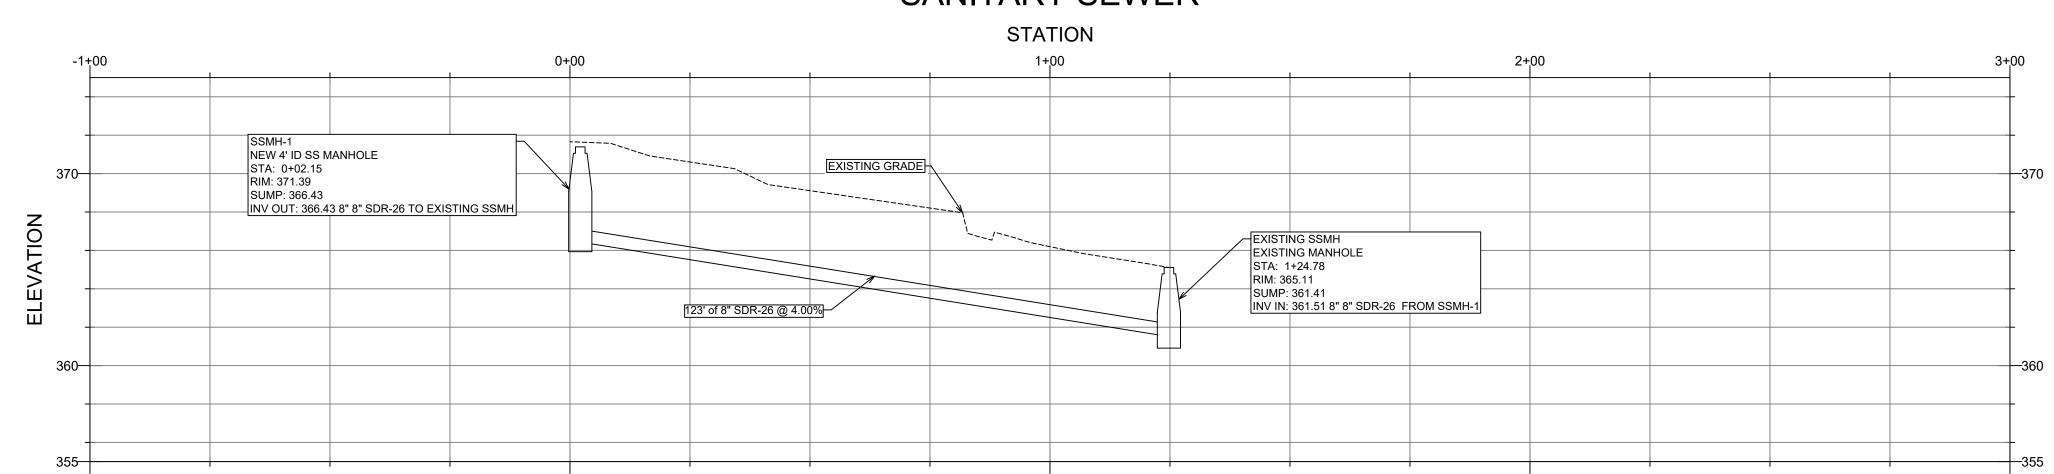

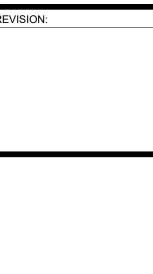PHILLIP LEWIS ENGINEERING, INC.
Structural + Civil Consultants

NGS IEW BEGINING: HIGHWAY 5 BRYANT, ARKANSAS NEW

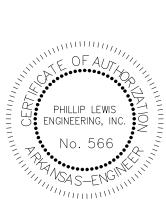

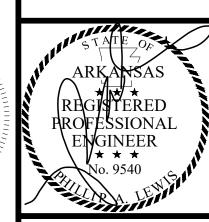


SHEET ISSUE DATE:

C1.7

UTILITY PROFILES


SHEET NUMBER: C1.7

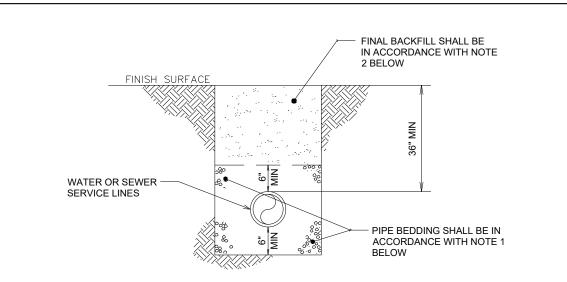

GAS LINE BEDDING DETAIL

NOT TO SCALE


NOT TO SCALE

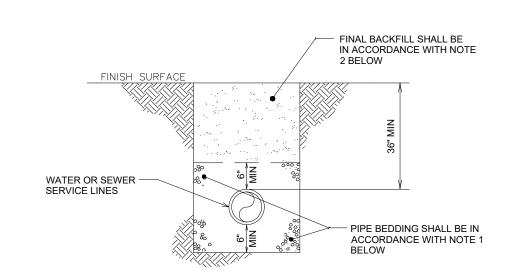



WATER AND SEWER LINES BEDDING DETAIL


— 4" REMOVABLE THREADED EXISTING GRADE -2' SQ. X 4" THK. CONCRETE SLAB (IF NOT IN PAV'T.) -4" CAST IRON OR DUCTILE IRON PIPE GRAVITY SEWER -FLOW SANITARY WYE PLUG AT END OF LINE


THROUGH FLOW CLEANOUT

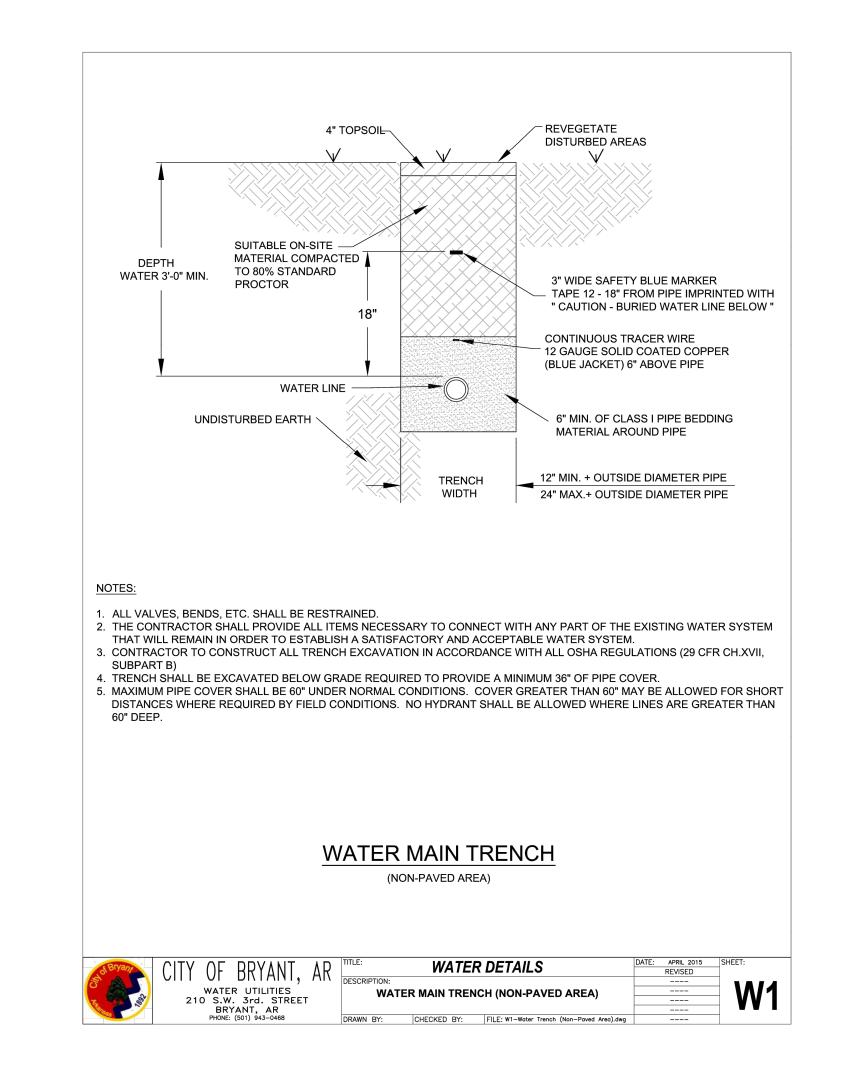


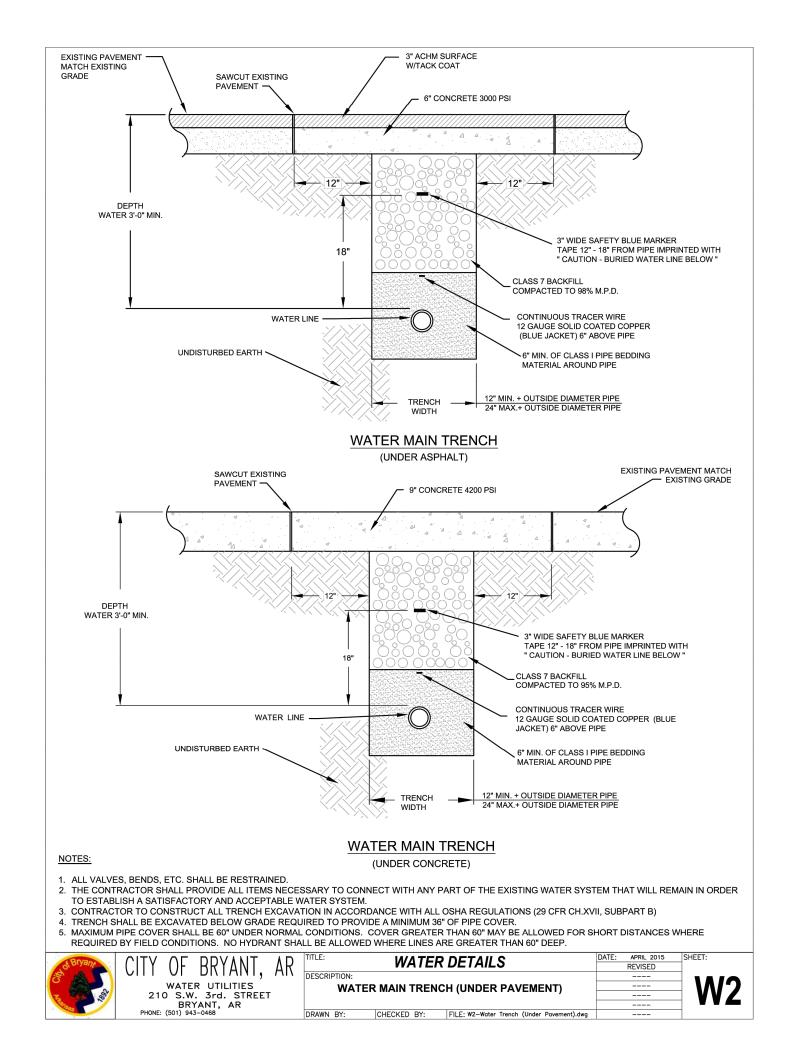


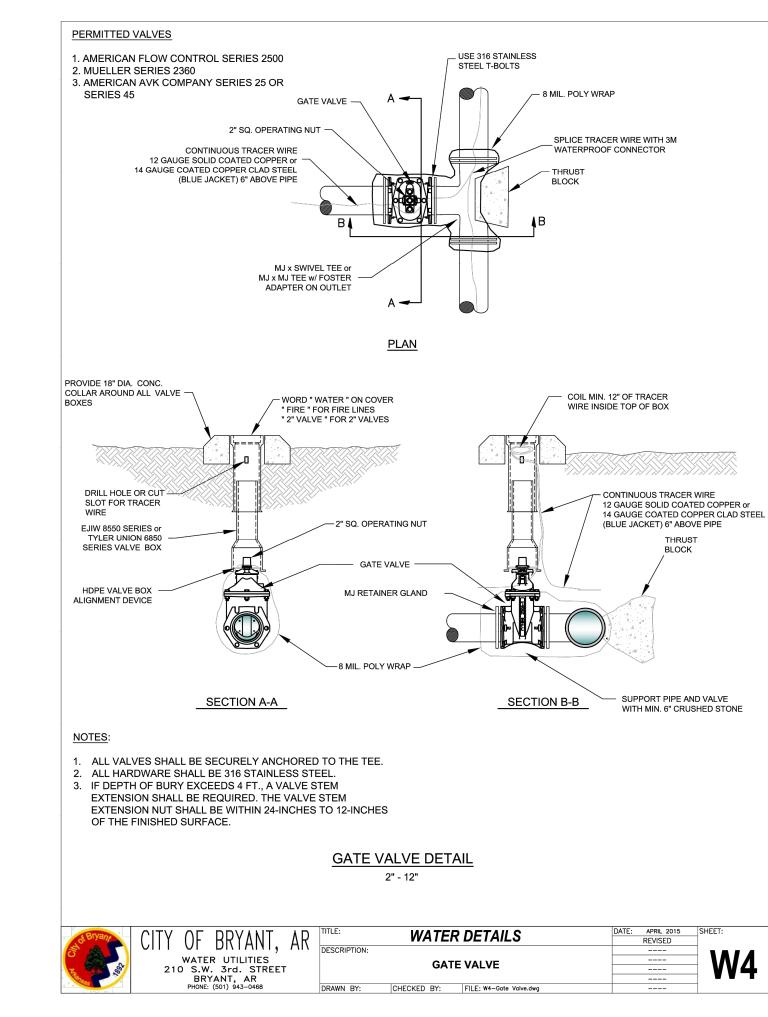


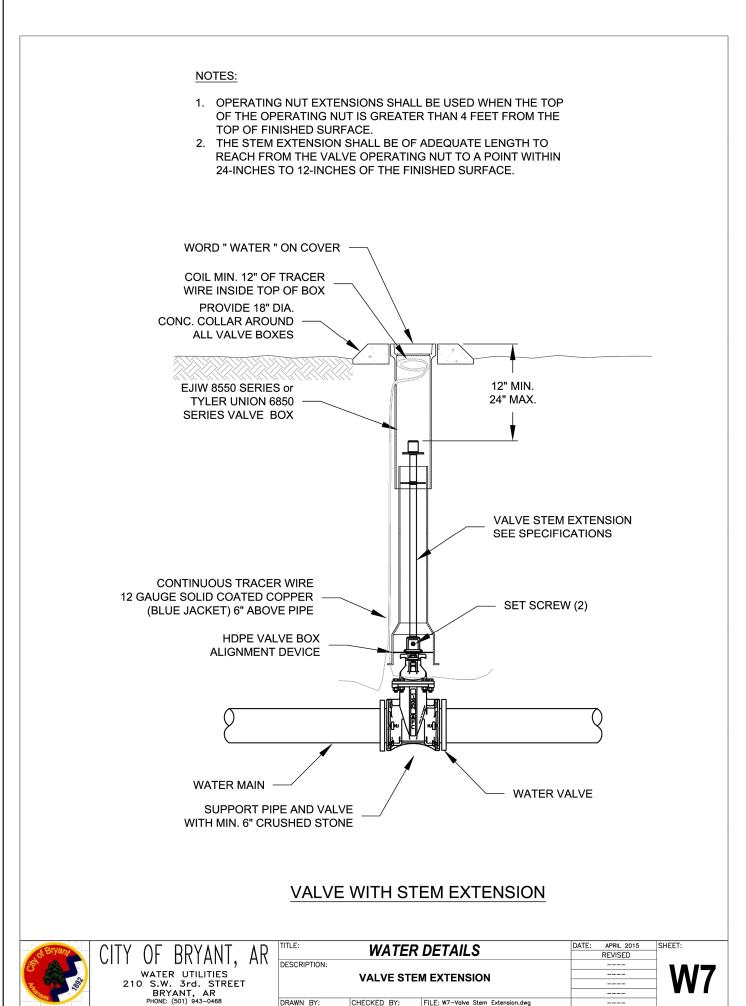

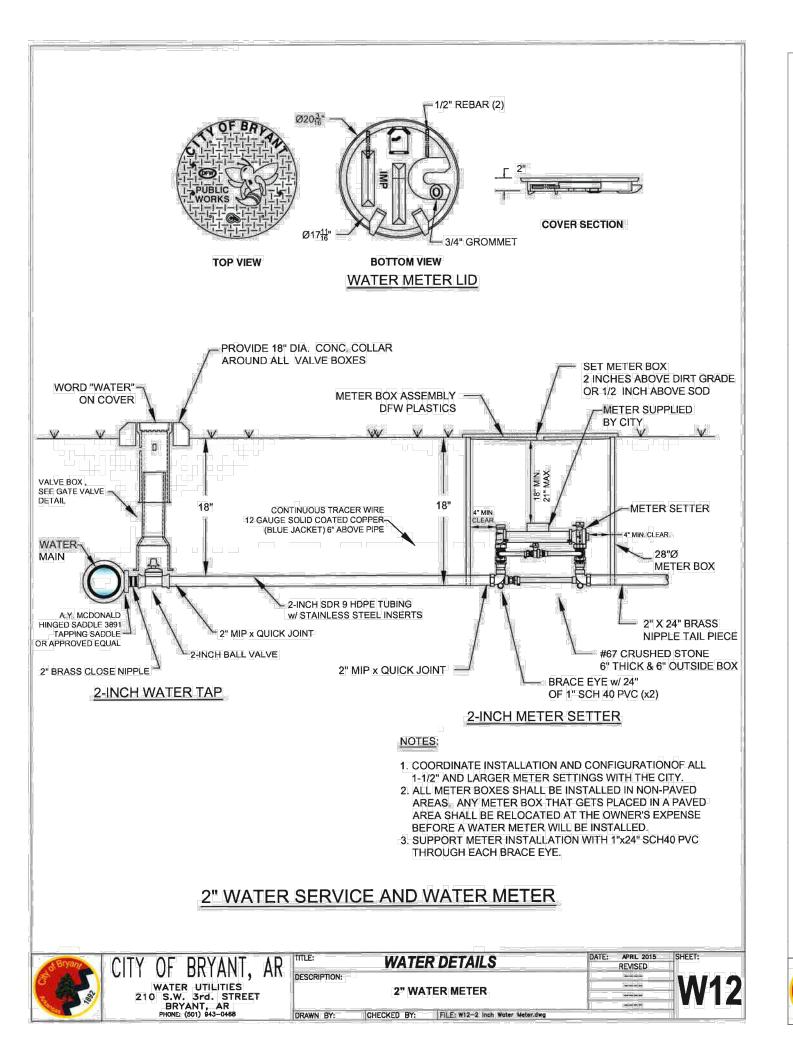

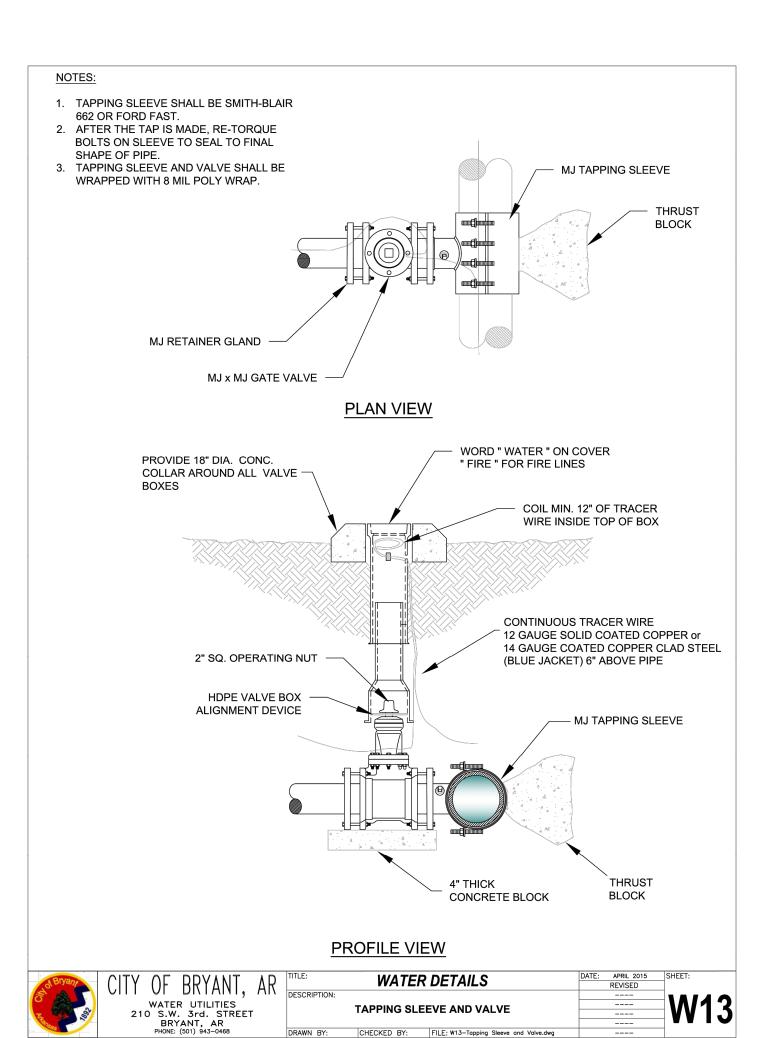

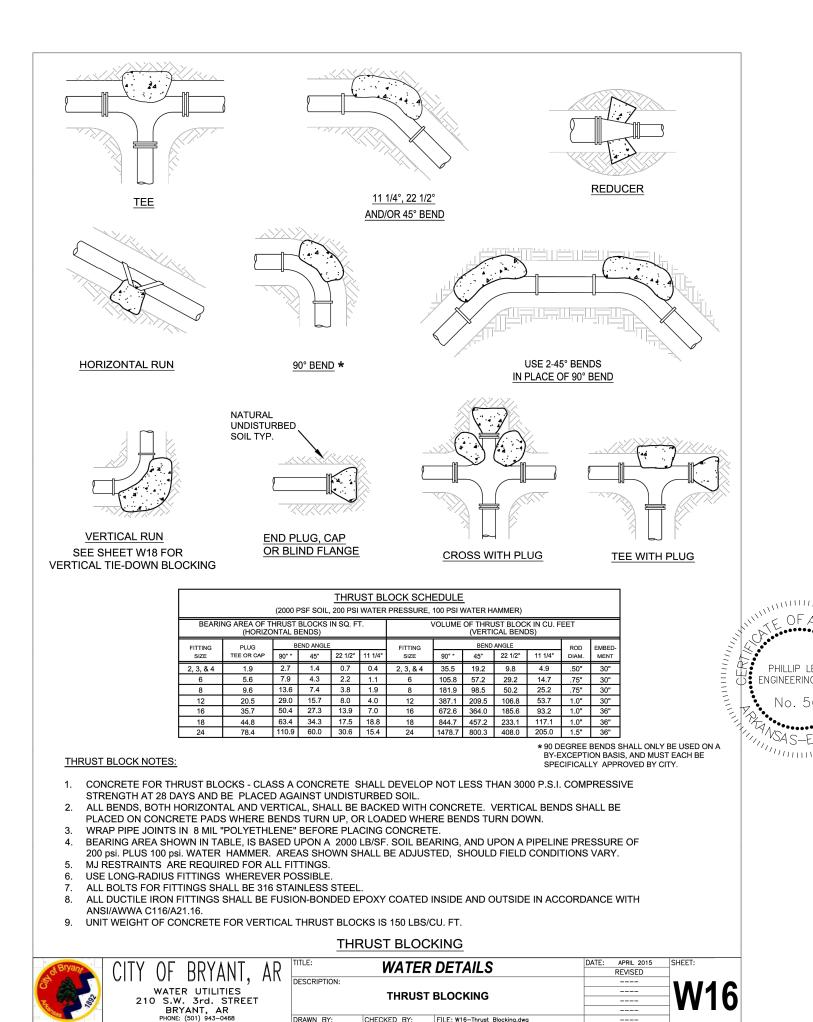

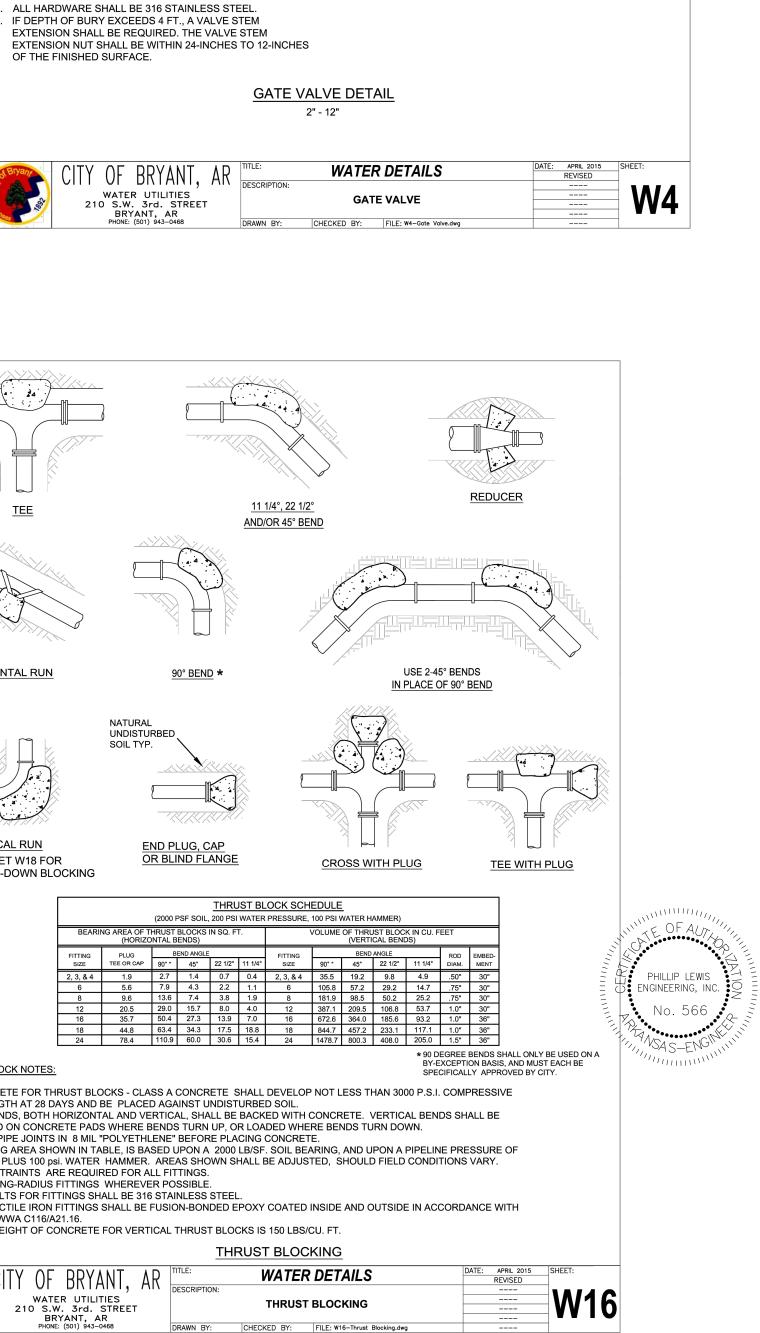

ENGINEERING, LEWIS

HILLIP

REVISION:


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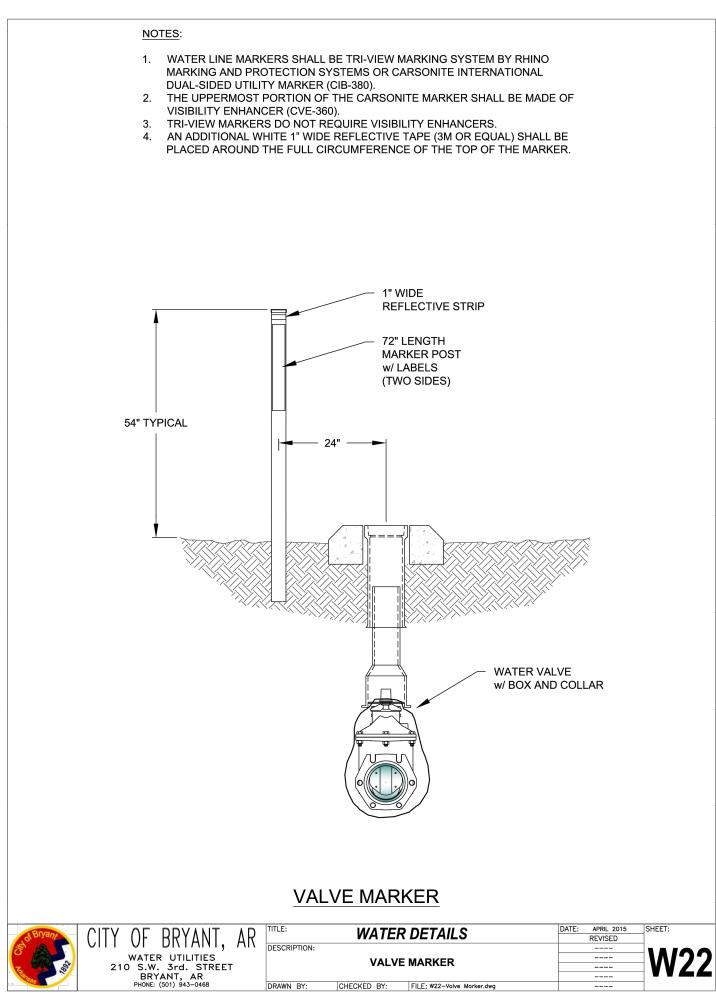
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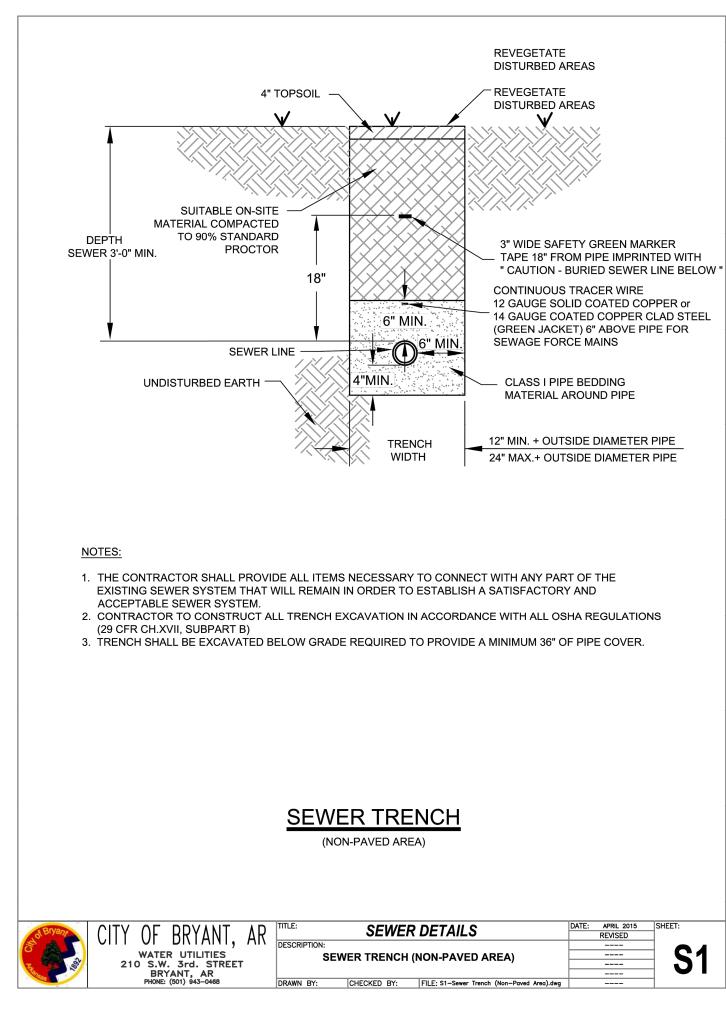
UTILITY


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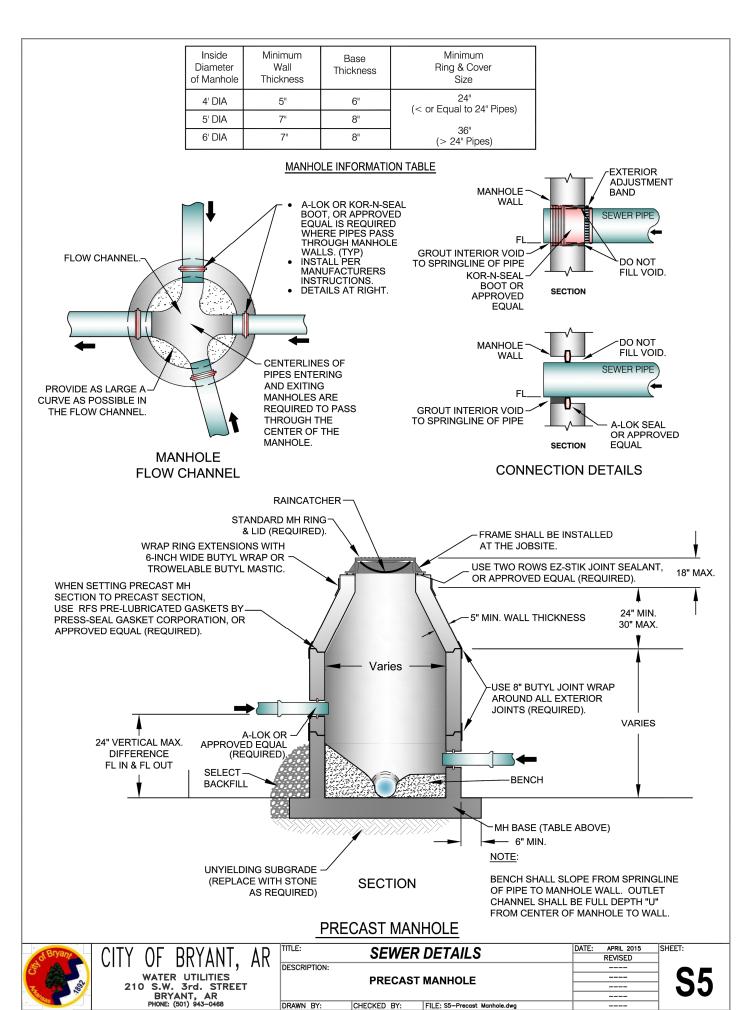
DETAILS I










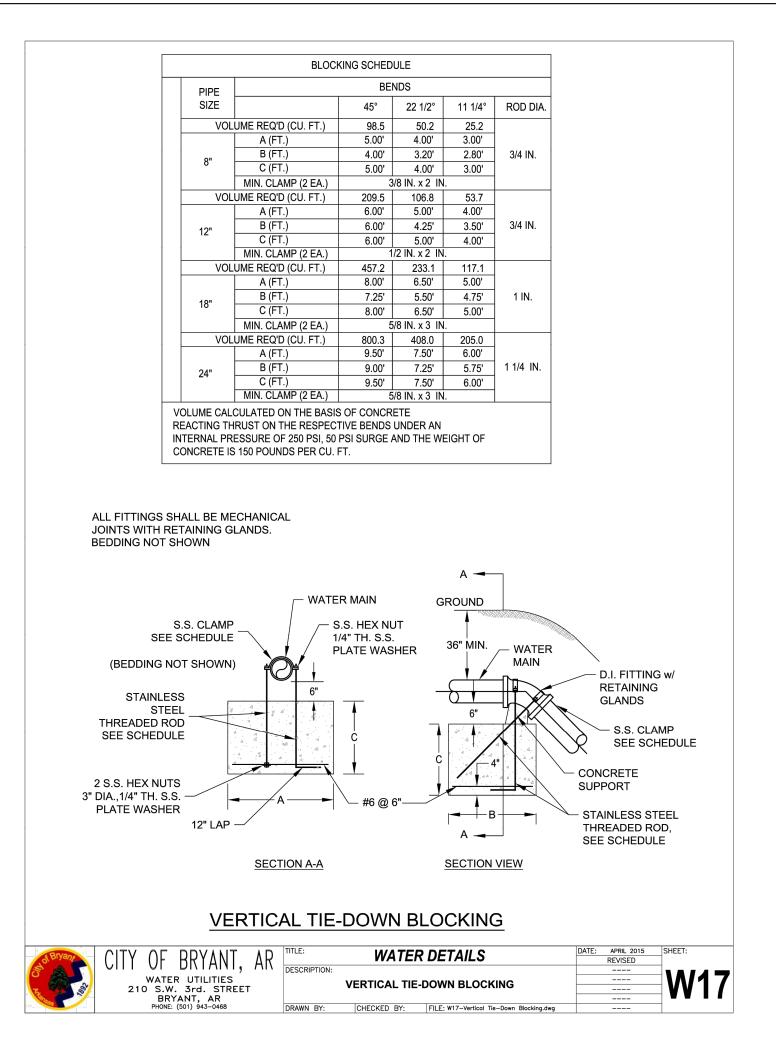


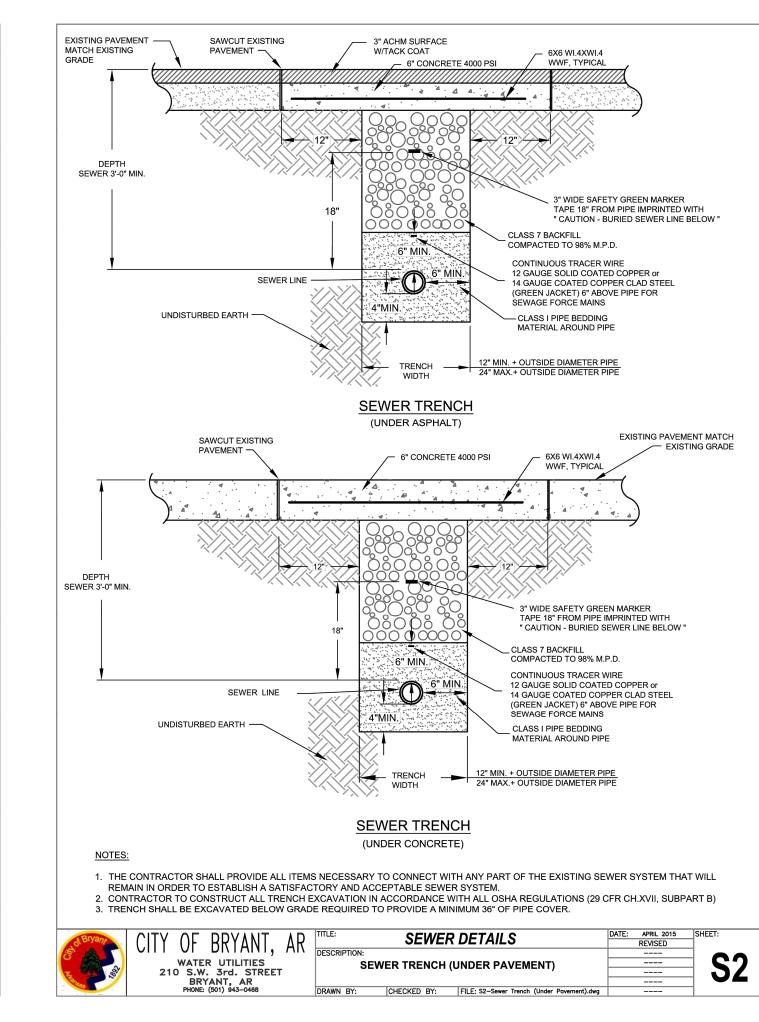

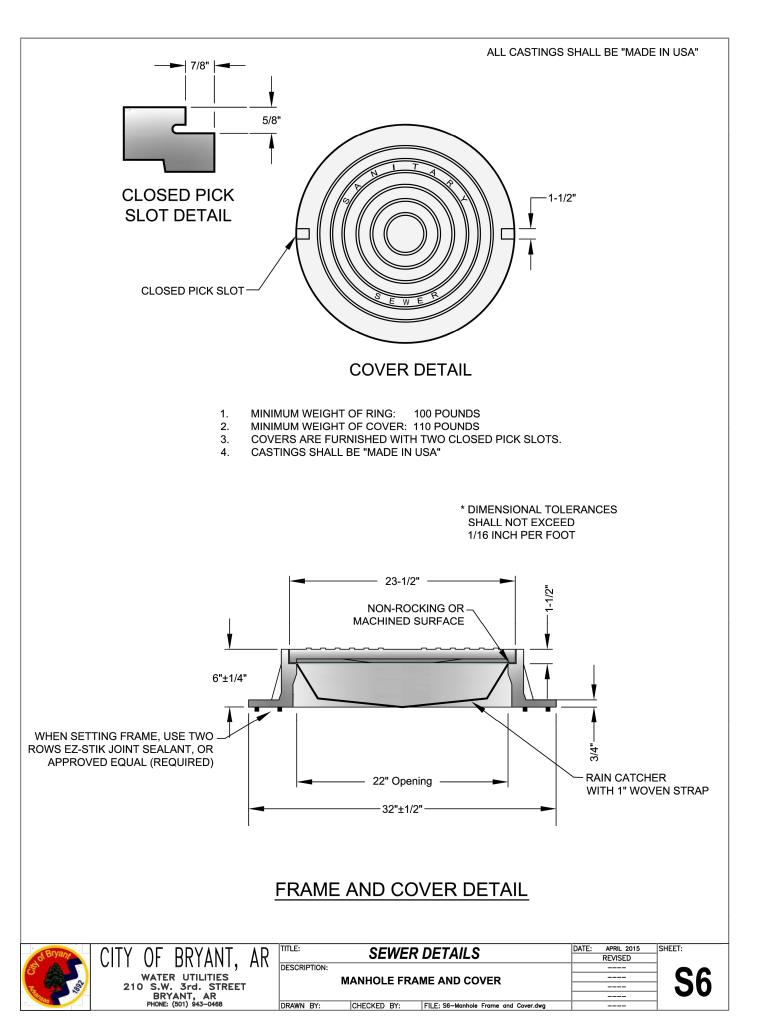

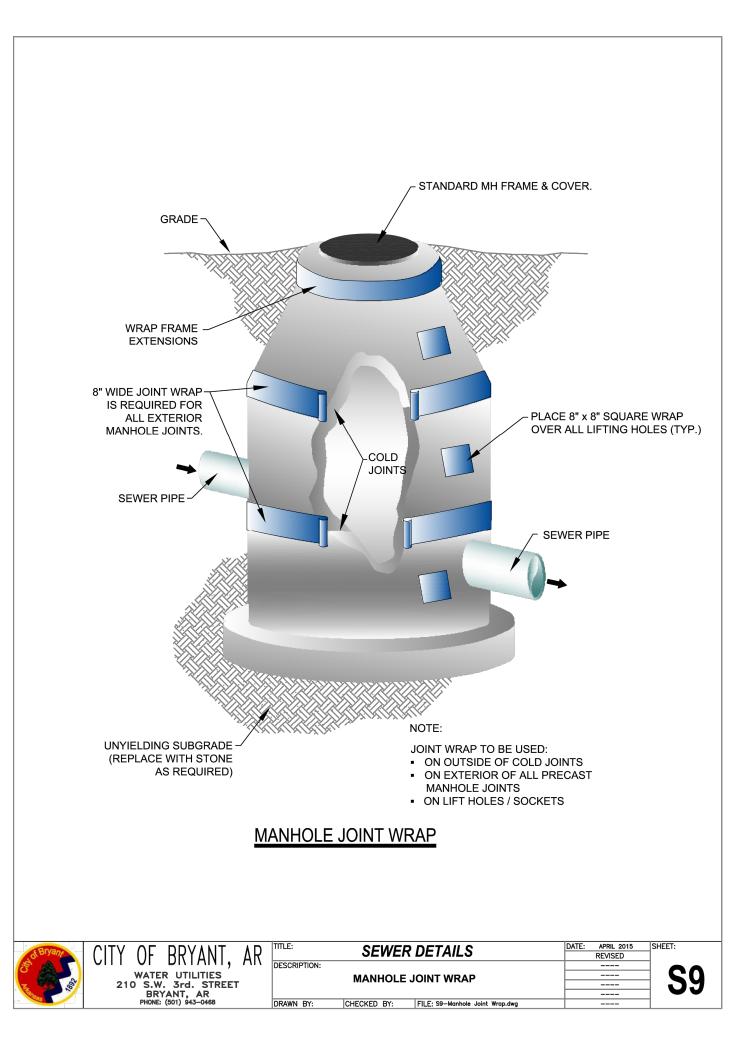

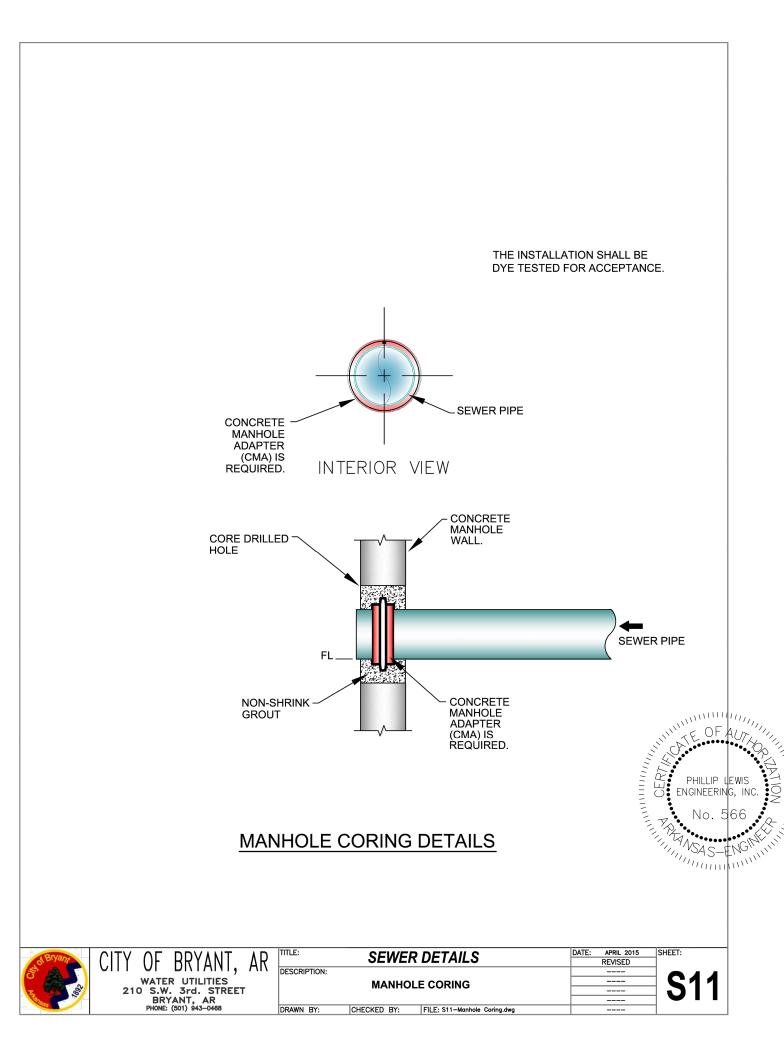

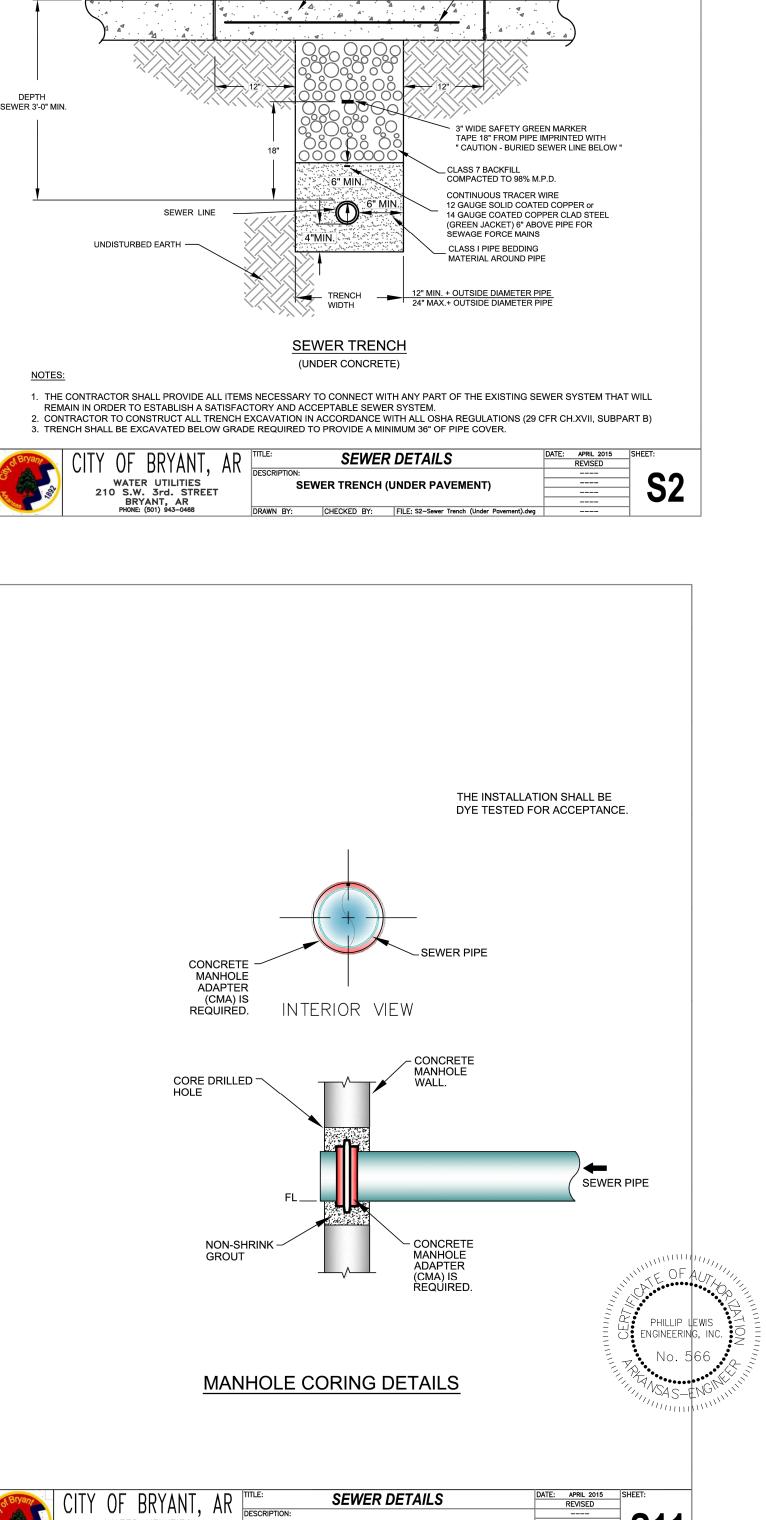


ENGINEERING,

LEWIS

PHILLIP

REVISION:

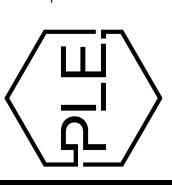

BEGINII HIGHWAY 5 ANT, ARKANS NEW

PROJECT NUMBER:

SHEET ISSUE DATE: 07-24-2025

> UTILITY **DETAILS I**

SHEET NUMBER: C1.9



ARKANSAS

REGISTERED

PROFESSIONAL

EVGINEER

No. 9540


PROJECT NUMBER

PHILLIP LEWIS ENGINEERING,
Structural + Civil Consultants


SHEET ISSUE DATE: 07-24-2025

PRE-DEV
DRAINAGE

T NUMBER:

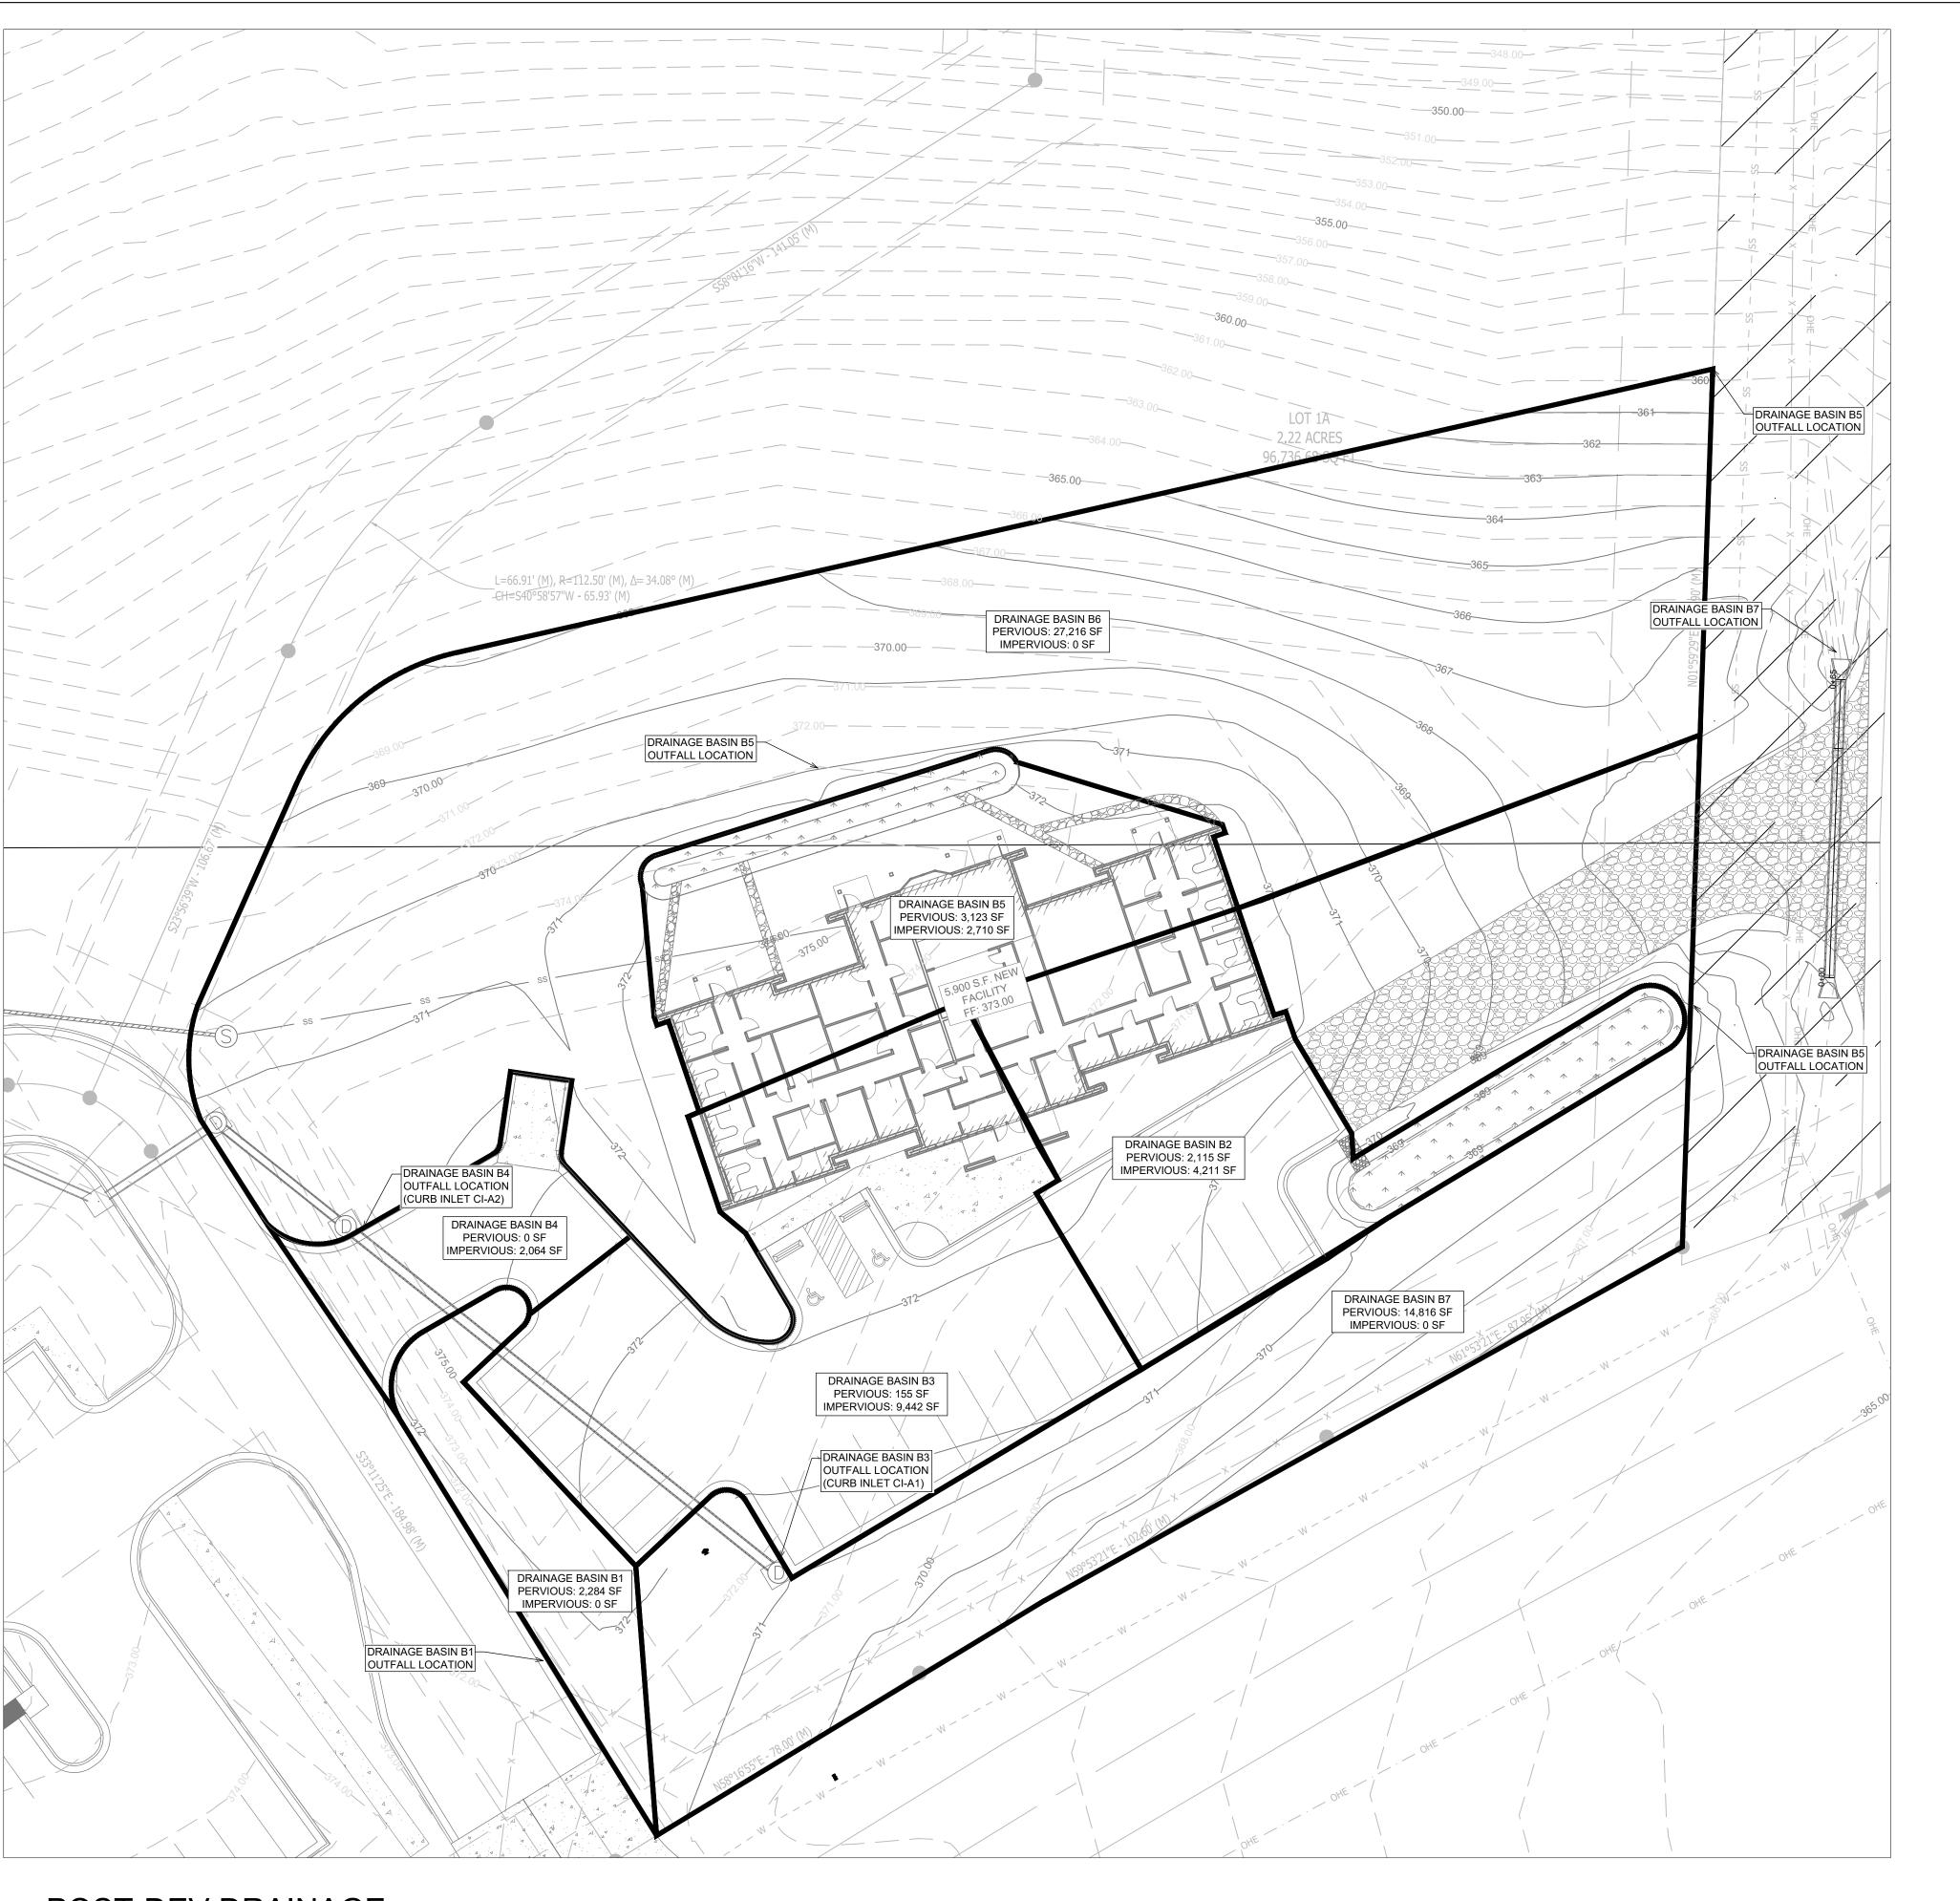

POST-DEV DRAINAGE SCALE 1" = 20'

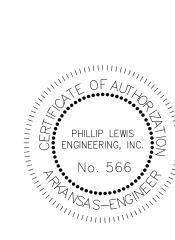

1" = 10'-0"

IEW BEGININ HIGHWAY 5 BRYANT, ARKANS,

NEW

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Structural + Civil Consultants

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POST-DEV DRAINAGE

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#### GENERAL CONSTRUCTION NOTES

- A. THE CONTRACTOR WILL BE HELD SOLELY RESPONSIBLE FOR DAMAGES OCCURRING TO ANY PROPERTY DURING THE CONSTRUCTION OF THIS PROJECT. SAID CONTRACTOR SHALL TAKE ALL NECESSARY PRECAUTIONS TO PREVENT PROPERTY DAMAGE.
- B. IN ACCORDANCE WITH GENERALLY ACCEPTED CONSTRUCTION PRACTICES, THE CONTRACTOR WILL SOLELY AND COMPLETELY BE RESPONSIBLE FOR CONDITIONS OF THE JOB SITE, INCLUDING SAFETY WORK. THIS REQUIREMENT WILL APPLY CONTINUOUSLY AND WILL NOT BE LIMITED TO NORMAL WORKING

ENGINEERING,

LEWIS

PHILLIP

REVISION:

THE DUTY OF BRYANT TO CONDUCT CONSTRUCTION INSPECTION REVIEWS OF THE CONTRACTOR'S PERFORMANCE IS NOT AN INSPECTION OR REVIEW OF THE ADEQUACY OF THE CONTRACTOR'S SAFETY MEASURES IN, ON, OR NEAR THE CONSTRUCTION SITE.

- C. ALL WATER AND SEWER IMPROVEMENTS SHALL BE CONSTRUCTED IN ACCORDANCE WITH THE LATEST REVISION TO THE CITY OF BRYANT'S WATER AND WASTEWATER (SANITARY SEWER) STANDARD SPECIFICATIONS.
- D. THE CONTRACTOR IS SPECIFICALLY CAUTIONED THAT THE LOCATION AND/OR ELEVATION OF EXISTING UTILITIES AS SHOWN ON THESE PLANS IS BASED ON RECORDS OF THE VARIOUS UTILITY COMPANIES AND, WHERE POSSIBLE, MEASUREMENTS TAKEN IN THE FIELD. THE INFORMATION IS NOT TO BE RELIED ON AS BEING EXACT OR COMPLETE. THE CONTRACTOR MUST CALL THE APPROPRIATE UTILITY COMPANY AT LEAST 48 HOURS BEFORE ANY EXCAVATION TO REQUEST EXACT FIELD LOCATION OF ALL UTILITIES. IT SHALL BE THE RESPONSIBILITY OF THE CONTRACTOR TO LOCATE ALL EXISTING UTILITIES WHICH CONFLICT WITH PROPOSED IMPROVEMENTS SHOWN ON THE PLAN.
- E. CONTRACTOR IS TO REMOVE AND DISPOSE OF ALL DEBRIS, RUBBISH, AND OTHER MATERIALS RESULTING FROM PREVIOUS AND CURRENT DEMOLITION OPERATIONS. DISPOSAL WILL BE IN ACCORDANCE WITH ALL LOCAL, STATE AND/OR FEDERAL REGULATIONS GOVERNING SUCH OPERATIONS.
- PRIOR TO INSTALLATION OF ANY UTILITIES, THE CONTRACTOR IS TO EXCAVATE, VERIFY AND CALCULATE ALL CROSSINGS AND INFORM ANY AND ALL UTILITIES OF ANY CONFLICTS PRIOR TO CONSTRUCTION.
- G. CONSTRUCTION SHALL NOT START ON ANY WATER UTILITY TIE-INS UNTIL APPROVAL IS GIVEN BY BRYANT WATER. SAID CONTRACTOR SHALL NOT OPERATE ANY VALVE, HYDRANT, OR WATER UTILITY APPURTENANCE NOR SHALL HE ATTACH TO OR TAP ANY WATER UTILITY MAIN WITHOUT APPROVAL. THE CONTRACTOR SHALL BEAR THE COST AND CONSEQUENCE OF ANY DISRUPTION OF UTILITY OPERATION CAUSED BY CONSTRUCTION.
- H. FIBER OPTIC CABLE ON AND/OR ADJACENT TO THIS SITE WERE NOT LOCATED BY THE SURVEY AND ARE NOT SHOWN. IT IS THE RESPONSIBILITY OF THE CONTRACTOR TO LOCATE ANY FIBER OPTIC CABLES ASSOCIATED WITH THIS SITE AND TAKE ALL NECESSARY AND REQUIRED PRECAUTIONS TO PROTECT ANY EXISTING FIBER OPTIC CABLES. CONTRACTORS SHALL COORDINATE ALL EFFORTS WITH OWNER OF FIBER OPTIC CABLES OR THEIR DESIGNATED REPRESENTATIVE.
- THE CONTRACTOR IS RESPONSIBLE FOR CONTACTING "ONECALL" SERVICE TO MARK ALL UTILITIES PRIOR TO ANY DEMOLITION, EARTHWORK, OR UTILITY WORK ON THIS SITE.

		Pl	ANT SCH	IEDULE		
PLANT TYPE	SYMBOL	CODE	QTY	COMMON SPECIES	SCIENTIFIC NAME	CAL / SIZE
TREES		WO	6	WILLOW OAK	QUERCUS PHELLOS	MIN. 3" DIAMETER @ BASE AND 12' TALL
SHRUBS	Ø	BW	40	DWARF NANDINA	N. DOMESTICA "HARBOUR DWARF"	3 GAL
ROUND COVER		so	24,114 SF	BERMUDA SOD		
	\(\psi\) \(\	GS	24,140 SF	GRASS SEED		
			1,828 SF	LANDSCAPE BEDDING (TBD BY OWNER)		



07-24-2025

LANDSCAPE PLAN

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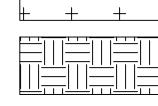
LANDSCAPED AREAS TO BE AMENDED WITH 4" OF TOPSOIL, SCARIFY SOIL 3" PRIOR TO APPLICATION. ALL TOP SOIL SHALL BE PLACED IN COORDINATION WITH GRADING AND DRAINAGE PLANS TO ENSURE THAT THE GRADING AND DRAINAGE DESIGN FOR THE SITE IS MAINTAINED AFTER BEING SODDED OR SEEDED. EXISTING SOIL FROM THE SITE CAN BE STOCK PILED AND REUSED AS LONG AS IT IS OF QUALITY THAT ENCOURAGES ADEQUATE GROWTH OF PLANTING MATERIAL. THE CONTRACTOR IS RESPONSIBLE FOR ANY SOIL

TESTING THAT MAY BE REQUIRED.


2. LANDSCAPE PLAN REPRESENTS RECOMMENDED SPECIES, SIZES, & LOCATIONS. OWNER SHALL CHANGE THE ITEMS TO EQUAL OR GREATER VALUE.

# LEGEND

DISTURBED AREA




UNDISTURBED AREA

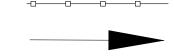

DRAINAGE DIRECTION

SEDIMENT FENCE WITH WIRE BACKING

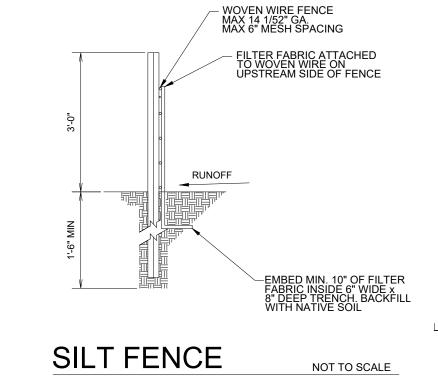

#### NOTES AND SPECIFICATIONS:

 POSTS SHALL BE A MINIMUM OF 36 INCHES CONSTRUCTED OF EITHER OF THE FOLLOWING MATERIALS: STEEL "T" OR "U" TYPE, OR 2" x 2" HARDWOOD.
 WOVEN WIRE USED AS ADDITIONAL FENCE SUPPORT SHALL BE MINIMUM 14.5 GA. WITH 6" MAXIMUM SPACING. 3. WOVEN WIRE SHALL BE PLACED ALONG THE UPHILL SIDE OF THE FENCE AND FASTENED WITH WIRE TIES OR 1" STAPLES ALONG THE UPHILL SIDE OF THE

4. FILTER FABRIC SHALL BE FASTENED TO WOVEN WIRE ACCORDING TO MANUFACTURER'S RECOMMENDATION, OR WITH TIES EVERY 24" AT THE TOP AND MID-SECTIONS. 5. WHERE TWO PIECES OF FILTER FABRIC ADJOIN EACH OTHER THEY SHALL BE OVERLAPPED BY 6 INCHES AND FOLDED TOGETHER.

6. WHERE TWO POSTS MEET TO JOIN FENCE SECTIONS, THE TOPS OF THE

POSTS SHALL BE SECURED TOGETHER WITH WIRE. 7. THE FENCE SHALL BE CONSTRUCTED ALONG THE CONTOUR AS MUCH AS 8. ENDS OF FENCES SHALL BE EXTENDED UP THE SLOPE TO PRVENT RUNOFF FROM MIGRATING AROUND THE END OF THE FENCE. 9. INSPECTION OF THE FENCE SHALL BE PERFORMED WEEKLY, OR IMMEDIATELY AFTER A RAIN EVENT, OR WHEN BULGES APPEAR IN THE FENCE. ACCUMALTED SILT SHALL NOT BE ALLOWED TO EXCEED HALF THE HEIGHT OF THE FABRIC. REPAIR AND OR REPLACMENT OF DAMAGED FENCE SHALL BE

COMPLETED PROMPTLY. 10. ACCUMULATED SILT SHALL BE REMOVED AND DISPOSED OF IN AN APPROVED SITE IN SUCH A MANNER THAT IT WILL NOT CONTRIBUTE TO OFF-SITE 11. ALL FENCING SHALL BE REMOVED WITH THE CONSTRUCTION SITE IS FULLY STABLIZED SO AS TO NOT IMPEDE STORM FLOW OR DRAINAGE. 12. PRE-FRABRICATED UNITS DO NOT REQUIRE THE USE OF WOVEN WIRE

### NOTES (GENERAL):


- 1. SEE EROSION CONTROL DETAILS IN SWPPP FOR EROSION CONTROL FACILITIES. 2. SEE SWPPP FOR INSTALLATION, MAINTENANCE, INSPECTION, AND RECORD KEEPING REQUIREMENTS.
- CONTRACTOR SHALL SHOW EROSION CONTROL MEASURE ON SITE MAP.
- 4. EROSION AND SEDIMENT CONTROL STRUCTURES TO MEET SWPPP DETAILS APPENDIX D
- 5. INSTALL ROCK DITCH, CHECK, OR SAND BAG CHECKS AS NECESSARY TO PREVENT SCOUR UNTIL
- LANDSCAPING IS ESTABLISHED.
- 6. CONTRACTOR MUST PLACE SEDIMENT BASIN WITH SEDIMENT FENCE OUTLET FOR ANY SEDIMENT
- CONTAMINATED DEWATERING DISCHARGE.
- FINAL SLOPE WILL BE SAME DIRECTION AS EXISTING SLOPE.
   TEMPORARY STABILIZATION PRACTICES WILL NOT BE REQUIRED. WORK WILL BE CONTINUOUS AND DISTURBED AREA REVEGITATED IN A TIMELY MANNER. SEE SWPPP FOR SEEDING MIXES.
- 9. PERMANENT STABILIZATION OF ALL DISTURBED AREAS ARE TO BE SEEDED, FERTILIZED, WATERED AND COVERED WITH STRAW UNLESS OTHERWISE NOTED ON PLANS TO BE HYDROSEEDED. 10. CONTRACTOR TO SHOW CONCRETE WASH OUT SUMP, ENTRANCE/EXIT PAD AND OTHER CONTROLS AS REQUIRED/NEEDED AS SWPPP
- SITE MAP IS UPDATED THROUGHOUT THE DURATION OF THE PROJECT. 11. STOCKPILING OF CONSTRUCTION SPOIL MATERIAL AT PARTICULAR LOCATIONS SHALL ONLY BE ALLOWED FOR A LIMITED TIME PERIOD, NOT TO EXCEED (6) MONTHS. PRIOR TO A FINAL INSPECTION OF THE GRADING PERMIT, THE FOLLOWING STANDARDS SHALL BE ACHIEVED FOR
  - a) DEVELOPMENT AND GRADING WITHIN THE DISTURBED AREA IS COMPLETE AND MATCHES PLANS AS APPROVED BY THE PLANNING
  - COMMISSION, AND
  - b) THE DISTURBED SOIL AREA IS OBSERVED TO HAVE 80% GRASS COVERAGE AND 100% STABILITY, AND c) NO SLOPES STEEPER THAN A 3:1 PITCH UNLESS OTHERWISE APPROVED IN WRITING BY THE DIRECTOR OF ENGINEERING, AND
  - d) NOTICE OF VIOLATIONS ISSUED HAVE ALL CORRECTIVE ACTIONS APPROVED WITH AN INSPECTION REPORT SIGNED BY A REPRESENTATIVE

OF THE DIRECTOR OF ENGINEERING, AND e) ALL HEAVY EQUIPMENT, STOCKPILES, AND CONSTRUCTION SITE MATERIALS HAVE BEEN REMOVED FROM THE CONSTRUCTION SITE.

NEW CONSTRUCTION-50'-0" LONG x 25'-0" WIDE x 6" THICK 2" - 3" DIAMETER STONES PAVED SURFACE COMPACTED SUBGRADE 2" - 3" DIAMETER CLEAN STONE

# **CONSTRUCTION ENTRANCE**

NOT TO SCALE

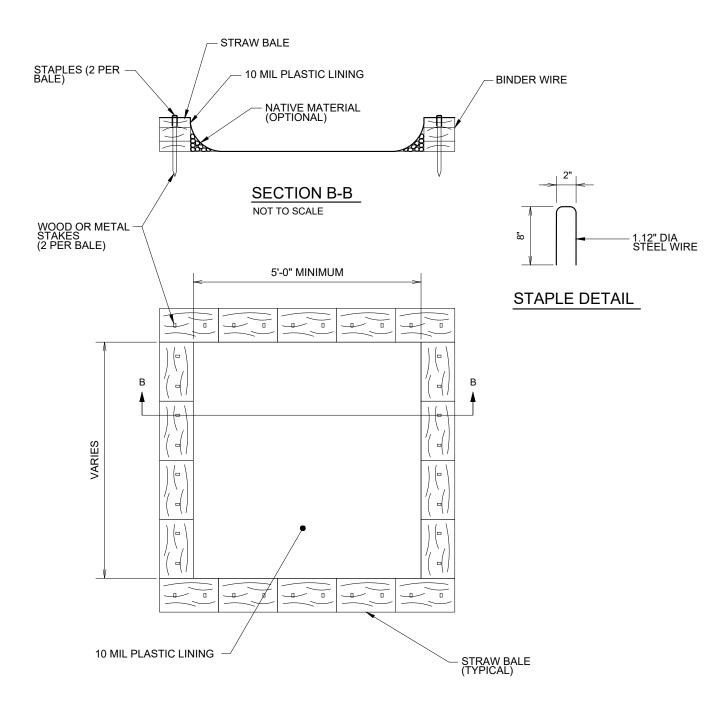

**CONCRETE WASHOUT** 

NOT TO SCALE



1" = 60'-0"

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ENGINEERING,

PHILLIP

SWPPP

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