

### **Bryant Development and Review Committee Meeting**

Boswell Municipal Complex - City Hall Conference Room 210 SW 3rd Street

Date: October 19, 2023 - Time: 9:00 AM

### Call to Order

### **Old Business**

### **New Business**

### 1. AR Storage Center - Avery LN - Fencing

Finely and Company - Requesting Approval for New Fencing around portion of Facility

• 0797-PLN-01.pdf

### 2. Schrader Commercial Addtion - Shady Pine Storage - Site Plan Addition

Alan Schrader - Requesting Approval for Site Plan Additions

- 0798-PLN-02.pdf
- 0798-BLD-01.pdf
- 0798-PLN-01.pdf

### 3. Marketplace II Subdivison - Lot 20 and 21 - Site Plan

Bart Ferguson - Requesting Recommendation for Site Plan Approval for Lot 20 and Lot 21

- <u>0799-PLN-01.pdf</u>
- · 0800-BLD-01.pdf
- 0800-PLN-01.pdf

### 4. Jacob's Corner Subdivison - Final Plat

Hope Consulting - Requesting Recommendation for Approval of Final Plat

• 0688-ASB-03.pdf

### 5. The Villages at Magnolia Lane Phase 2-3 - Preliminary Plat

Hope Consulting - Requesting Recommendation for Approval of Preliminary Plat

• 0801-PLN-01.pdf

### 6. Creekside Addition Phase 2 - Final Plat

GarNat Engineering - Requesting Recommendation for Approval of Final Plat

- 0796-LTR-01.pdf
- 0796-LTR-02.pdf
- <u>0796-PLT-01.pdf</u>
- 0796-ASB-01.pdf

- 0796-BOA-01.pdf
- <u>0796-CHKLST-01.pdf</u>
- 0796-PLN-01.pdf

### **Staff Approved**

### 7. Crash Champion Collision Repair - 22578 I-30 - Sign Permit

 $Ace\ Sign\ Company\ -\ Requesting\ Sign\ Permit\ Approval\ -\ STAFF\ APPROVED$ 

• Crash Champions Specs (Bryant) - Rev 9.29.23 (2).pdf

### 8. Starbucks - 20701 I-30 - Sign Permit

Pinnacle Signs - Requesting Sign Permit Approval - STAFF APPROVED


- Permit Aerial (3).pdf
- Sign B Sizing (2).pdf
- Sign A Sizing (2).pdf


### 9. Murphy USA - 403 Bryant Ave - Sign Permit


National Signs and Service - Requesting Sign Permit Approval - STAFF APPROVED


• Sign Permit application and rendering (1).pdf

### **Adjournments**

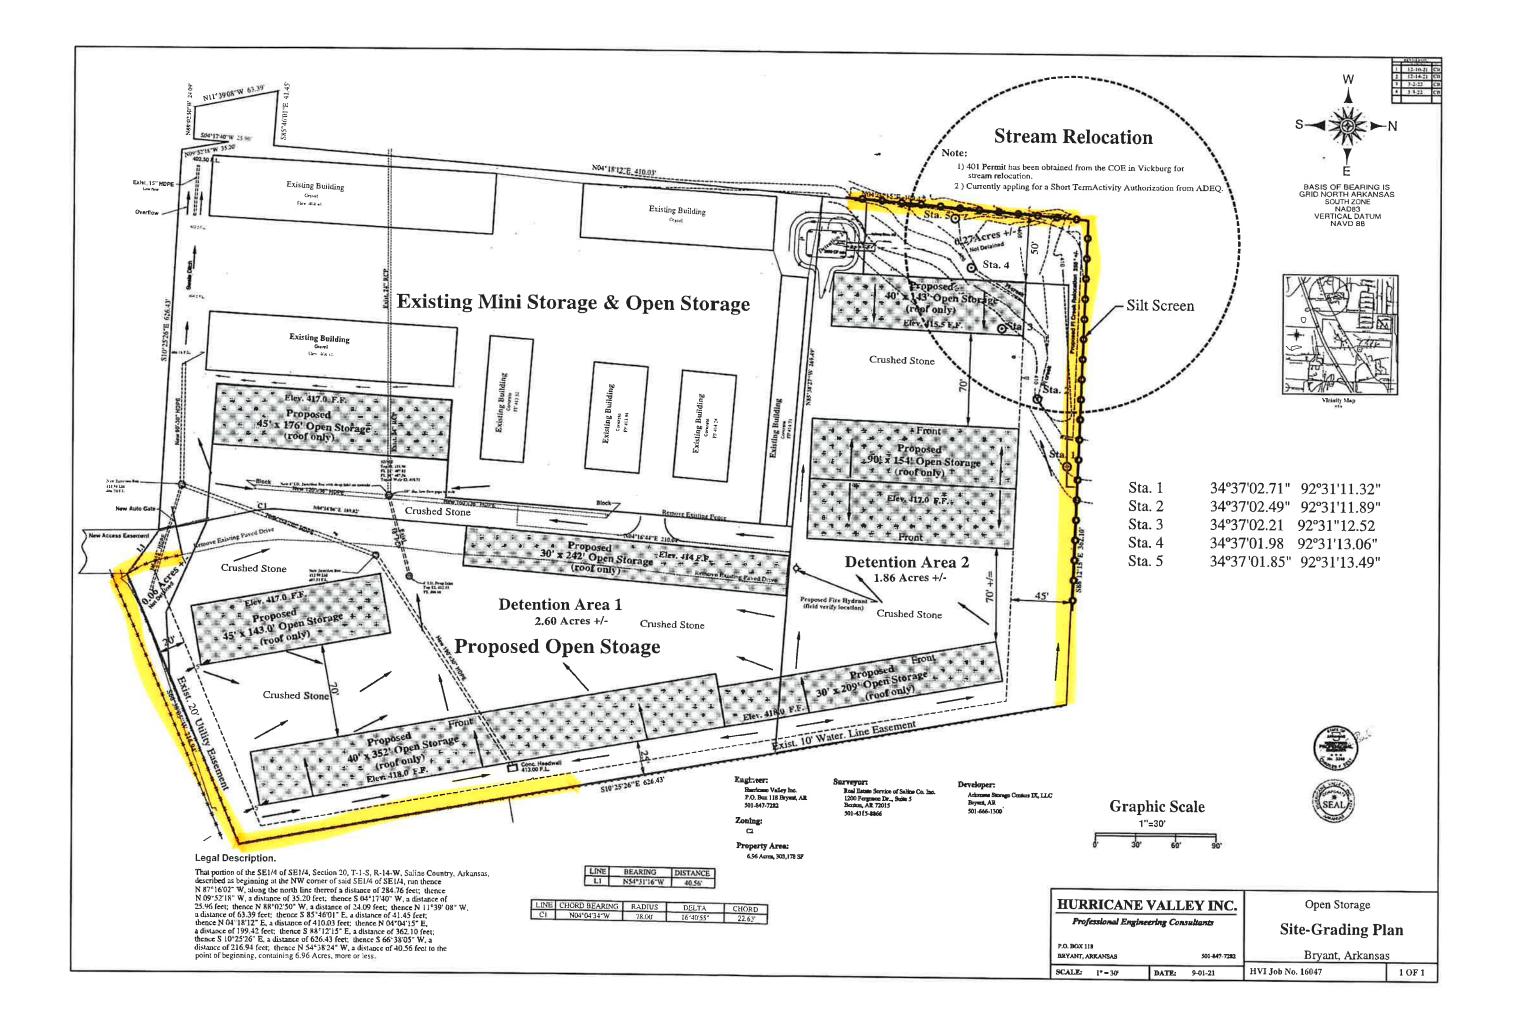

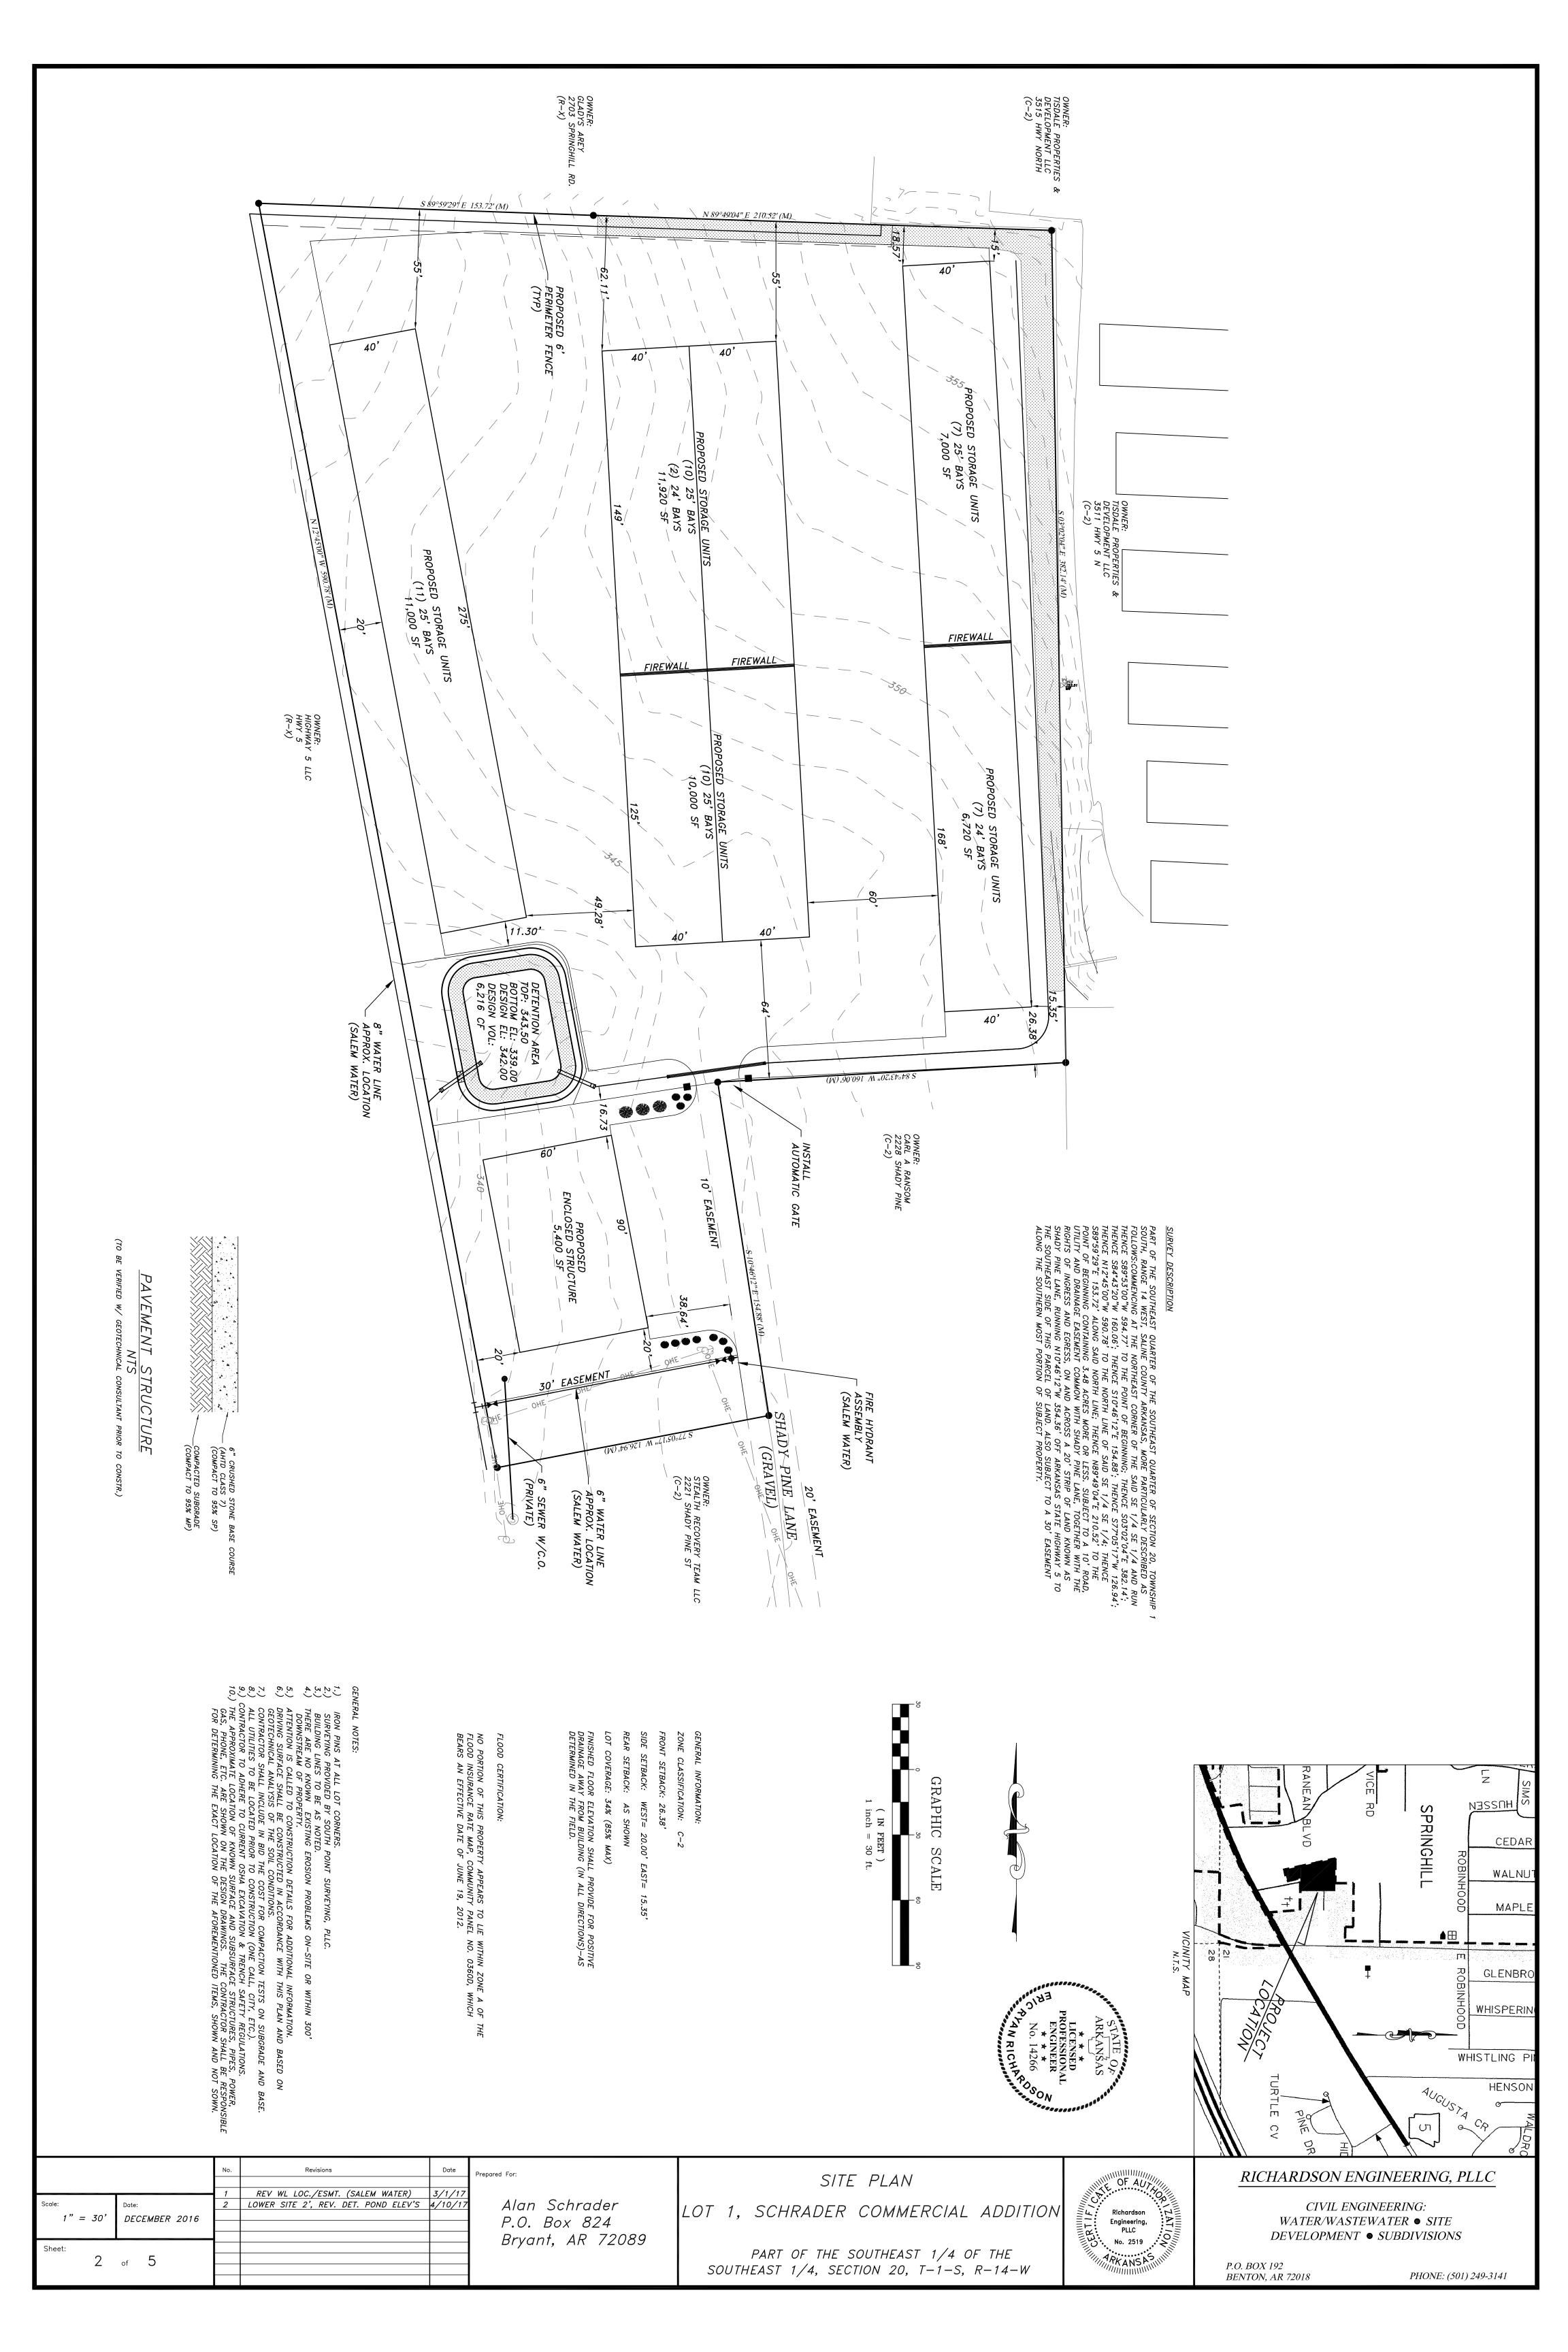

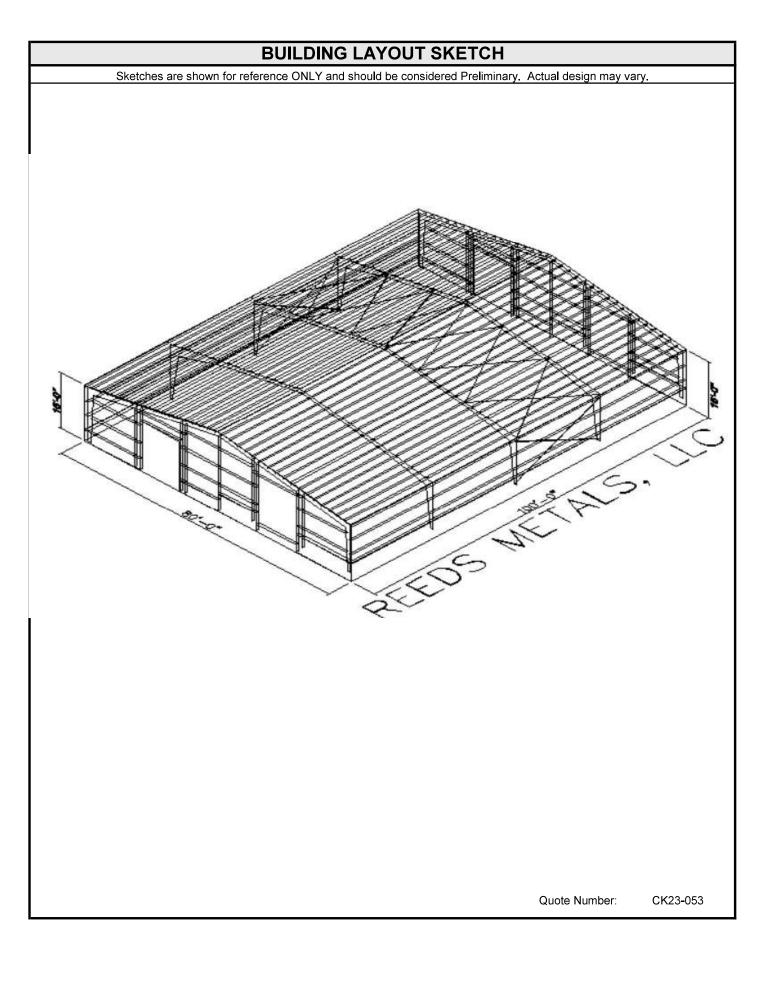

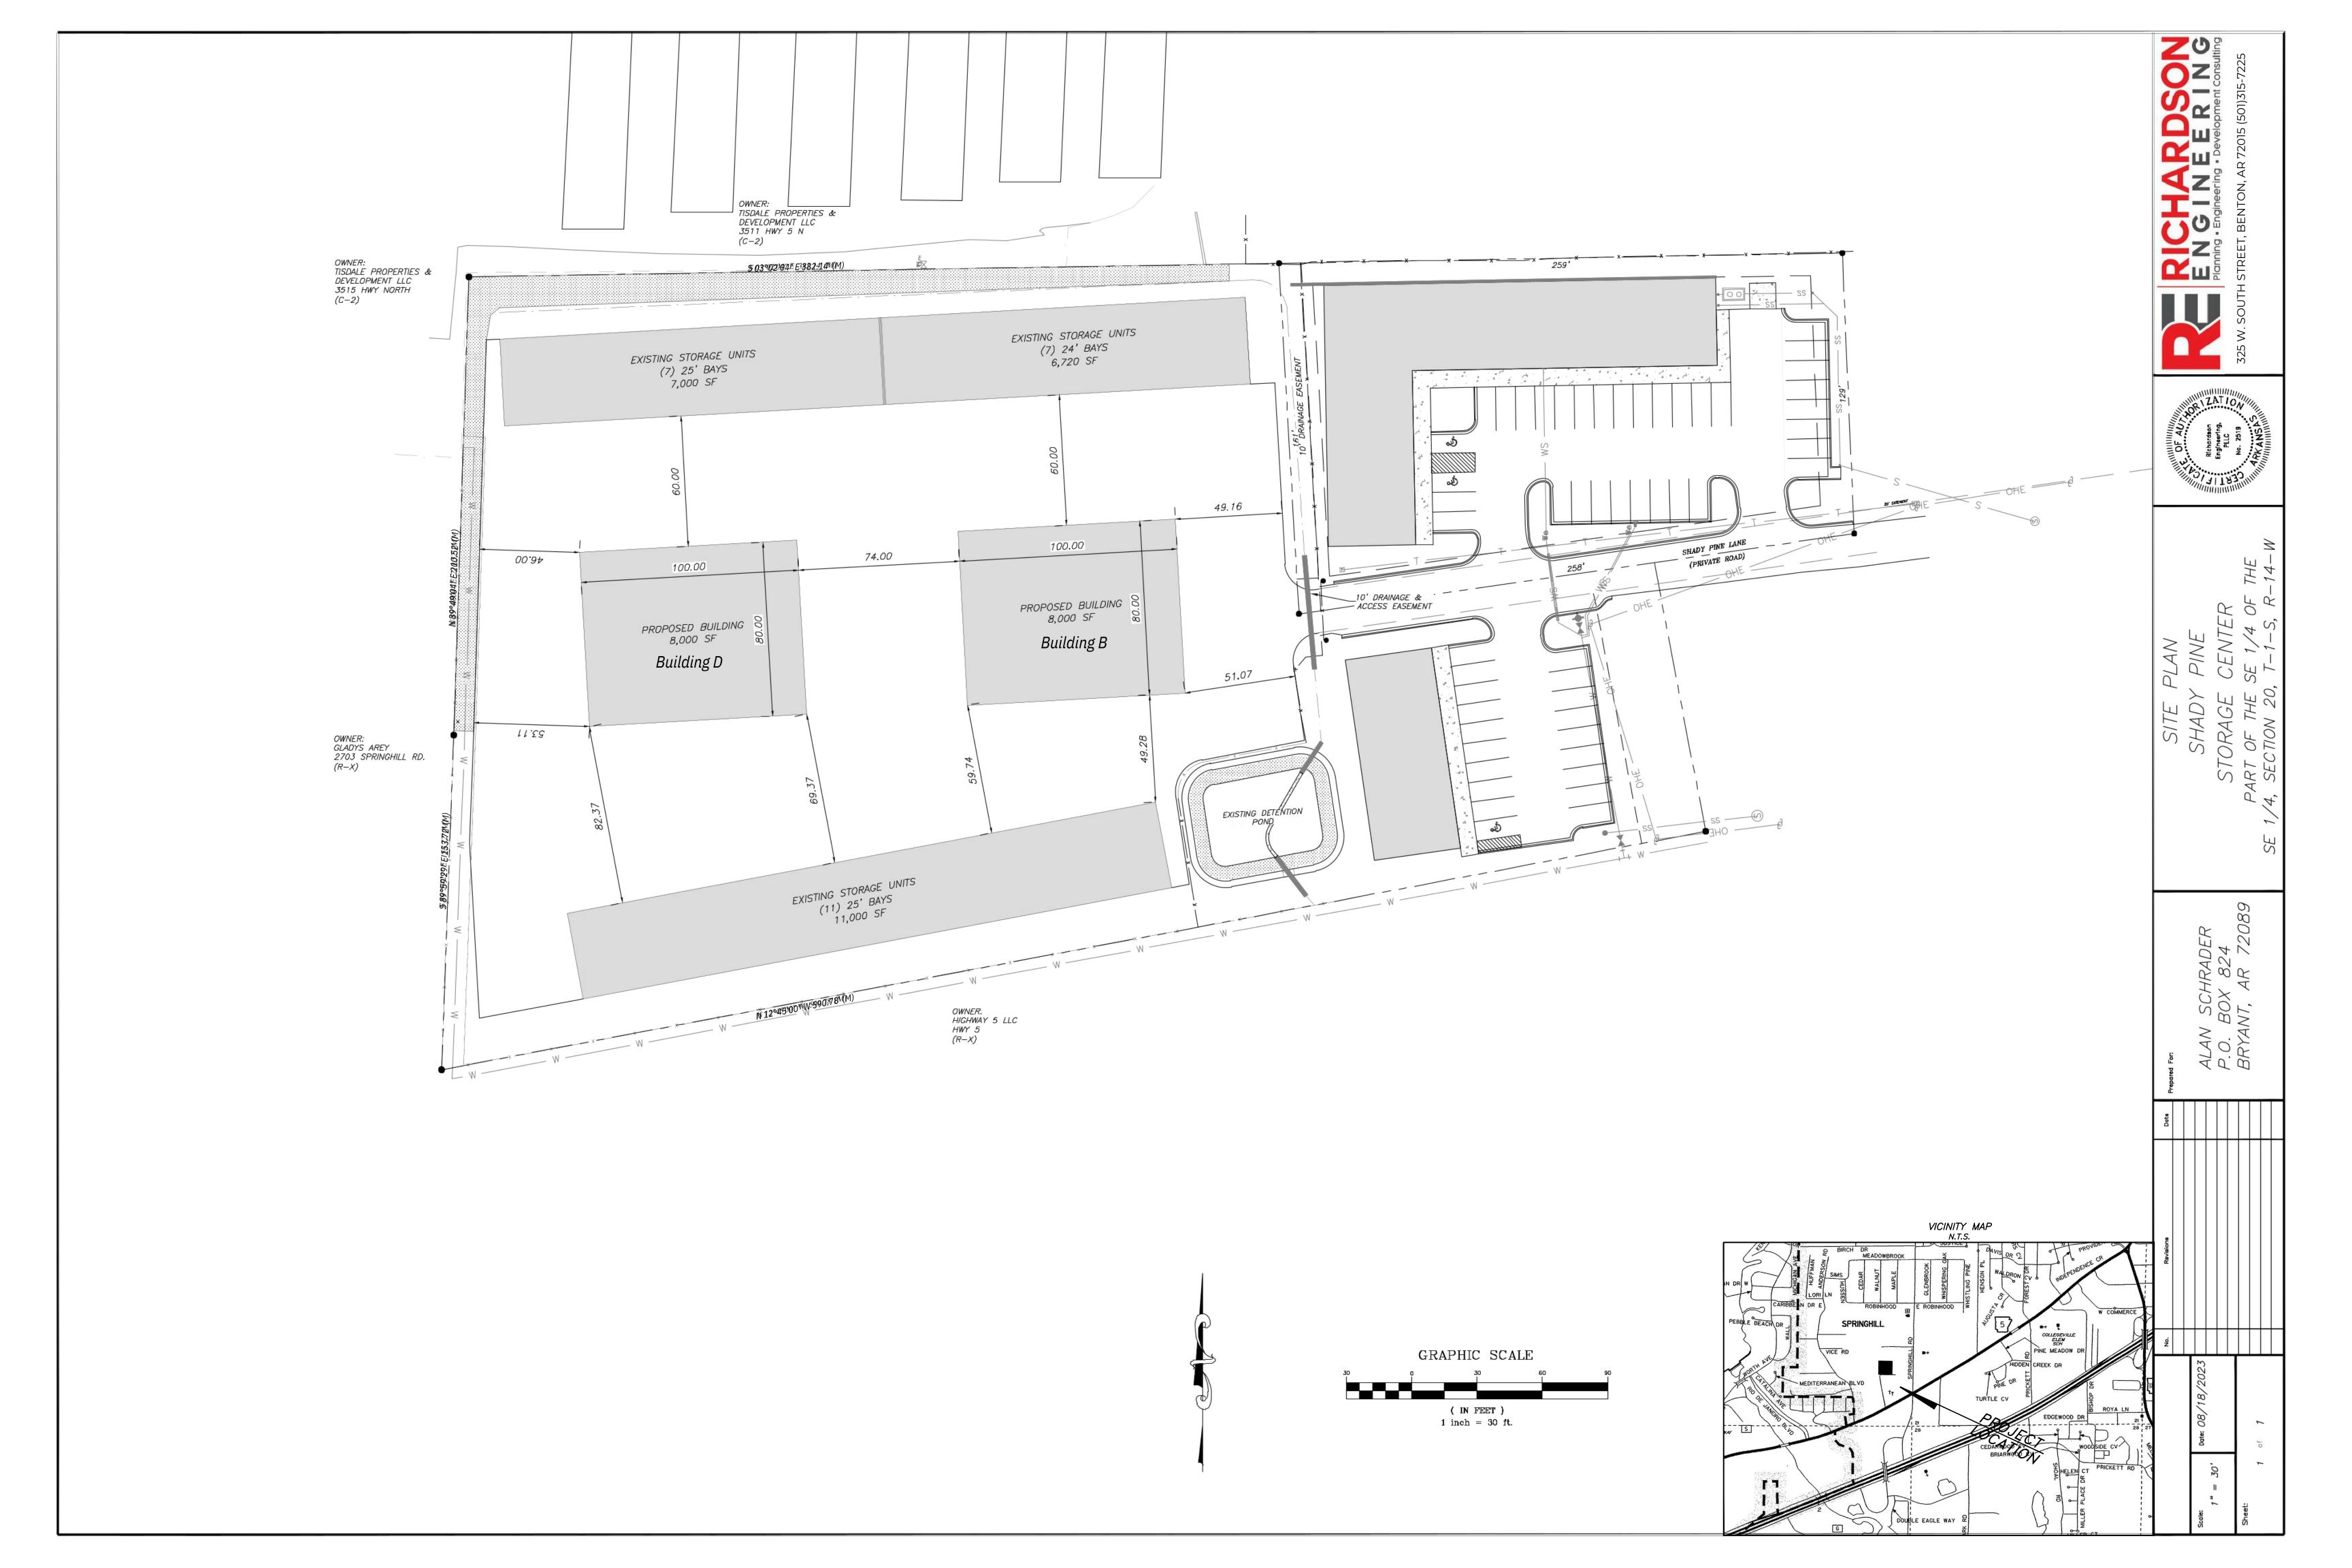

## **GNE**

### **Designing our client's success**

P.O. Box 116

3825 Mt Carmel Rd

Benton, AR 72018

Bryant, AR 72022

Ph (501) 408-4650

garnatengineering@gmail.com

FOR EXCLUSIVE USE & BENEFIT OF:

Name: BART FERGUSON

**LEGEND** 

▲ - Computed point


Found monument

- Set #4 RB/Plas. Cap

(M)-Measured

(R)-Record

(P)-Platted

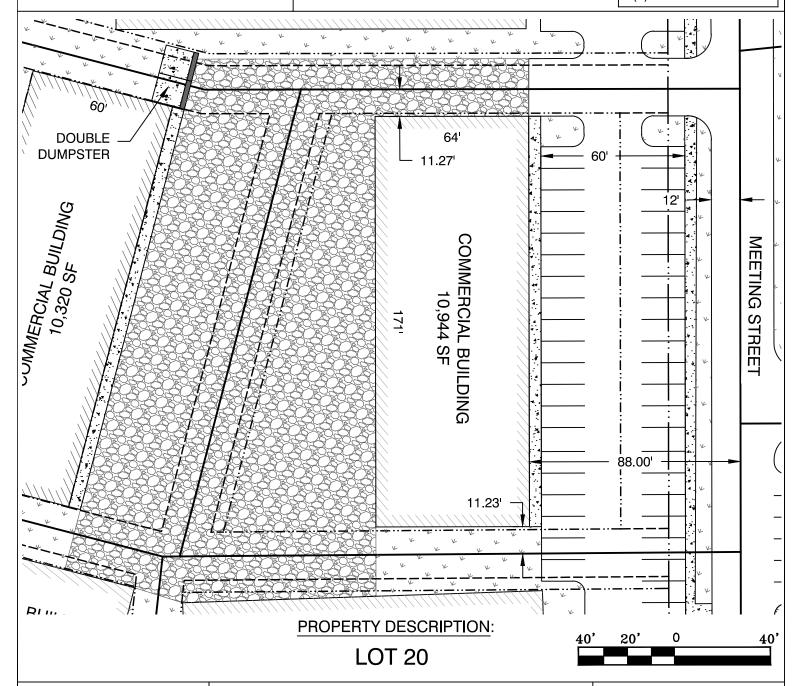

### **JOB NUMBER:**

### 18087 MARKET PLACE II PHASE 3

10/04/23

### **PLOT PLAN**

This Plot Plan depicts the lot as it appears on the subdivision final plat. This drawing does not represent an actual survey.

According the the Federal Emergency Management Agency (FEMA) Flood Insurance Rate Map (FIRM) for Saline County unincorporated areas, panel # 05125C0240E dated JUNE 05, 2020, no portion, dated of the property described hereon does lie within the 100 year flood hazard boundary.



### SBI LETTER OF CERTIFICATION

FERGUSON BUILDERS INC

DATE 8/ 1/23

Reference: 60x172 3419 MEETING ST BRYANT, AR

Job No. SBI36405

To whom it may concern


This is to certify that the above referenced building components furnished by SBI are designed with good engineering practice and in accordance with the order documentation and the applicable structural design provisions set forth in the Applicable MBMA Low Rise Building Systems Manual, the applicable AISC and AISI Manuals, and the IBC 21 code, to sustain the requested design loads, specifically as follows:

Έ,	chieuny as ronous.	
	RISK/Occupancy Category - II - Normal Wind Exposure B	Terrain_Category C Building Enclosure Enclosed
	Live Load (Roof) 20.00 psf Dead Load 2.250 psf	Live Load (Frame) 12 psf Collateral Load 0 psf
	Rain Intensity(5yr) 8.0000 in/hr Rain Intensity(25yr) 11.0000 in/hr	
	Ground snow Pg 10 psf	
	Snow Exposure coeff Ce 1.0000	Thermal Coeff Ct 1.00
	Slippery Roof Coeff Cs Y	Slope Factor coeff 1.0000
	Snow Importance 1.00	Flat Roof Snow Load Pf 7 psf
	Wind Load (Vult) 106 mph	Wind Importance* 1.00
	Wind Load (Vasd) 82.11 mph	
	Cpl_P 0.18	Cpi_S0.18
	Component Loads= 16.000 / -20.083 psf	
	Selsmic Importance 1.00	
	Ss 0.31 S1 0.13 Sds 0.32	Sd1 0.21
	Sdc D Site_Class d	
	Selsmic base shear, longitudinal 9.42 kips	
	Seismic base shear, transverse 5.29 kips	
	FRAME,R 3,2500	
	BRACE_SW.R 3.2500 Cs=(Sds/(I*R))	
	Equivalent Lateral force procedure used	
	Basic seismic resisting systems: Moment frame	s, braced frames, diaphragm
	Special loads: as required (crane loads, mezzo	anine loads, snow drift loads)

\* Wind Importance is not applicable to all building codes. When not prescribed by code, Importance is taken as 1.0 in calculations.

This certification is limited to the structural design of the frames, secondary, and roof/wall covering manufactured by SBI. Accessory Items such as doors, windows, louvers, translucent panels, and ventilators are not included Also excluded are other parts of the project such as masonry, footings, and foundations, mechanical equipment, erection, and general contract work,

DEFLECTION LIMITS WALL GIRT, MAX. DEFL. L/span = 90 ROOF PURLIN, L.L. DEFL. L/span = 180 RIGID FRAME VERT. DEFL. L/span = 180 RIGID FRAME HORIZ, DEFL. H/span = 60

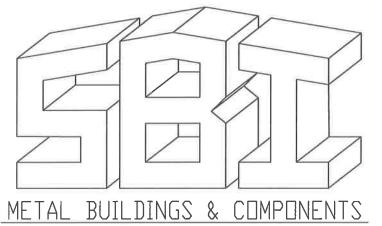

114 Trooper Drive

HOT SPRINGS, ARKANSAS 71913 PH: (501) 262-0600, FAX: (501) 262-5107

### BUILDING DATA:

WIDTH (ft) = 60 LENGTH (ft) = 172 EAVE HEIGHT (ft) = 16 ROOF SLOPE (rise/12") = 1.0:12

FR. SIDEWALL GIRT TYPE = Flush BK. SIDEWALL GIRT TYPE = Flush LT. ENDWALL GIRT TYPE = Flush RT. ENDWALL GIRT TYPE = Flush

= Bypass PURLINS = 8 Rigid Frames, Clear Span ROOF FRAMING INTERIOR FRAMING

ROOF PANEL TYPE = PBR ROOF PANEL GAUGE ROOF PANEL COLOR = 26 = Ash Gray

WALL PANEL TYPE = PBR WALL PANEL GAUGE WALL PANEL COLOR = 26 GA

= CHARCOAL / Black

### SUPPLIED OPTIONS AND ACCESSORIES

GUTTERS AND DOWNSPOUTS FRONT SIDEWALL (ft):172 BACK SIDEWALL (ft) 172 COLOR: Black

FRONT Downspouts 6 BACK Downspouts 6 COLORI Black

ROOF EDGE TRIM = COLOR: Black CORNER TRIM = COLOR: Black OPENING TRIM = COLOR Black BASE TRIM = N\A

WALK DOORS = QTY - SIZE: (8) - 3070M w\ Standard Hardware, prepped for deadbolts

THERE DRAWNGS ATE SUEN AND ARE DEBARD TO BE PA CUSTOALENS RESPONSIBLE. TO PRANNOS ARE THE SOLES HANDS OF THE BRECTOR AN THE BRECTOR AN THE BRECTOR AND THE BRE

ISSUED FOR CONSTRUCTION

ROOF INSULATION = 3" VRR (BY OTHERS)

WALL INSULATION = 3" VRR (BY OTHERS)

LINER PANEL = N\A

CANOPIES \ EXTENSIONS= N\A

PARAPET WALL BACKSHEET = PBR CHARCDAL

ENGINEERING CERTIFICATION:



### REVIEWED

By Philip Perkins at 9:05 am, Sep 07, 2023

### REMARKS/NOTES

PROJECTI	PROJECT: 60×172		BLDG SIZE 60.00' × 172.00' × 16.00'			JDB N	NUMBER
	3419 MEETING ST	DESIGN:	JU' X 1/2.U PP	DRAWN:		SBI36	5405
	BRYANT, AR	DATE	8/ 1/23	CHECK	KU	ACCT#	13797
CUSTOMER	FERGUSON BUILDERS INC	SCALE	NONE	REV, NO		DRAWIN	IG NUMBER
DWG NAME:	DRAWINGS COVER PAGE					SHEET 1	OF 14

### GENERAL NOTES:

1. MANUFACTURING AND FABRICATION PROCEDURES SHALL BE IN ACCORDANCE WITH SBI'S STANDARD PRACTICES WHICH ARE BASED ON THE APPLICABLE SECTIONS RELATING TO DESIGN REQUIREMENTS, ALLOWABLE STRESSES, AND FABRICATION TOLERANCES PER THE LATEST EDITIONS OF 'SBIA-COMMON INDUSTRY PRACTICES' AND 'AISC CODE OF STANDARD PRACTICE' AND THE 'AWS STRUCTURAL WELDING CODES D1.1 & D1.3

2.	MATERIALS	ASTM DESIGNATION	MIN. YIELD
	HOT ROLLED SHAPES	A36	Fy= 36 ksi
	STRUCT. STEEL PLATE	A572	Fy= 55 ksi
	STRUCT. STEEL SHEET	A1011 (SS)	Fy≕ 55 ksi
	FLANGE/END PLATE MA	ATERIAL A529	Fy= 55 ksi
	COLD FORM, LT. GA. S	HAPES A1011 (SS)	Fy= 55 ksi
	ROOF SHEETING	A792 (SS)	Fy= 80 ksi
	WALL SHEETING	A792 (SS) A792 (SS)	Fy= 80 ksi
	MACHINE BOLTS	A307	Fy= 36 ksi
	HIGH STR. BOLTS	F3125 (A325)	Fy= 120 ksi
	ANCHOR BOLTS (if sup	plied) A36/F1554	Fy= 36 ksi
	PIPE (interior or posts	) Á53, GRADE A or B	Fy= 30 ksi
	RECTANGULAR TUBE (i	) Á53, GRADE A or B nterior or posts) A500, GRADI	EB´ Fy= 46 ksi

### 3. PRIMER

SHOP PRIMER PAINT IS A RUST INHIBITIVE PRIMER WHICH MEETS OR EXCEEDS THE END PERFORMANCE OF FEDERAL SPECIFICATIONS TT-P-636 AND TT-P-664 AND IS A RED OXIDE OR GRAY PRIMER. PRIMER IS NOT INTENDED FOR LONG TERM EXPOSURE TO THE ELEMENTS. SBI IS NOT RESPONSIBLE FOR ANY DETERIORATION OF THE SHOP PRIMER AS A RESULT OF IMPROPER HANDLING AND/OR STORAGE. SBI SHALL NOT BE RESPONSIBLE FOR ANY FIELD APPLIED PAINT AND/OR COATINGS. (Section 6.5 AISC Code of Standard Practice, 9th ED.)

### 4. A325 BOLT TIGHTENING REQUIREMENTS

ALL HIGH STRENGTH BOLTS ARE A325—N UNLESS SPECIFICALLY NOTED OTHERWISE. STRUCTURAL BOLTS SHALL BE TIGHTENED BY THE TURN OF NUT METHOD IN ACCORDANCE WITH THE CURRENT EDITION OF THE 'AISC STEEL CONSTRUCTION MANUAL'. A325 BOLTS ARE SUPPLIED WITHOUT WASHERS UNLESS NOTED OTHERWISE. UNLESS NOTED OTHERWISE, ALL BOLTED CONNECTIONS ARE DESIGNED AS BEARING TYPE CONNECTIONS WITH THE BOLT THREADS INCLUDED IN THE SHEAR PLANE.

### 5. ERECTION NOTE: (ERECTION AND UNLOADING NOT BY SBI)

ALL BRACING SHOWN AND PROVIDED BY SBI FOR THIS BUILDING IS REQUIRED AND SHALL BE INSTALLED BY THE ERECTOR AS A PERM—ANENT PART OF THE STRUCTURE. IF ADDITIONAL BRACING IS REQUIRED FOR STABILITY DURING ERECTION, IT SHALL BE THE ERECTOR'S RESPONSIBILITY TO DETERMINE THE AMOUNT OF SUCH BRACING AND TO PROCURE AND INSTALL AS NEEDED.

#### 6. SHORTAGES (SEE SBIA 5.2.1)

THE QUANTITY OF CRATES AND STRUCTURAL ITEMS SHIPPED SHALL BE CHECKED AND ANY SHORTAGES OR OTHER DISCREPANCIES WITH RESPECT THERETO, SHALL BE REPORTED TO SBI ON THE DAY OF DELIVERY AND SUCH DISCREPANCY CONFIRMED IN WRITING WITHIN (7) SEVEN DAYS. WITH RESPECT TO ITEMS OR QUANTITIES WITHIN UNOPENED CRATES AND ANY LATENT DEFECTS, IT SHALL BE THE DUTY OF THE PURCHASER TO NOTIFY SBI ON THE DATE SUCH DEFECT OR SHORTAGE IS DISCOVERED AND CONFIRM SUCH NOTICE IN WRITING TO SBI WITHIN (7) DAYS THEREOF.

### 7. CORRECTIONS OF ERRORS AND REPAIRS (SEE SBIA 6.10)

CLAIMS FOR CORRECTION OF ALLEGED MISFITS WILL BE DISALLOWED UNLESS SBI SHALL HAVE RECEIVED PRIOR NOTICE THEREOF AND ALLOWED REASONABLE INSPECTION OF SUCH MISFITS. THE CORRECTION OF MINOR MISFITS BY USE OF DRIFT PINS TO DRAW THE COMPONENTS INTO LINE, MODERATE AMOUNTS OF REAMING, SHIMMING, CHIPPING AND CUTTING, AND THE REPLACEMENT OF MINOR SHORTAGES OF MATERIAL ARE A NORMAL PART OF ERECTION AND ARE NOT SUBJECT TO CLAIM. NO PART OF THE BUILDING MAY BE RETURNED FOR ALLEGED MISFITS WITHOUT THE PRIOR APPROVAL OF SBI

### GENERAL NOTES (CONT.):

8. <u>CLOSURE STRIPS ARE FURNISHED FOR APPLICATION</u>
INSIDE — Under roof panels at eave.
OUTSIDE — Between endwall panels and rake trim.

— Under continuous ridge vent skirts. Note: Conditions vary at hips, valleys, fascias, mansards and canopies. Refer to Erection Drawings.

### 9. VERTICAL DEFLECTION OF RIGID FRAMES

Buildings which are loaded in regions of the country where snow and ice accumulation may occur should be aware that purlins and rigid frames particularly long span frames, will deflect vertically when subjected to snow and ice loads. two areas which require special precaution during interior erection and are greatly affected by vertical deflection, should be carefully considered:

- 10.) Metal Studs should never be attached directly to rigid frames or purlins without slotted vertical clips. Even a small vertical deflection can cause a metal stud to bow out significantly.
- 11.) Care should be taken when supporting acoustical or other type hanging ceiling tiles from purlins and rigid frames. In hallways or small rooms the tiles should be supported from the permanent walls and partitions rather then the purlins. In larger rooms where the ceiling must be supported from the roof system, it is important to allow the ceiling to deflect at the outside walls at the same rate it deflects in the center of the room. If the ceiling is supported continuously along any non—ylelding wall while rest of the ceiling is deflecting, obvious problems occur.

### 12. ROOF PENETRATION WARRANTY CONSIDERATIONS

If a weather tightness warranty is to be provided for your project, SBI requires that the roof curbs and decktights be pre-approved by SBI. All roof curbs must be compatible with the roof panel. The roof curbs should have male and female side ribs and water diverters at the upslope side of the roof curbs. The following manufactures are currently pre-approved:

Web Site Phone Manufacturer Location Longview, TX Imcurbs.com 800-284-1412 LM Curbs Buildex itwbuildex.com varies Dyna-Flash varies dynamicfastener.com itwbuildex.com Dek-Tite varies

### 10. SEAMER RENTAL INFORMATION

SBI utilizes Quality Roof Seamers Inc. for all seamer rental needs. It is your responsibility to obtain seamer rental for your project needs unless otherwise stated in the contract documents. Contact information follows:

Quality Roof Seamers Inc. 8265 MS—178 Olive Branch, MS 38654 (622) 895—1222 http://www.qualityroofseamers.com/

Direct Rental Addresse: http://www.qualityroofseamers.com/manufacture/60-sbi-metal-buildings

### **REVIEWED**

By Philip Perkins at 9:05 am, Sep 07, 2023





### BUYER/END USE CUSTOMER RESPONSIBILITIES


- It is the responsibility of the BUYER/END USER to obtain appropriate approvals and secure necessary permits for City, County, State, or Federal Agencies as required, and to advise/release SBI to proceed to fabricate upon receiving such.
- 2. SBI's standard specifications apply unless stipulated otherwise in theContract Documents. SBI's design, fabrication, quality criteria, standards, practices, methods, and tolerances shall govern the work with any other interpretations to the contrary notwithstanding. It is understood by both Parties that the BUYER/END USER is responsible for clarification of inclusions or exclusions from the architectural plans and/or specifications.

SBI is not responsible for any testing of welds, screws, bolts, etc... Any testing including non—destructive testing of welds is the responsility of the Buyer/End User to procure. SBI standards for quality control of welds is visual inspection during fabrication.

- 3. In case of discrepancies between SBI's structural steel plans and plans for other trades, SBI's plans shall govern. (Section 3, AISC Code of Standard Practices, 9th edition)
- Approval of SBI drawings and calculations indicates that SBI has correctly interpreted and applied the Contract Documents. This approval consitutes the contractor/owners acceptance of the SBI's design concepts, assumptions, and loading. (Section 4 AISC Code and SBIA 3.3.3)
- 5. Once the BUYER/END USER has signed SBI's Approval Package and the project is released for fabrication, changes shall be billed to the BUYER/END USER Including material, engineering, and other cost. An additional fee may be charged if the project must be moved from the fabrication and shipping sched...
- 6. The BUYER/END USER is responsible for overall project coordination. All Interface, compatibility, and design considerations concerning any materials not furnished by SBI are to be considered and coordinated by the BUYER/END USER. Specific design criteria concerning this interface between materials must be furnished before release for fabrication or SBI's assumptions will govern. (Section 4 and Commentary, AISC)
- 7. It is the responsibility of the BUYER/END USER to insure that SBI's plans comply with the applicable requirements of any governing building authorities. The supplying of sealed engineering data and drawings for the metal building system does not imply or constitute an agreement that SBI or its design engineers are acting as the 'Engineer of Record' or 'Design Professional' for a construction project. These drawings are sealed only to certify the design of the structural components furnished by SBI.
- 8. The BUYER/END USER is responsible for setting of anchor bolts and erection of steel in accordance with SBI's "FOR CONSTRUCTION" drawings only. Temporary supports such as guys, braces, falsework, cribbing or other elements required for the erection operation shall be determined and furnished and installed by the erector. No items should be purchased from a preliminary set of drawings, including anchor bolts. Use only final "FOR CONSTRUCTION" drawings for this use. (Section 7 AISC Code)
- 9. SBI is responsible for the design of the anchor bolt to permit the transfer of forces between the base plate and the anchor bolt in shear, bearing, and tension, but is not responsible for the transfer of anchor bolt forces to the concrete or the adequacy of the anchor bolt in relation to the concrete. Unless otherwise provided in the Order Documents, SBI does not design and is not responsible for the design, material and construction of the foundation or foundation embedments, The BUYER/END USER should assure himself that adequate provisions are made in the foundation design for loads imposed by column reactions of the building, other imposed loads, and bearing capacity of the soil and other conditions of the building site. It is recommended that the anchorage and foundation of the building be designed by a Registered Professional Engineer experienced in the design of such structures. (Section 3.2.2 SBIA Low Rise Building Systems Manual)
- 10. Normal erection operations include the corrections of minor misfits by moderate amounts of reaming, chipping, welding, or cutting, and the drawing of elements into line through the use of drift pins. Errors which cannot be corrected by the foregoing means or which require major changes in member design are to be reported immediately to SBI by the BUYER/END USER, to enable whoever is responsible either to correct the error or to approve the most efficient and economic method of correction to be used by others. (Section 6—10 SBIA Manual)
- 11. Neither the fabricator nor the BUYER/END USER will cut, drill, or otherwise alter his work, or the work of other trades, to accommodate other trades, unless such work is clearly specified in the contract documents. Whenever such work is specified the BUYER/END USER is responsible for furnishing complete information as to materials, size, location, and number of alterations prior to preparation of shop drawings. (Section 7 "AISC Code, SBIA Manual Section 8.6)
- 12. WARNING: In no case should Aluminized Zinc steel panels be used in conjunction with lead or copper. Runoff from these materials are highly corrosive to the Aluminum Zinc coatings.
- 13. SAFETY COMMITMENT: SBI has a commitment to manufacture quality building components that can be safely erected. However, the safety commitment and job site practices of the erector are beyond the control of SBI. It is strongly recommended that safe working conditions and accident prevention practices be the top priority of any job site. Make sure that all Local, State, and Federal safety and health stand—ards are always followed. Insure that employees are aware and trained in emergency procedures.
- 14. Please note OSHA now requires the first girt placed in all lapping conditions be firmly attached prior to placing the second lapped girt.

## ISSUED FOR AND ARE DEBURD TO BE FINAL DRAWNOR IN 19 THE CONSTRUCTION HANDS OF THE SPECIAL DRAWNOR IN 19 THE CONSTRUCTION HANDS OF THE SPECIAL DRAWNOR IN THE TRACES OF THE SPECIAL DRAWNOR IN THE TRACES

OT 40 TT TOO TOTAL TRACES ON THE PROJECT SITE					
PROJECT: 60x172	BLDG SIZE:	JOB NUMBER			
	60.00' x 172.00	The second	CD170405		
3419 MEETING ST	DESIGN:	DRAWN: RH	SBI36405		
BRYANT, AR	DATE: 8/ 1/23	CHECK:			
CUSTOMER: FERGUSON BUILDERS INC	SCALE: NONE	REV. NO:	DRAWING NUMBER		
DWG NAME: GENERAL NOTES			SHEET 2 OF 14		

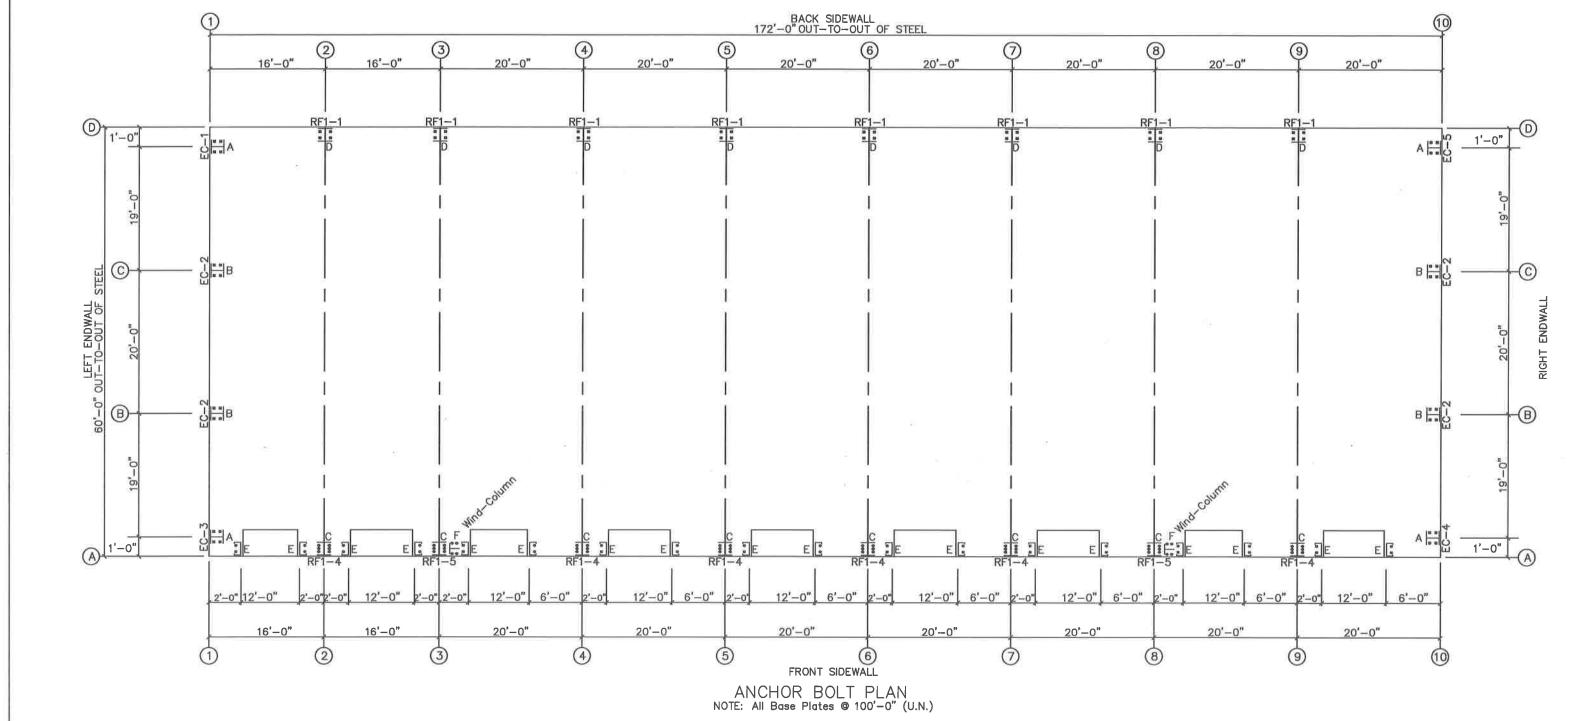



### **REVIEWED**


By Philip Perkins at 9:05 am, Sep 07, 2023

## ISSUED FOR


THESE DRAWINGS ARE SUBMITTED FOR CONSTRUCTION, AND ARE DESMED TO BE FINAL DRAWINGS, IT IS THE CUSTOMERS OF SUBMIC THESE SET OF DRAWINGS ARE THE SOLE SET OF DRAWINGS IN THE HANDS OF THE RECTION AND OTHER PROPESSIONAL TRADES ON THE PROJECT SITE.


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METAL BUILDINGS & COMPONENTS	
114 TROOPER DRIVE	С
HOT SPRINGS, ARKANSAS 71913 PH: (501) 262-0600, FAX: (501) 262-5107	D

PROJECT: 60x172	BLDG SIZE: 60.00' x 172.00' x 16.00'		JOB NUMBER
3419 MEETING ST	DESIGN:	DRAWN: RH	SBI36405
BRYANT, AR	DATE: 8/ 1/23	CHECK:	
CUSTOMER: FERGUSON BUILDERS INC	SCALE: NONE	REV. NO:	DRAWING NUMBER
OWG NAME: ANCHOR BOLT PLAN & DETA	All S		SHEET 3 OF 14

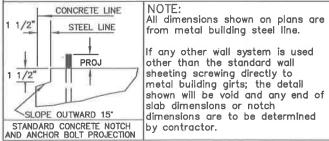



If any other wall system is used other than the standard wall sheeting screwing directly to metal building girts; the detail shown will be void and any end of slab dimensions or notch dimensions are to be determined by contractor.

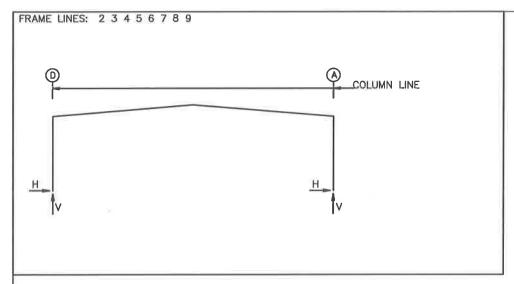

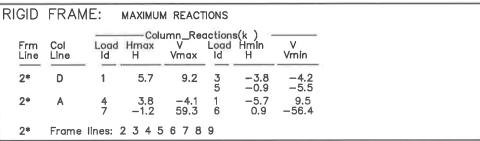

#### ENDWALL COLUMN: MAXIMUM REACTIONS -Column\_Reactions(k ) nax V Load Hmin Frm Load Hmax Line Vmax Н Vmin Line D -0.2 2.4 -0.2 0.2 0.2 9 10 -0.5 -0.1 5.7 -1.412 1.2 В 1.2 -0.1 5.7 8 14 -1.0 1.2 -1.3 -1.4 -0.2 0.2 -0.2-0.50.2 2.4 -0.59 10 -0.2-0.610 0.2 -0.3 2.6 10 12 -1.6 -1.7 10 В 16 1.2 -1.01.2 0.2 6.3 -1.0 1.2 -1.6 -1.7 10 1.2 8 14 0.1 10 D 10 0.2 15 -0.6

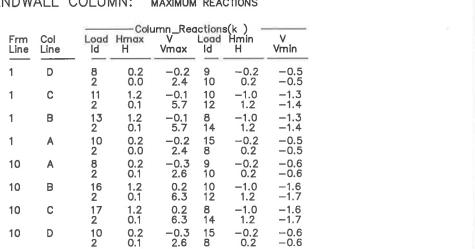

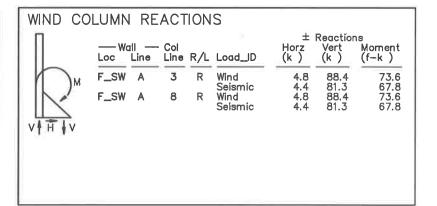

= 00.0 = 172.0 = 16.0/10 = 1.0/1.0 = 2.3 = 0.0

20.0 12.0

= 106.0 = IBC 21

= Enclosed

= 1.00 = 1.00

= D= 0.49

16.0

NOTES FOR REACTIONS

Building reactions are based on the following building data:

Width (ft)
Length (ft)
Eave Height (ft)
Roof Slope (rise/12)
Dead Load (psf)
Collateral Load (psf)
Roof Live Load(psf)
Frame Live Load(psf)
Snow Load (psf)

Snow Load (psf ) Wind Speed (mph Wind Code

Importance Wind

Importance Seismic Seismic Zone Seismic Coeff (Fg\*Ss)

Dead+Collateral+Live

Dead+Collateral+Snow+Snow\_Drift 0.6Dead+0.6Wind\_Left1

0.6Dead+0.6Wind\_Right1 0.6Dead+0.6Wind\_Long1L 0.6Dead+0.6Wind\_Long2L 1.05Dead+1.05Collateral+0.7Seismic\_LongR

0.6Dead+0.6Wind\_Pressure+0.6Wind\_Long2L

0.6Dead+0.6Wind\_Suction+0.6Wind\_LongIL 0.6Dead+0.6Wind\_Pressure+0.6Wind\_LongIL 0.6Dead+0.6Wind\_Right2+0.6Wind\_Suction 0.6Dead+0.6Wind\_Left1+0.6Wind\_Suction

0.6Dead+0.6Wind\_Left2+0.6Wind\_Suction 14 0.6Dead+0.6Wind\_Right1+0.6Wind\_Suction 15 0.6Dead+0.6Wind\_Suction+0.6Wind\_Long2L 16 Dead+0.6Wind\_Right2+0.6Wind\_Suction 17 Dead+0.6Wind\_Left2+0.6Wind\_Suction

Exposure Closure

ID Description

### BUILDING BRACING REACTIONS ± Reactions(k ) Panel\_Shear —Wind — —Seismic — (lb/ft) Horz Vert Horz Vert Wind Seis I -Wall -- Col Loc Line Line L\_EW 1 F\_SW A R\_EW 10 B\_SW D (g)Wind column at column line (i)Bracing in roof to rigid frame Reactions for seismic represent shear force, Eh

### GENERAL NOTES

- 1. METAL BUILDING MANUFACTURER ASSUMES NO RESPONSIBILITY OR LIABILITY FOR FOUNDATION DESIGN OR CONSTRUCTION
- 2. THE FOUNDATION DESIGN SHOULD BE DONE WITH DUE REGARD TO EXISTING SOILS CONDITIONS FOR THE DESIGN LOADS AT THE ACTUAL JOB SITE.
- 3. ANCHOR BOLT DIAMETERS WERE DETERMINED
- BY THE AISC ALLOWABLE SHEAR—TENSION
  METHOD USING (Fy = 36 ksl)


  4. ANCHOR BOLT LENGTH & METHOD OF TRANSFER
  OF FORCES FROM ANCHOR BOLTS TO THE
  FOUNDATION ARE TO BE DETERMINED BY OTHERS.IT IS RECOMMENDED THAT AN EXPERIENCED DESIGN PROFESSIONAL DETERMINE THIS METHOD.
- 5. BOTTOMS OF ALL BASE PLATES ARE AT THE SAME ELEVATION UNLESS NOTED.
- 6. ANCHOR BOLTS ARE NOT SUPPLIED BY THE METAL BUILDING MANUFACTURER. 7. IT IS THE RESPONSIBILITY OF THE ERECTOR TO PROVIDE FOR ALL TEMPORARY BRACING AS WELL AS A PLAN FOR INSTALLING IT. THIS INCLUDES SIZES, TYPE, LOCATION, AND QUANTITY.

## ISSUED FOR

THESE DRAWINGS ARE SUBMITTED FOR CONSTRUCTION, AND ARE DESARD TO BE FRAL DRAWINGS, IT IS THE CUSTOMET'S RESPONSELTY TO ENSURE THIS SET OF DRAWINGS ARE THE SOLE SET OF DRAWINGS IN THE HANDS OF THE STECTOR AND OTHER PROFESSIONAL TRACES ON THE PROJECT SITE.



ANC	HOR BOI	_T SL	IMMA	RY.
Qty	Locate	Dia (in)	Туре	Proj (in)
O 36 32 32 48 48 8	Jamb Endwall Frame Frame WindCol	1/2" 3/4" 3/4"	Wedge F1554 F1554 F1554 F1554	3,00

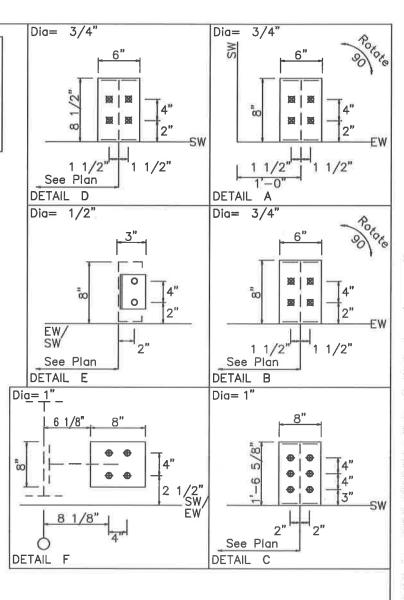




### **REVIEWED**

By Philip Perkins at 9:05 am, Sep 07, 2023

PROJECT: 60x172	BLDG SIZE: 60.00' x 172.00'	x 16.00'	JOB NUMBER
3419 MEETING ST	DESIGN:		SBI36405
BRYANT, AR	DATE: 8/ 1/23	CHECK:	
CUSTOMER: FERGUSON BUILDERS INC	SCALE: NONE	REV. NO:	DRAWING NUMBER
DWG NAME: ANCHOR BOLT DETAILS & R	EACTIONS		SHEET 4 OF 14

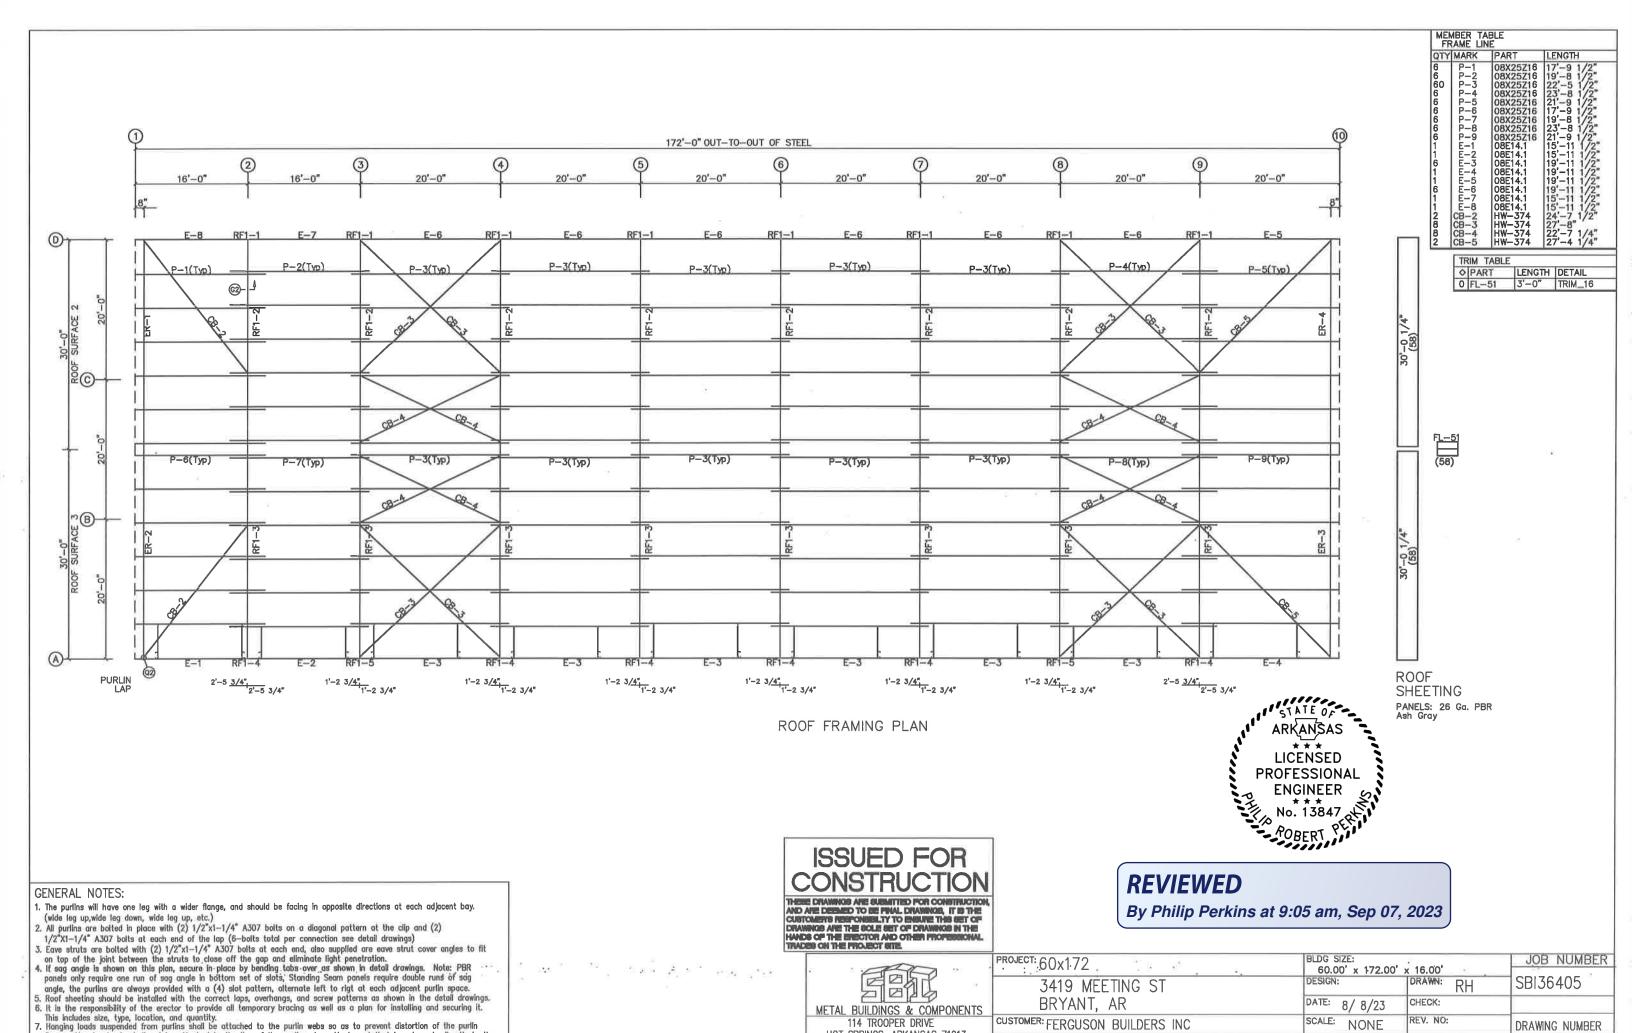

114 TROOPER DRIVE

HOT SPRINGS, ARKANSAS 71913

PH: (501) 262-0600, FAX: (501) 262-5107

DWG NAME: ROOF FRAMING

DRAWING NUMBER


SHEET 5 OF 14


5. Roof sheeting should be installed with the correct lops, overhangs, and screw patterns as shown in the detail drawings.

6. It is the responsibility of the erector to provide all temporary bracing as well as a plan for installing and securing it.

This includes size, type, location, and quantity.

7. Hanging loads suspended from purifies shall be attached to the purlin webs so as to prevent distortion of the purifin flanges. Hanging loads shall not be attached to the lips of the purlins. Any attachment that is not made directly to the purlin web shall be submitted for review. In no case shall the load applied to a single purlin exceed 150 lb.

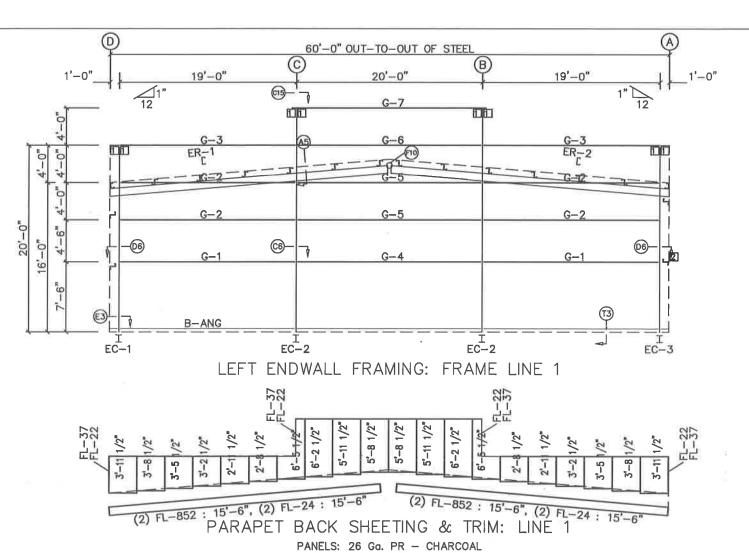

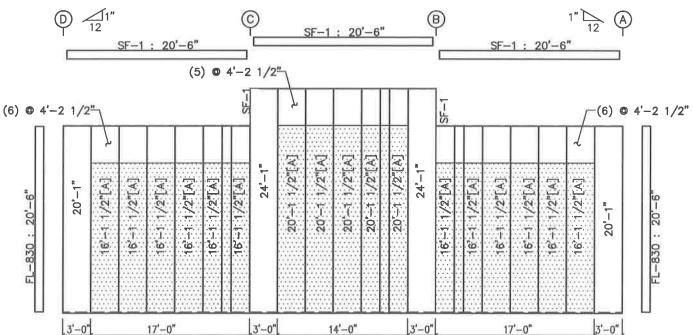

LEFT ENDWALL SHEETING & TRIM: FRAME LINE 1

PANELS: 26 Ga. PR - BLACK [A] PANELS: 26 Ga. PR - CHARCOAL

**GENERAL NOTES:** 

includes size, type, location, and g'ty.

1. Sheets on buildings with roof slopes greater than 1-1/4"/12" must be field cut to cope with slope of roof.

2. Screw patterns for sheeting shall be to use 3ea screws at the bottom, top, and at each girt. Space these screws equally at about 1" off of each panel rib. Lap screws should be placed at bottom, top, each girt, two (2) equally spaced between base and first girt, and one (1) at the midpoint between all other girts.

Tek5 Drillers are supplied as needed for non secondary steel.

3. Man doors are to be field located per customer and contractor shall install door frame stiffener angles on the back of each "lock-side" of jambs at at approx, 3"-4" up on frames down to base angle (channel) at 30-45deg. Extra base angle supplied for contractor to field cut as needed.

4. All girts are botted in place with (2) 1/2"x1-1/4" A307 bolts on a diagonal pattern at the clip and (2) 1/2"X1-1/4" A307 bolts at each end of the lap (6-bolts total per connection see detail drawings)

5. It is the responsibility of the erector to provide all temporary bracing and a plan for installing it. This includes size, type, location, and a'ty.

#### PROJE 0 METAL BUILDINGS & COMPONENTS 114 TROOPER DRIVE CUSTO HOT SPRINGS, ARKANSAS 71913 DWG N PH: (501) 262-0600, FAX: (501) 262-5107

ECT: 60x172	BLDG SIZE: '60.00' x-172.00'	(16.00'	JOB NUMBER.
3419 MEETING ST	DESIGN:	DRAWN: RH	SBI36405
BRYANT, AR	DATE: 8/ 8/23	CHECK:	
OMER: FERGUSON BUILDERS INC	SCALE: NONE	REV. NO:	DRAWING NUMBER
NAME: ENDWALL FRAMING			SHEET 6 OF 14

BOLT TABLE FRAME LINE 1 LOCATION ER-1/ER-2 Columns/Raf

TRIM TABLE
FRAME LINE
OID MARK
FL-830
FL-24
FL-852
FL-22
FL-37
4
SF-1
2 DETAIL
TRIM\_12
TRIM\_87
TRIM\_87
TRIM\_18
TRIM\_13
TRIM\_87

	IBER TAE		
QTY	MARK	PART	LENGTH
1 2 1 1 1 2 4 2 1 2 1	EC-1 EC-2 EC-3 ER-1 ER-2 G-2 G-3 G-4 G-5 G-7	W08641 W08641 W08641 10x25c12 10x25c12 08X25Z14 08X25Z16 08X25Z16 08X25Z16 08X25Z16 08X35Z14 08X25Z16	19'-9 1/4" 23'-9 1/4" 19'-9 1/4" 30'-1 1/4" 30'-1 1/4" 18'-5 1/2" 18'-5 1/2" 19'-5 1/2" 19'-5 1/2" 19'-5 1/2" 20'-7 1/2"

CONNECTION PLATES
FRAME LINE 1
DID QUAN MARK/PART
1 8 b2
2 1 ZGF


## ISSUED FOR

AND AFE DESIGN TO BE FINAL DRAWNOR, IT IS THE CUSTOMER'S RESPONSELTLY TO ENSURE THIS SET OF DRAWNOR AFE THE SOLE SET OF DRAWNOR IN THE HANDS OF THE EVECTOR AND OTHER PROPERSIONAL TRADES ON THE PROJECT SITE.



## **REVIEWED**

By Philip Perkins at 9:05 am, Sep 07, 2023

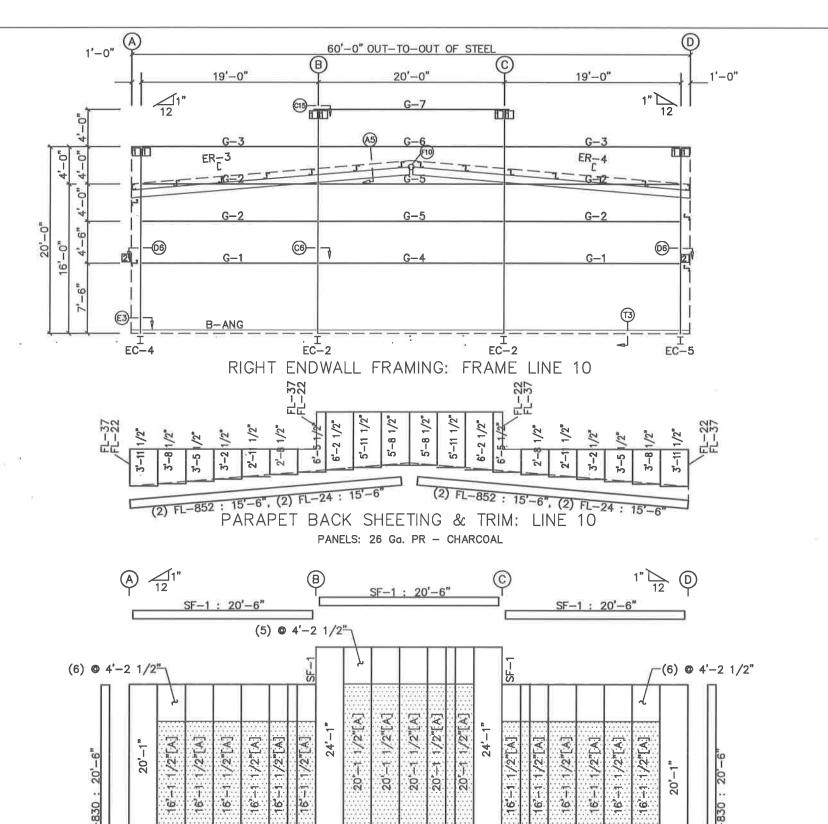

LEFT ENDWALL SHEETING & TRIM: FRAME LINE 10

PANELS: 26 Ga. PR - BLACK

[A] PANELS: 26 Ga. PR - CHARCOAL

17'-0"

BOLT TABLE FRAME LINE 10 LOCATION ER-3/ER-4 Columns/Raf TRIM TABLE FRAME LINE ◇ID MARK FL-830 FL-24 FL-852 FL-22 FL-37 SF-1 DETAIL
TRIM\_12
TRIM\_87
TRIM\_87
TRIM\_18
TRIM\_18
TRIM\_13
TRIM\_87 MEMBER TABLE FRAME LINE 10 QTY MARK LENGTH PART W08641 W08641 W08641 10x35c12 10x35c12 ER-3

08X25Z14 08X25Z16 08X25C16 08X25Z14 08X25Z16 08X35Z14

08X25C16

G-1 G-2 G-3 G-4 G-5 G-6

DRAWINGS ARE THE SOLE SET OF DRAWINGS IN THE HANDS OF THE EFECTOR AND OTHER PROFESSIONAL TRADES ON THE PROJECT SITE.



### **REVIEWED**

By Philip Perkins at 9:05 am, Sep 07, 2023

### **GENERAL NOTES:**

- GENERAL NOTES:

  1. Sheets on buildings with roof slopes greater than 1-1/4"/12" must be field cut to cope with slope of roof.

  2. Screw patterns for sheeting shall be to use 3ea screws at the bottom, top, and at each girt. Space these screws equally at about 1" off of each panel rib. Lap screws should be placed at bottom, top, each girt, two (2) equally spaced between base and first girt, and one (1) at the midpoint between all other girts. Tek5 Drillers are supplied as needed for non secondary steel.

  3. Man doors are to be field located per customer and contractor shall install door frame stiffener angles on the back of each "lock-side" of jambs at at approx. 3"-4" up on frames down to base angle (channel) at 30-45deg. Extra base angle supplied for contractor to field cut as needed.


  4. All girts are botted in place with (2) 1/2"x1-1/4" A307 bolts on a diagonal pattern at the clip and (2) 1/2"x1-1/4" A307 bolts at each end of the lap (6-bolts total per connection see detail drawings)

  5. It is the responsibility of the erector to provide all temporary bracing and a plan for installing it. This includes size, type, location, and a'ty.

- includes size, type, location, and g'ty.

200 METAL BUILDINGS & COMPONENTS 114 TROOPER DRIVE HOT SPRINGS, ARKANSAS 71913 PH: (501) 262-0600, FAX: (501) 262-5107

PROJECT: 60x172 3419 MEETING ST	BLDG SIZE: . 60.00' x 172.00' DESIGN:	x 16.00'	JOB NUMBER SBI36405
BRYANT, AR	DATE: 8/ 8/23	CHECK:	
CUSTOMER: FERGUSON BUILDERS INC	SCALE: NONE	REV. NO:	DRAWING NUMBER
DWG NAME: ENDWALL FRAMING			SHEET 7 OF 14

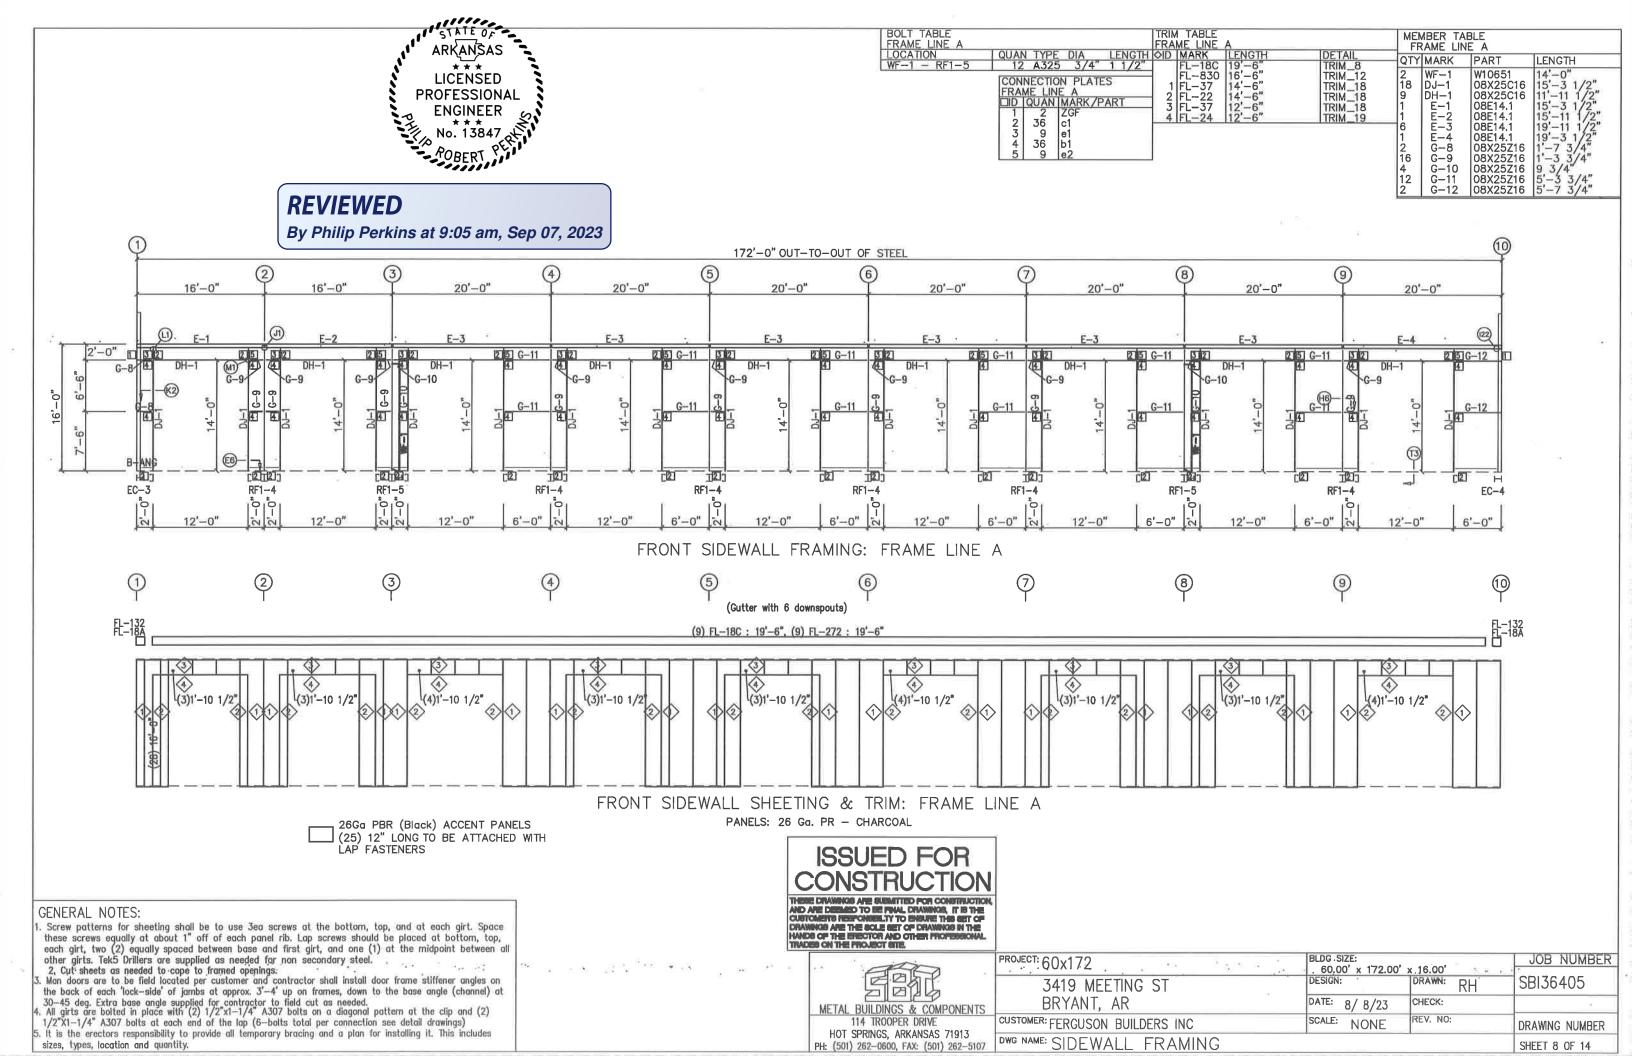

ARKANSAS

LICENSED

PROFESSIONAL

ENGINEER


No. 13847

POBERT

### **REVIEWED**

By Philip Perkins at 9:05 am, Sep 07, 2023

	MBER TAE		
QTY	MARK	PART	LENGTH
1 6 1 1 1 1 6 6 2 2 4	E-5 E-6 E-7 E-8 G-13 G-14 G-15 G-16 G-17 G-18 CB-1	08E14.1 08E14.1 08E14.1 08E14.1 08X25Z14 08X25Z16 08X25Z16 08X25Z16 08X25Z16 08X25Z16 08X25Z16	19'-3 1/2" 19'-11 1/2" 15'-11 1/2" 15'-3 1/2" 19'-7 1/2" 19'-7 1/2" 19'-3 1/2" 15'-3 1/2" 15'-7 1/2" 25'-4"

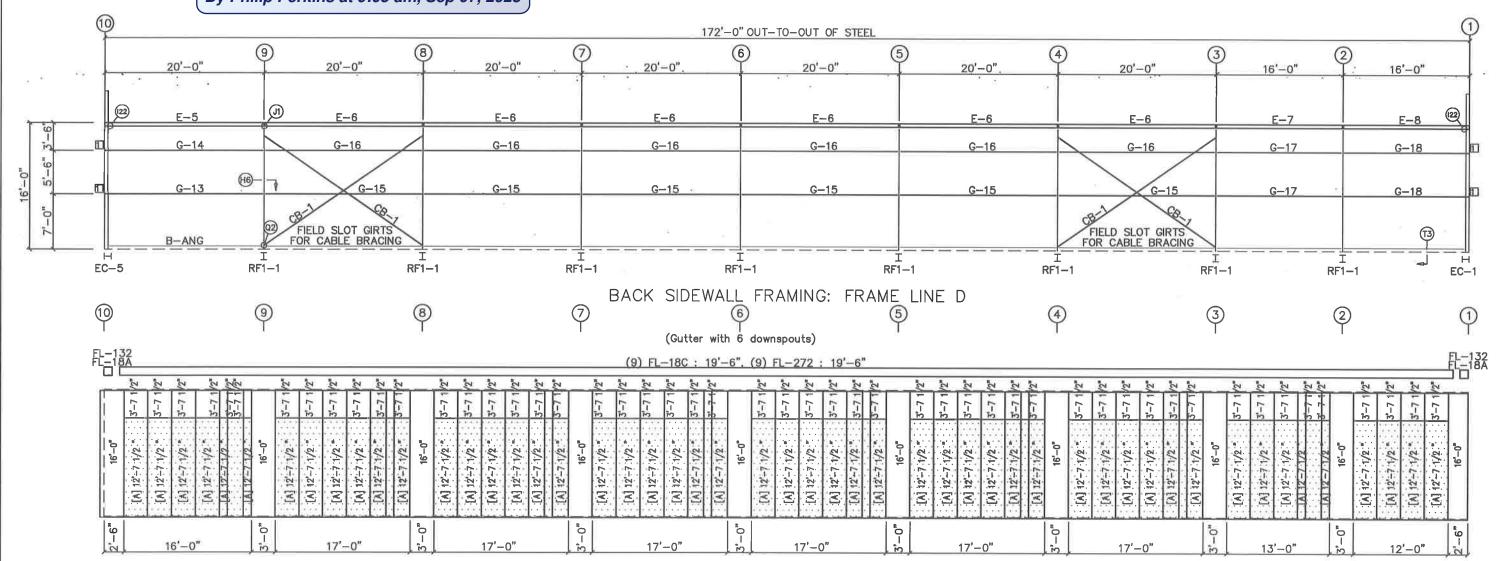

### GENERAL NOTES:

1. Screw patterns for sheeting shall be to use 3ea screws at the bottom, top, and at each girt. Space these screws equally at about 1" off of each panel rib. Lop screws should be placed at bottom, top, each girt, two (2) equally spaced between base and first girt, and one (1) at the midpoint between all other girts. Tek5 Drillers are supplied as needed for non secondary steel.
2. Cut sheets as needed to cope to framed openings.

3. Man doors are to be field located per customer and contractor shall install door frame stiffener angles on the back of each 'lock-side' of jambs at approx. 3'-4' up on frames, down to the base angle (channel) at 30-45 deg. Extra base angle supplied for contractor to field cut as needed.

30-45 deg. Extra base angle supplied for contractor to field cut as needed.

4. All girts are bolted in place with (2) 1/2"x1-1/4" A307 bolts on a diagonal pattern at the clip and (2) 1/2"X1-1/4" A307 bolts at each end of the lap (6-bolts total per connection see detail drawings)

5. It is the erectors responsibility to provide all temporary bracing and a plan for installing it. This includes sizes, types, location and quantity.

BACK SIDEWALL SHEETING & TRIM: FRAME LINE D PANELS: 26 Ga. PR - BLACK


[A] PANELS: 26 Ga. PR — CHARCOAL


## ISSUED FOR CONSTRUCTION

THESE DRAWINGS ARE SUBMITTED FOR CONSTRUCTION, AND ARE DESIGNED TO BE IPHAL DRAWINGS, IT IS THE CUSTOMER'S RESPONSIBLITY TO ENGAGE THE SET OF DRAWINGS ARE THE SOLE SET OF DRAWINGS AND THE HANDS OF THE EFECTION AND OTHERS PROPESSIONAL TRADES ON THE PROJECT SITE.


METAL BUILDINGS & COMPONENTS	1
114 TROOPER DRIVE	1
HOT SPRINGS, ARKANSAS 71913	ŀ
PH: (501) 262-0600, FAX: (501) 262-5107	l

ROJECT: 60x172	BLDG SIZE: 60.00' x 172.00'	x-16:00' .	JOB NUMBER
3419 MEETING ST	DESIGN:	DRAWN: RH	SBI36405
BRYANT, AR	DATE: 8/ 8/23	CHECK:	
JSTOMER: FERGUSON BUILDERS INC	SCALE: NONE	REV. NO:	DRAWING NUMBER
WG NAME: SIDEWALL FRAMING			SHEET 9 OF 14

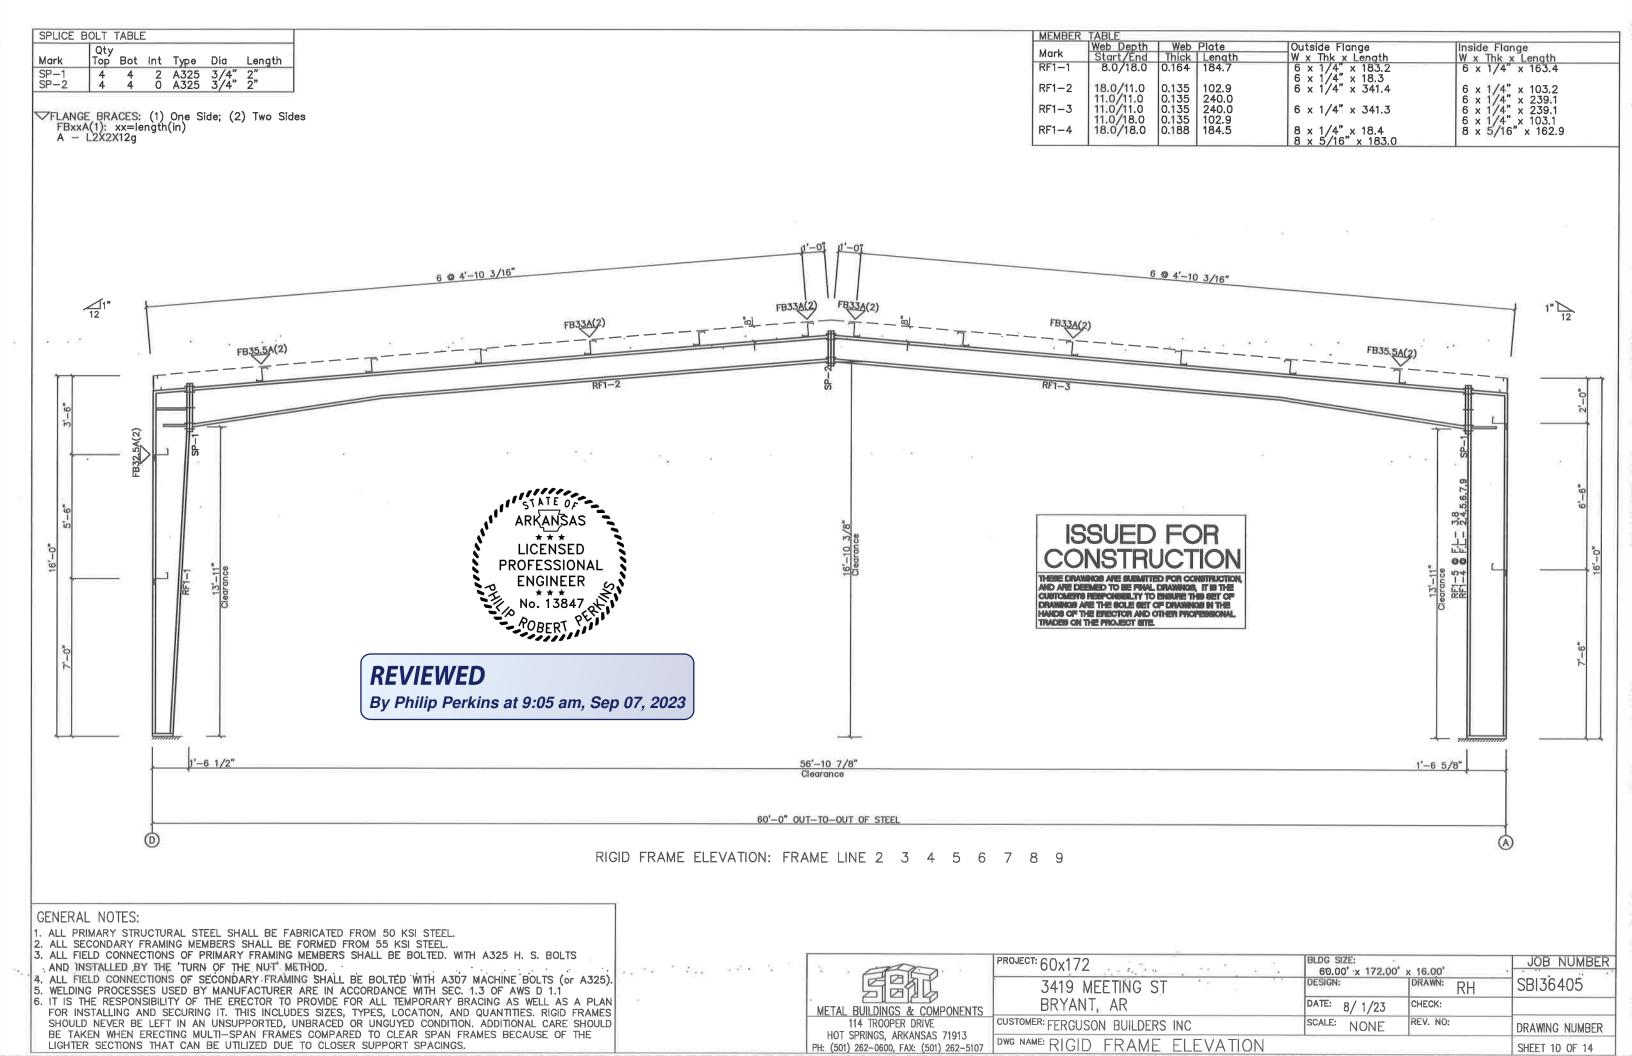

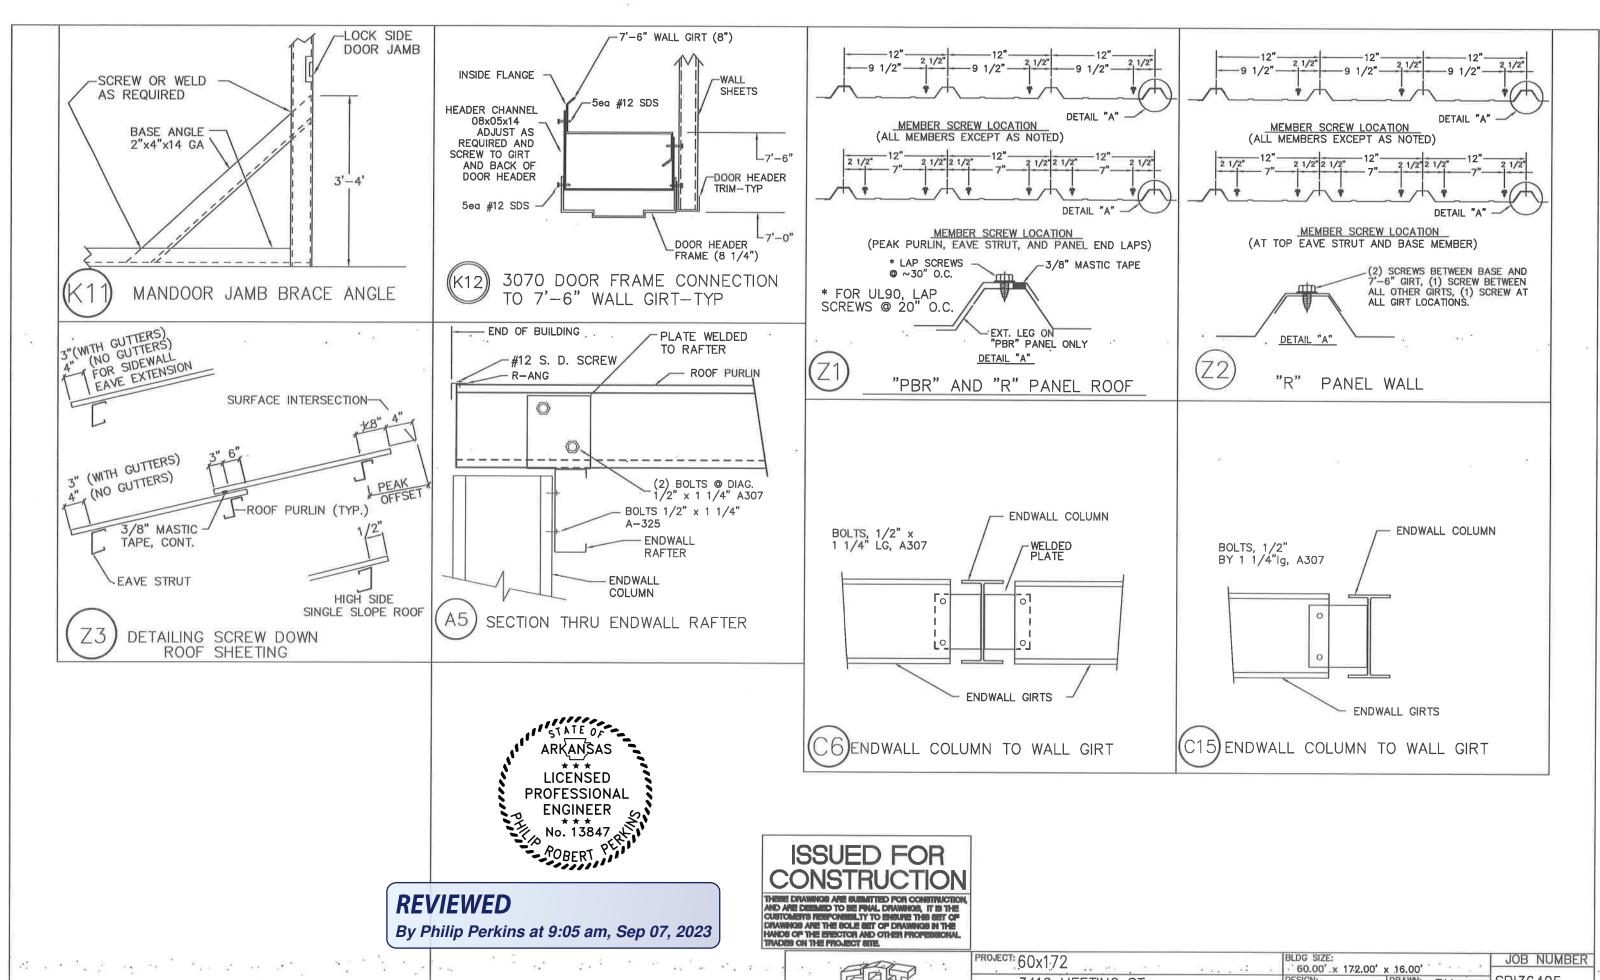

BLDG SIZE: 60.00' x 172.00' x 16.00' PROJECT: 60x172 JOB NUMBER SBI36405 3419 MEETING ST 四世份 BRYANT, AR DATE: 8/1/23 CHECK: METAL BUILDINGS & COMPONENTS SCALE: NONE CUSTOMER: FERGUSON BUILDERS INC REV. NO: 114 TROOPER DRIVE DRAWING NUMBER HOT SPRINGS, ARKANSAS 71913 DWG NAME: DETAIL DRAWINGS PH: (501) 262-0600, FAX: (501) 262-5107 SHEET 11 OF 14

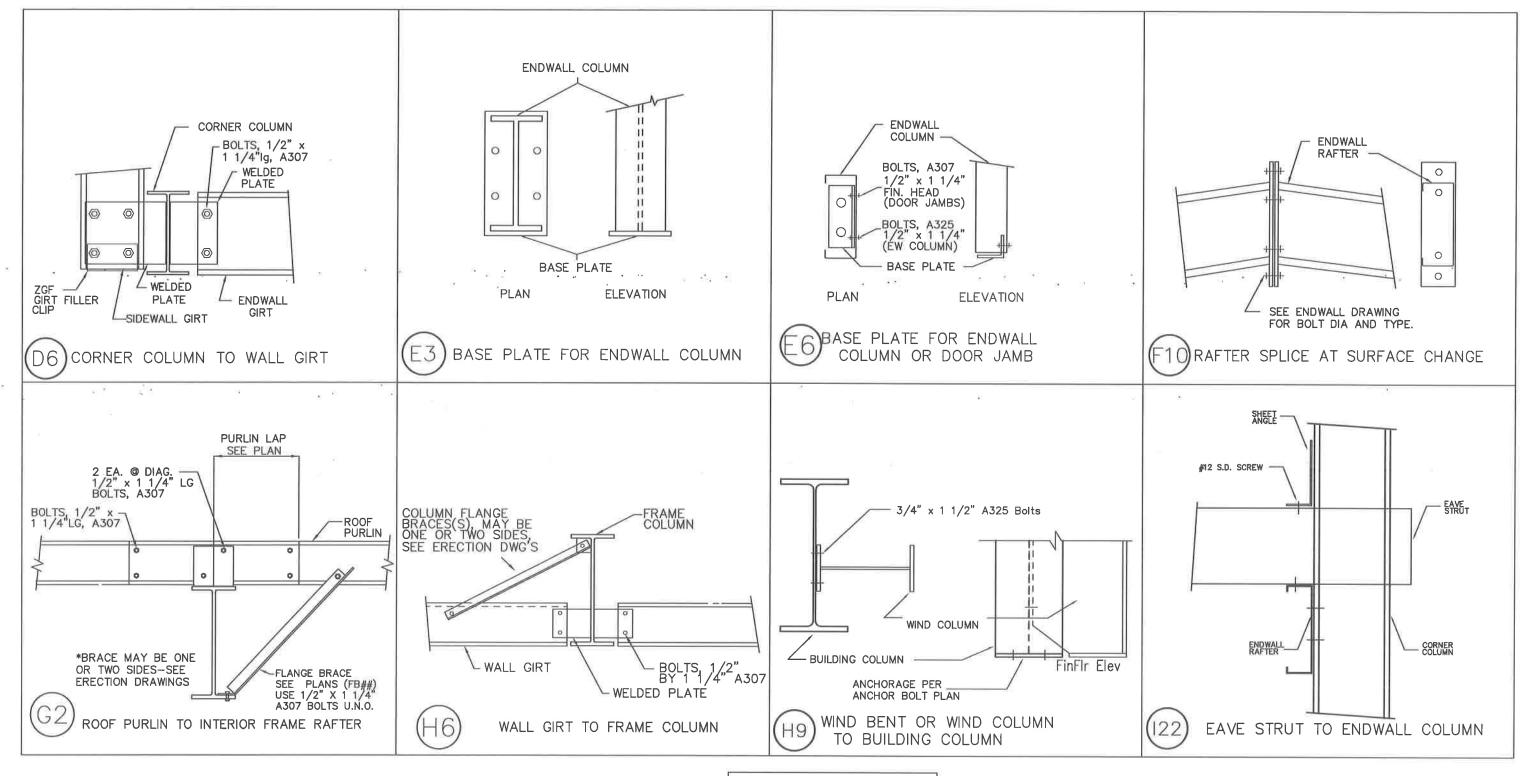

### **REVIEWED**

By Philip Perkins at 9:05 am, Sep 07, 2023




## ISSUED FOR CONSTRUCTION

THISSE DRAWINGS ARE SUBMITTED FOR CONSTRUCTION, AND ARE DEBMED TO BE FRAIL DRAWINGS, IT IS THE CUSTOMER'S RESPONSELTY TO ENGINE THIS SET OF DRAWINGS ARE THE SOLE SET OF DRAWINGS IN THE HANDS OF THE EFECTOR AND OTHER PROPESSIONAL TRADES ON THE PROJECT SITE.

METAL BUILDINGS & COMPONENTS	
114 TROOPER DRIVE	
HOT SPRINGS, ARKANSAS 71913	
PH: (501) 262-0600, FAX: (501) 262-5107	

ROJECT: 60x172	BLDG SIZE: 60.00' x-172.00'	JOB NUMBER	
3419 MEETING ST	DESIGN:	DRAWN: RH	SBI36405
BRYANT, AR	DATE: 8/ 1/23	CHECK:	
USTOMER: FERGUSON BUILDERS INC	SCALE: NONE	REV. NO:	DRAWING NUMBER
WG NAME: DETAIL DRAWINGS	-		SHEET 12 OF 14

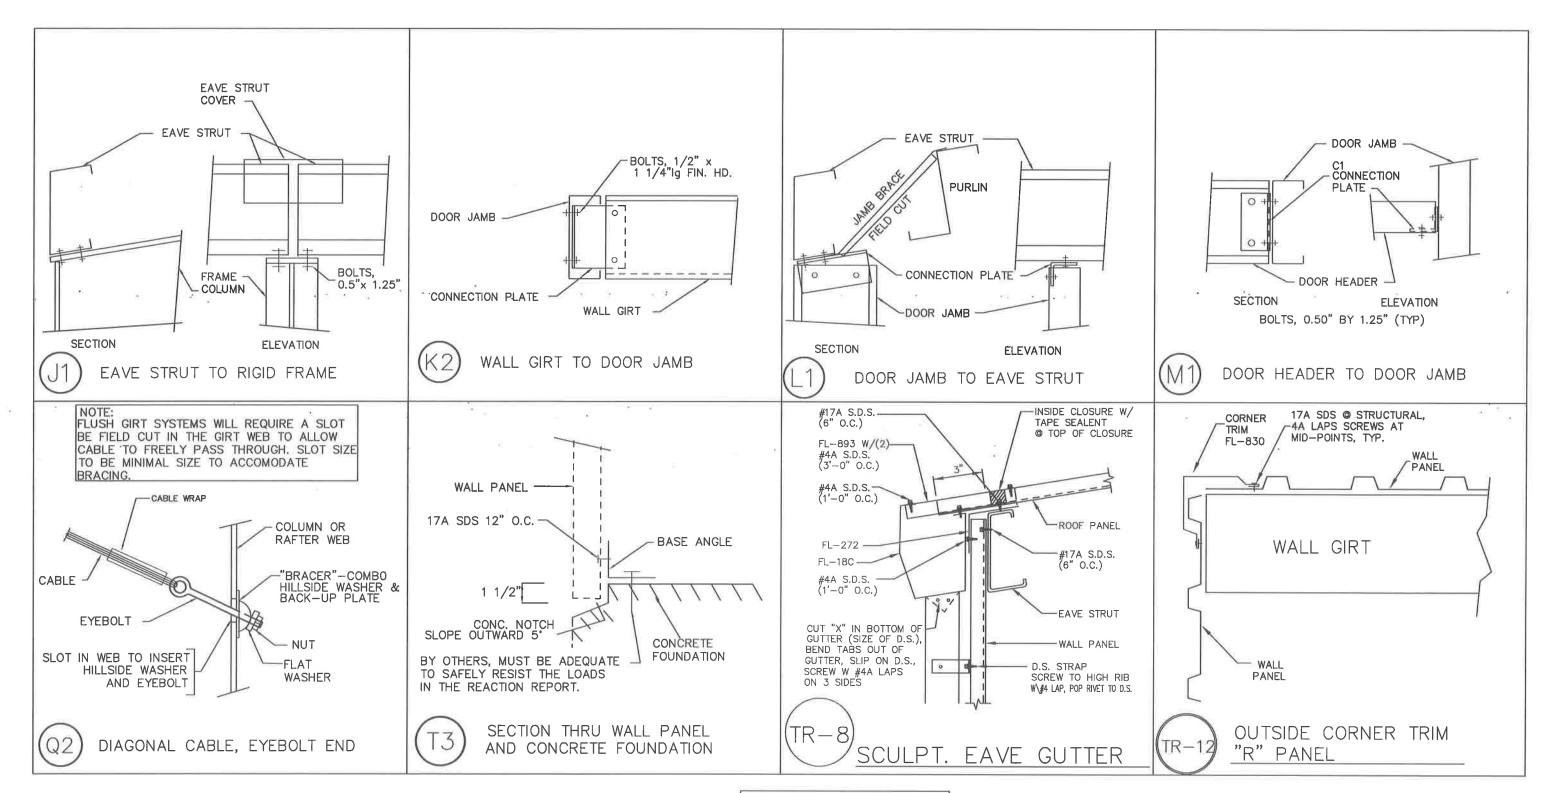

### REVIEWED

By Philip Perkins at 9:05 am, Sep 07, 2023




## ISSUED FOR CONSTRUCTION

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· -
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METAL BUILDINGS & COMPONENTS
114 TROOPER DRIVE
HOT SPRINGS, ARKANSAS 71913
DH: (501) 262-0600 EAV: (501) 262-5107

Į.	PROJECT: 60x172	BLDG SIZE: - 60.00' x 172.00'	x 16.000 - 7 3 3	JOB NUMBER
	3419 MEETING ST	DESIGN:	DRAWN: RH	SBI36405
	BRYANT, AR	DATE: 8/ 1/23	CHECK:	
	CUSTOMER: FERGUSON BUILDERS INC	SCALE: NONE	REV. NO:	DRAWING NUMBER
8	DWG NAME: DETAIL DRAWINGS		71	SHEET 13 OF 14

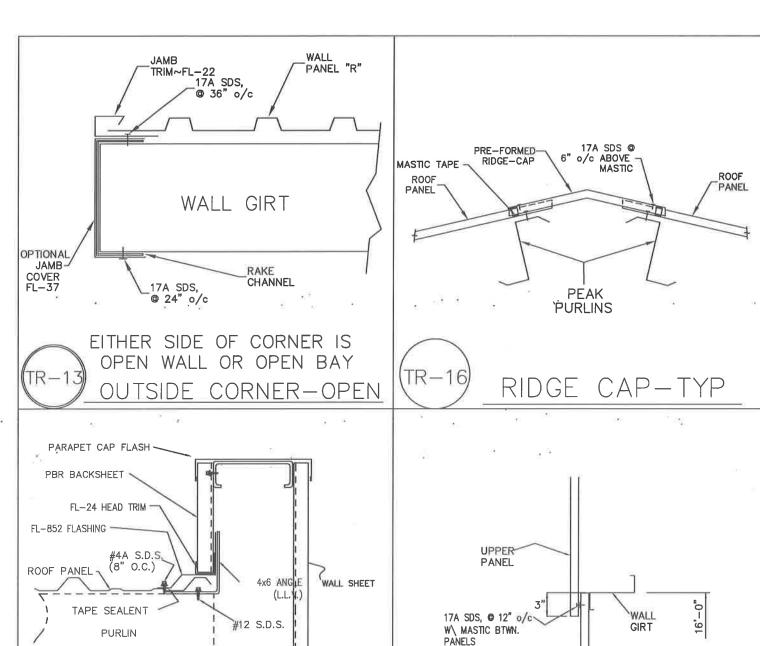



TR\_87

RAKE PARAPET TRANSISTION

LOWER-

ACCENT WALL PANEL LAP

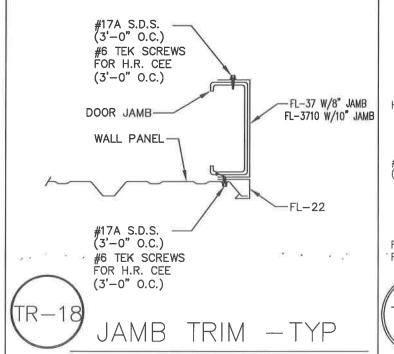

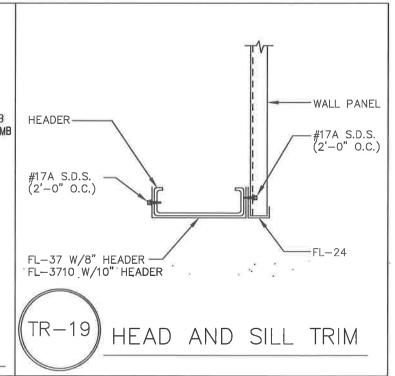



### **REVIEWED**

By Philip Perkins at 9:05 am, Sep 07, 2023

ISSUED FOR CONSTRUCTION

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METAL BUILDINGS & COMPONENTS	
114 TROOPER DRIVE	1
HOT SPRINGS, ARKANSAS 71913	ł
PH: (501) 262-0600, FAX: (501) 262-5107	l

/	PROJECT: 60x172	BLDG SIZE: 60.00' x 172.00'	x, 16.00'	JOB NUMBER
	3419 MEETING ST	DESIGN:	DRAWN: RH	SBI36405
	BRYANT, AR	DATE: 8/ 1/23	CHECK:	
	CUSTOMER: FERGUSON BUILDERS INC	SCALE: NONE	REV. NO:	DRAWING NUMBER
	DWG NAME: DETAIL DRAWINGS			SHEET 14 OF 14

## **GNE**

### **Designing our client's success**

P.O. Box 116

3825 Mt Carmel Rd

Benton, AR 72018 Ph (501) 408-4650 Bryant, AR 72022


garnatengineering@gmail.com

FOR EXCLUSIVE USE & BENEFIT OF:

Name: BART FERGUSON

### **LEGEND**

- ▲ Computed point
- Found monument
- Set #4 RB/Plas. Cap
- (M)-Measured
- (R)-Record
- (P)-Platted

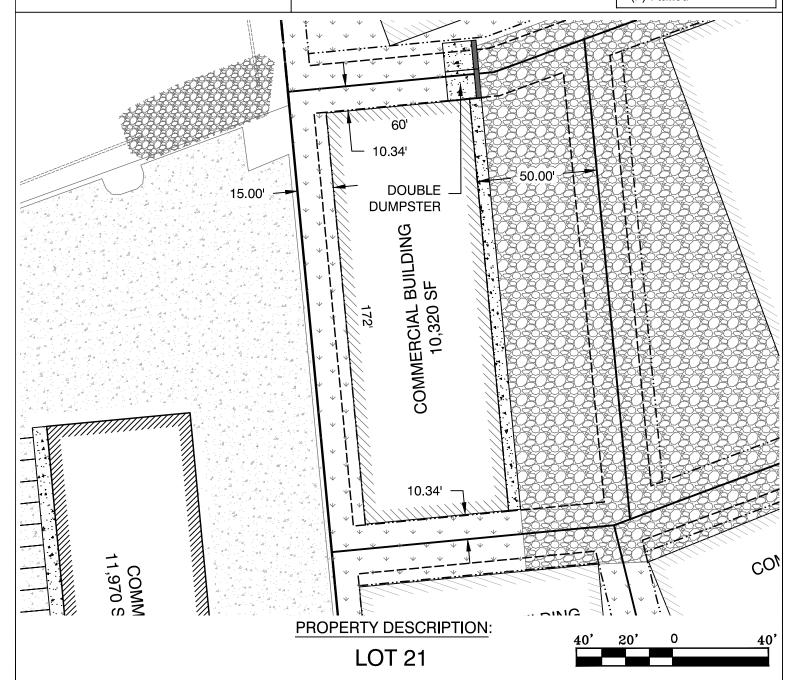

### **JOB NUMBER:**


### 18087 MARKET PLACE II PHASE 3


10/03/23


### **PLOT PLAN**


This Plot Plan depicts the lot as it appears on the subdivision final plat. This drawing does not represent an actual survey.


According the the Federal Emergency Management Agency (FEMA) Flood Insurance Rate Map (FIRM) for Saline County unincorporated areas, panel # 05125C0240E dated JUNE 05, 2020, no portion, dated of the property described hereon does lie within the 100 year flood hazard boundary.

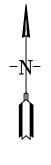


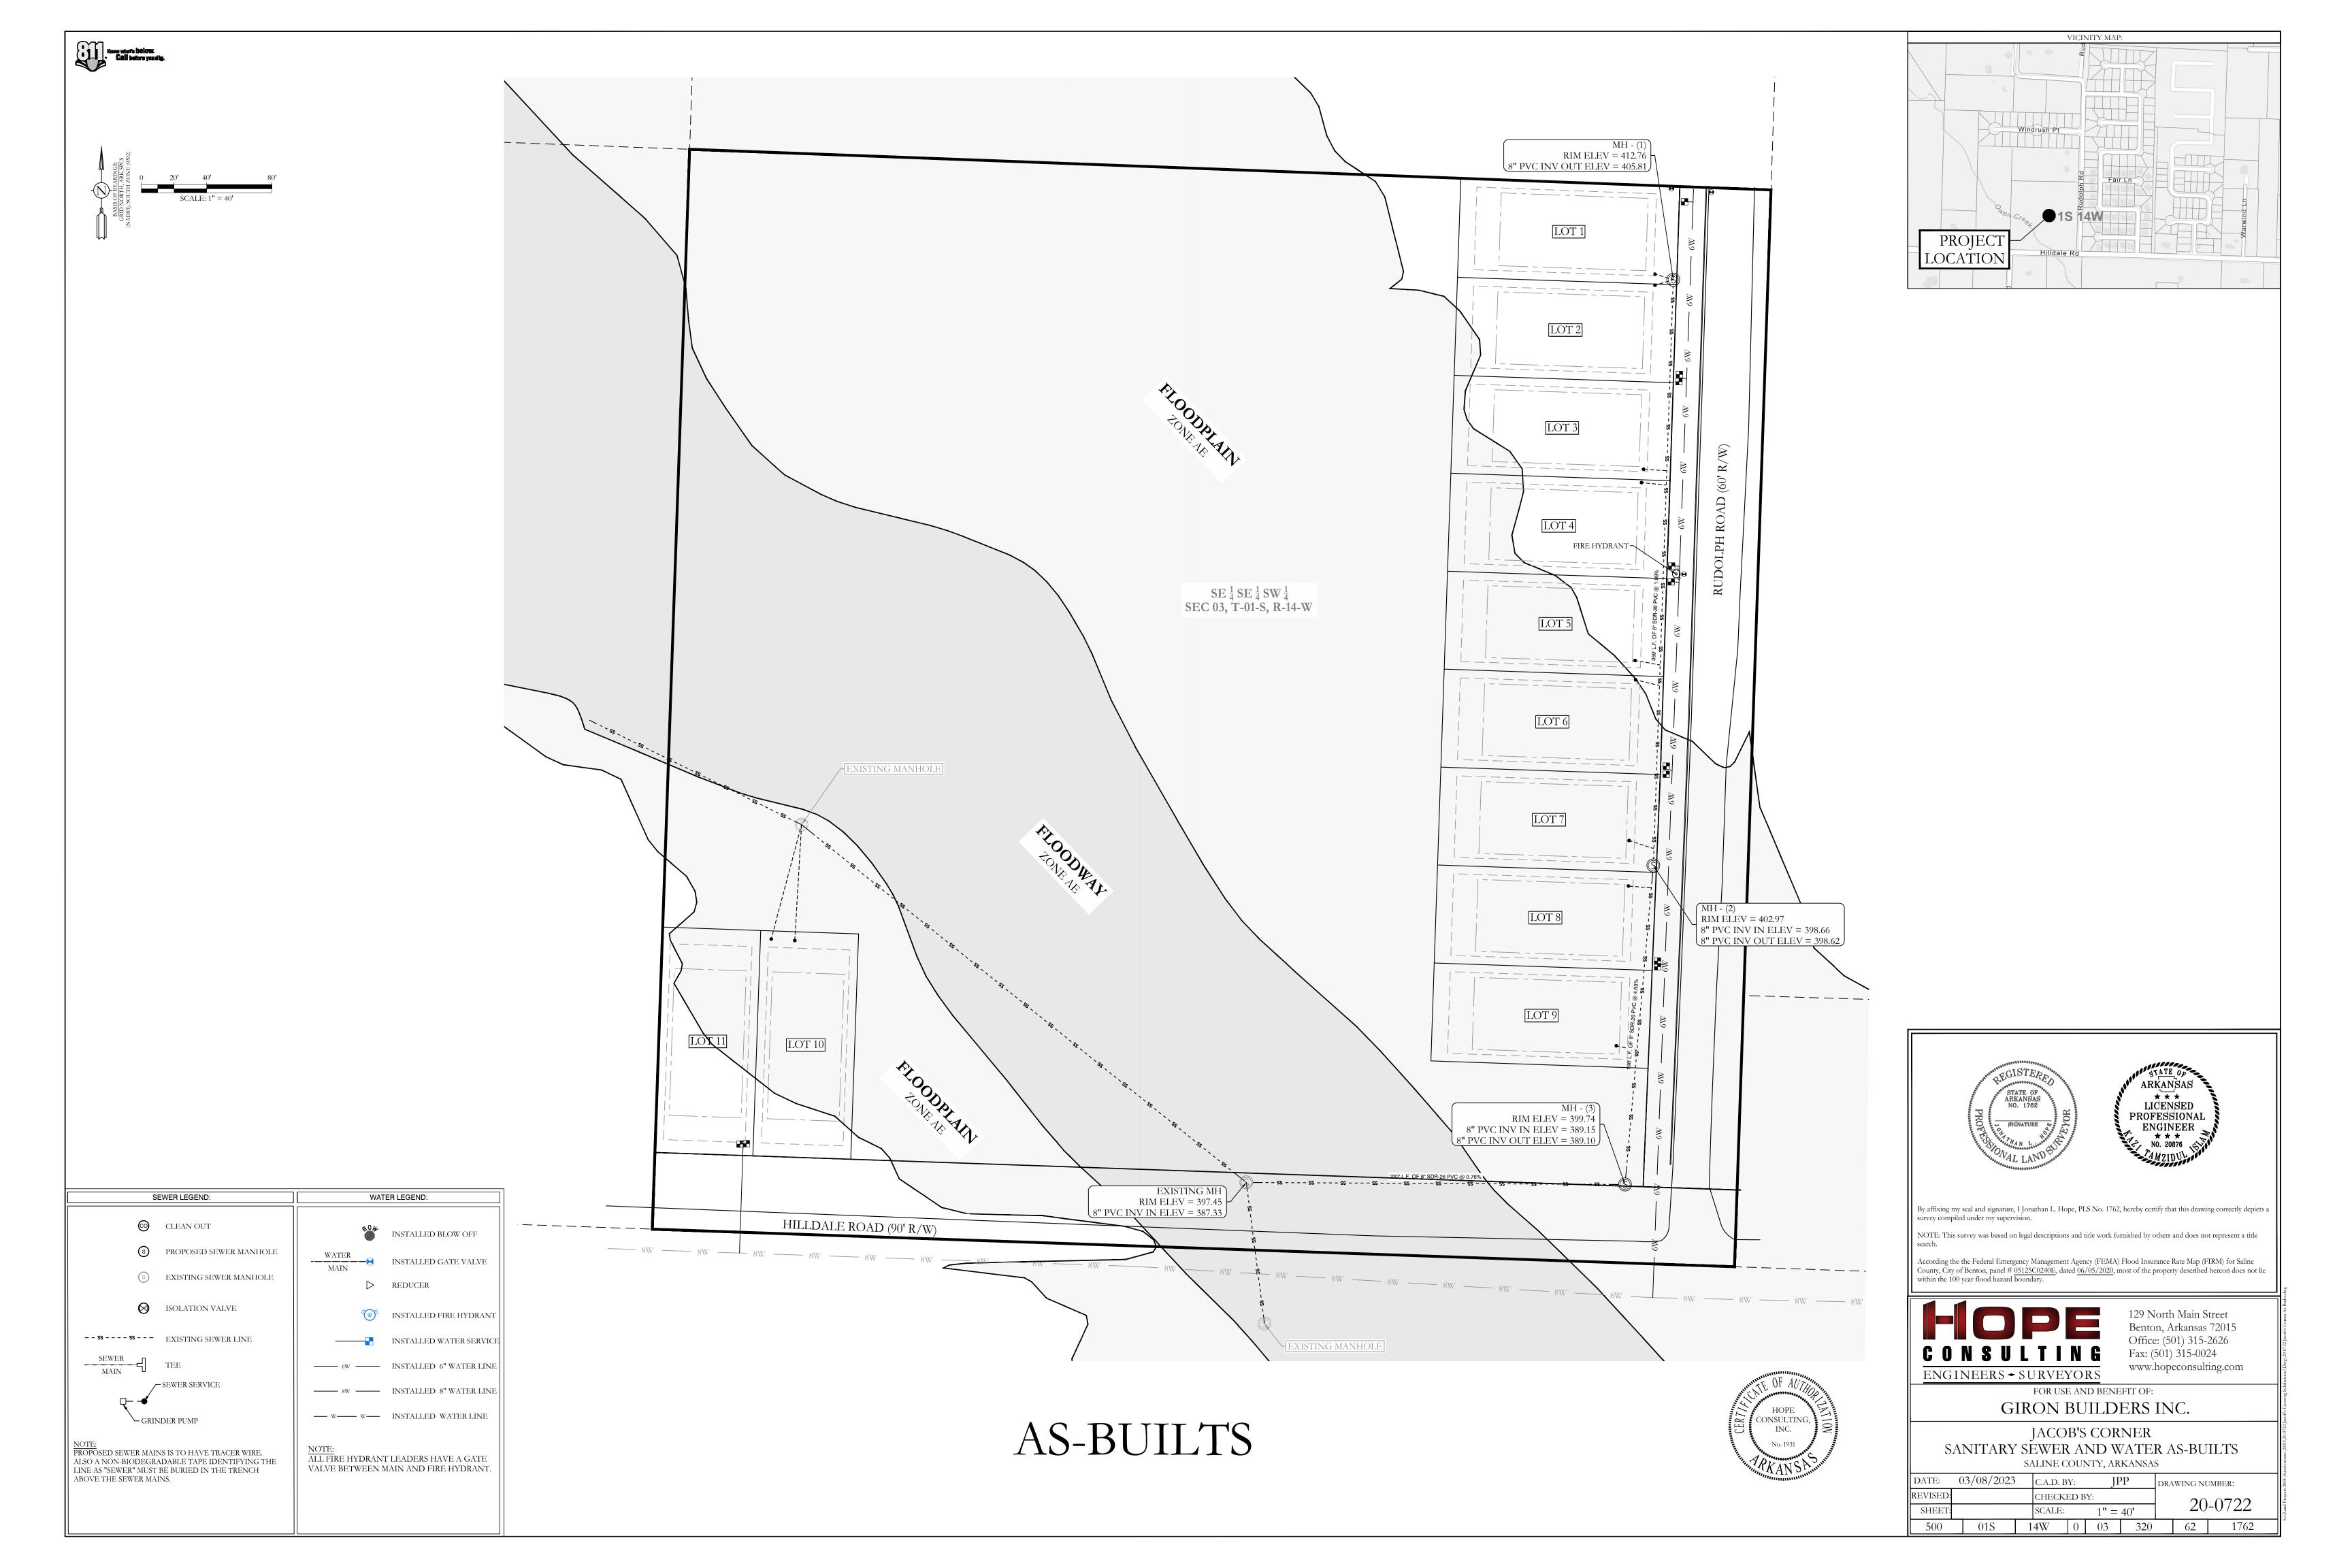


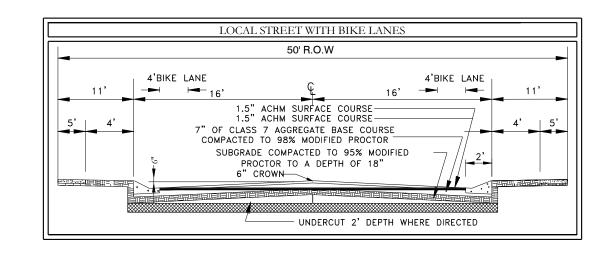


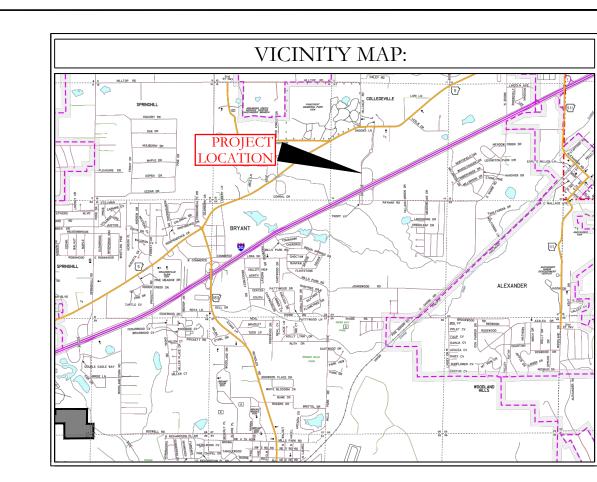


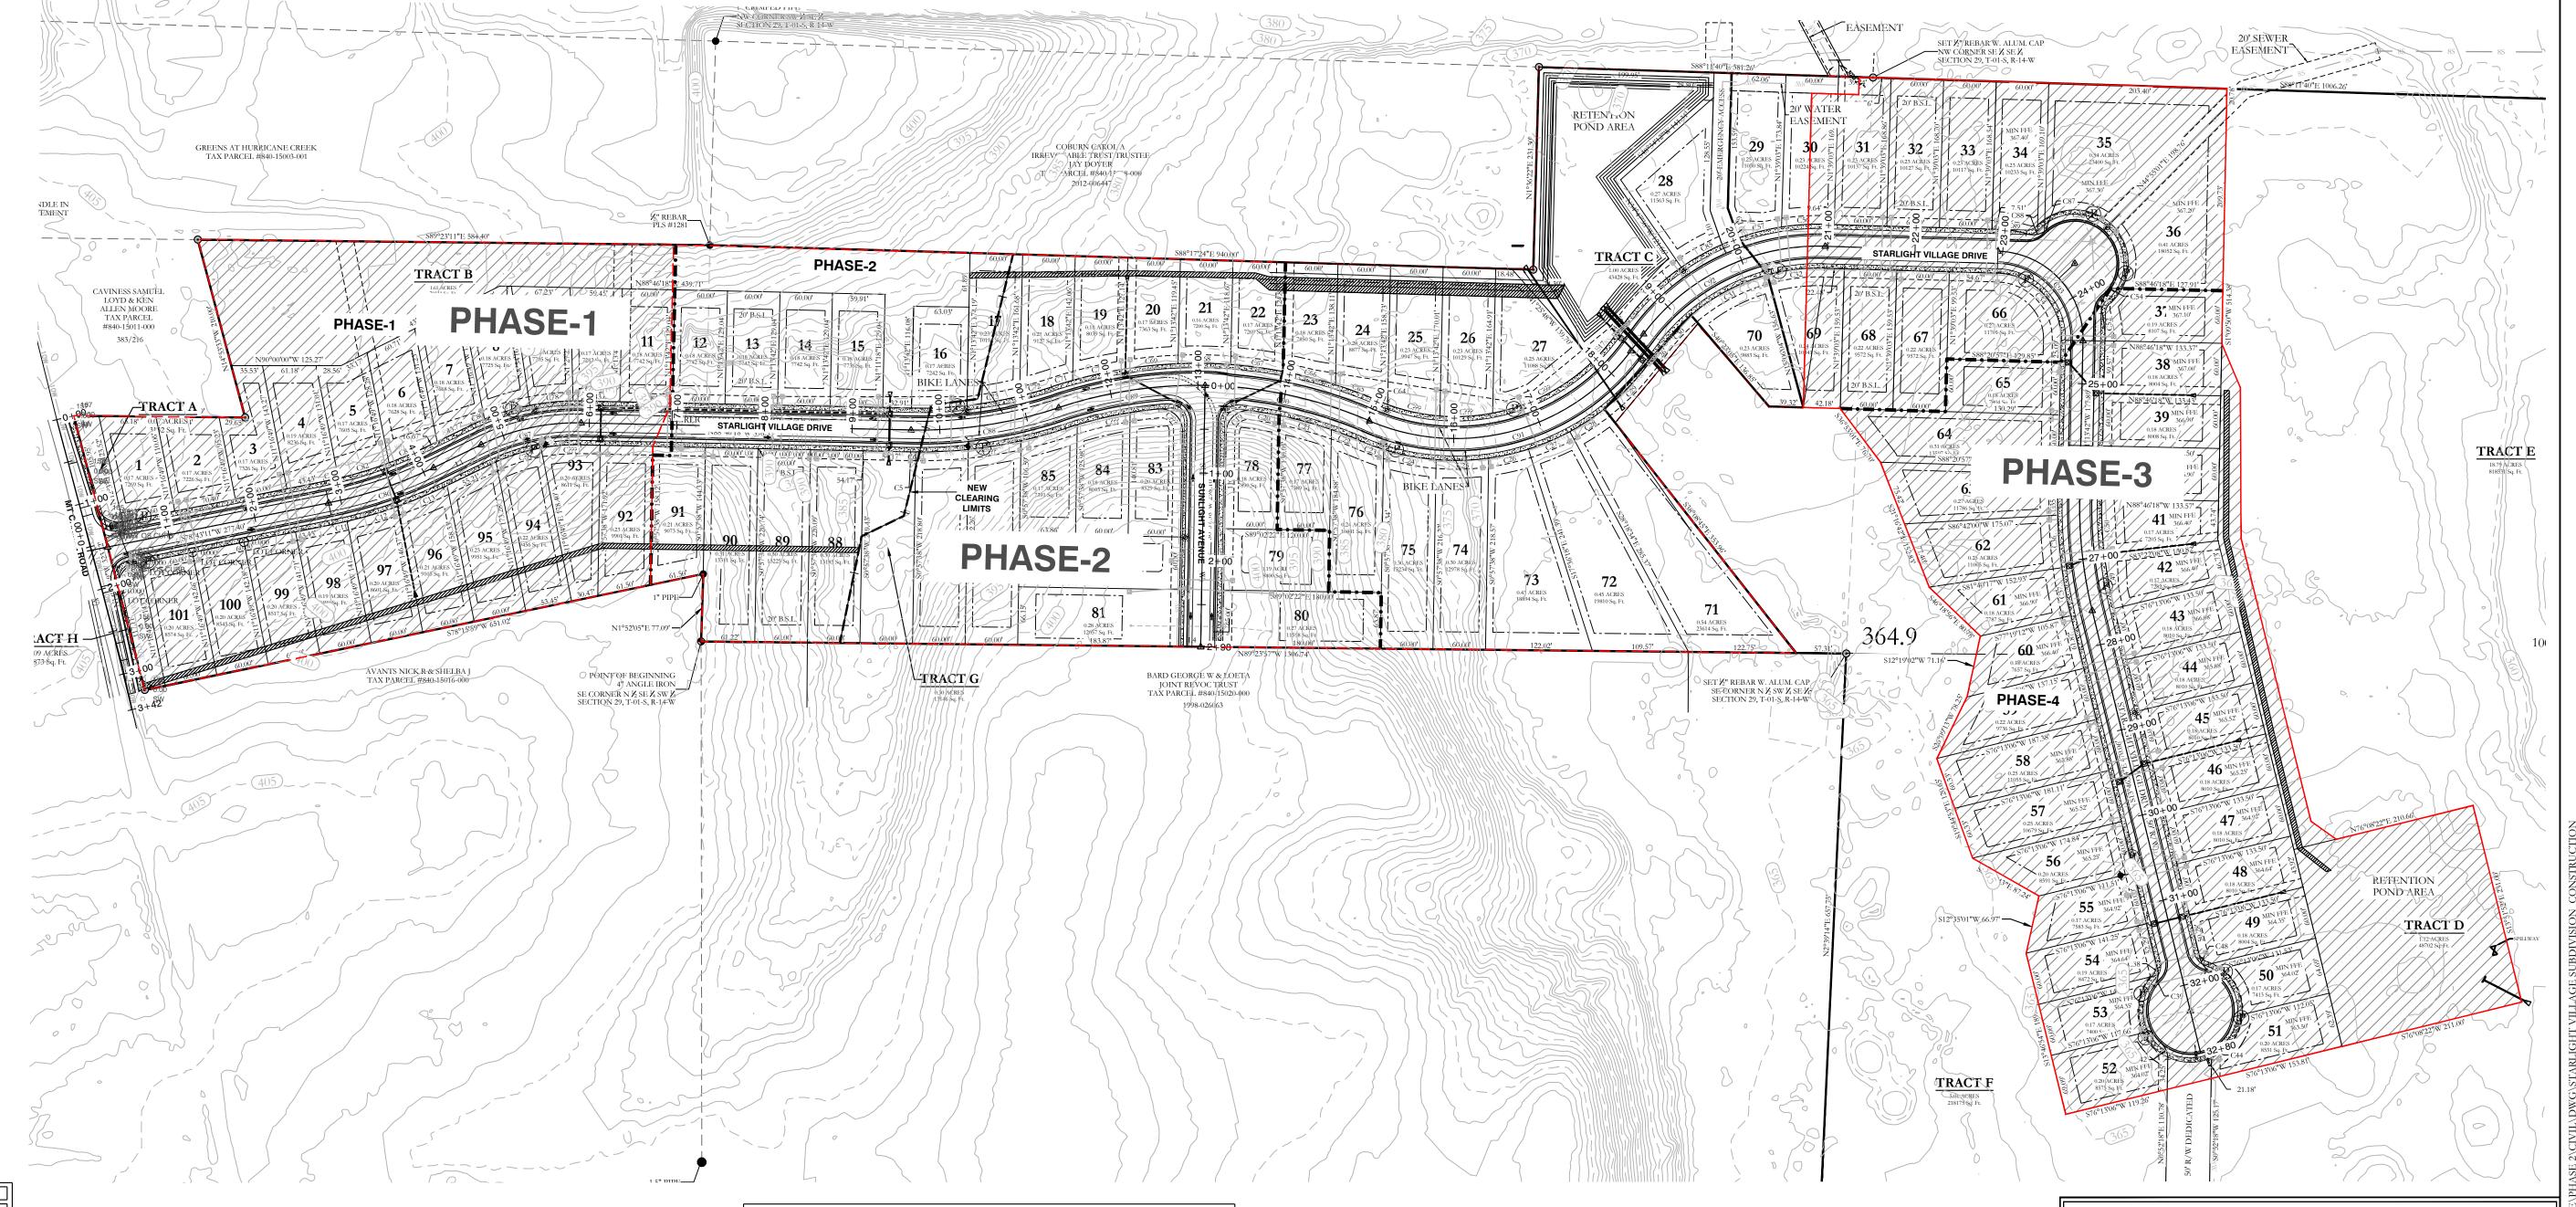

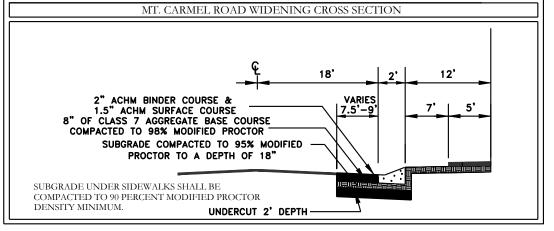

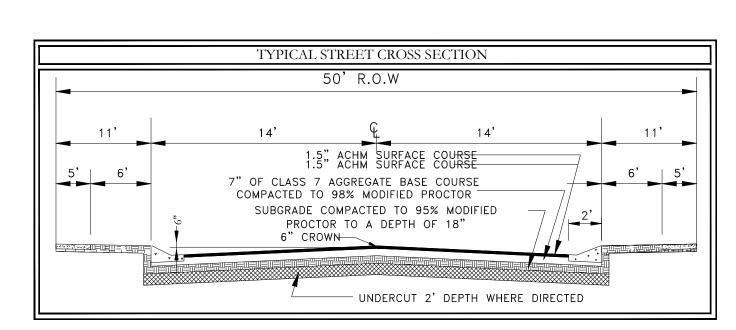

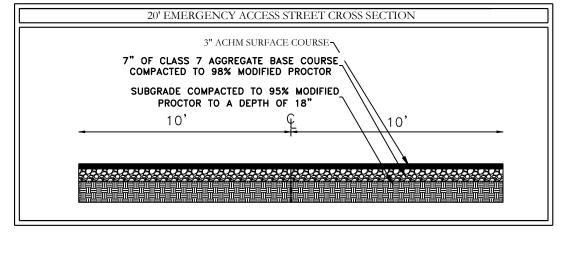

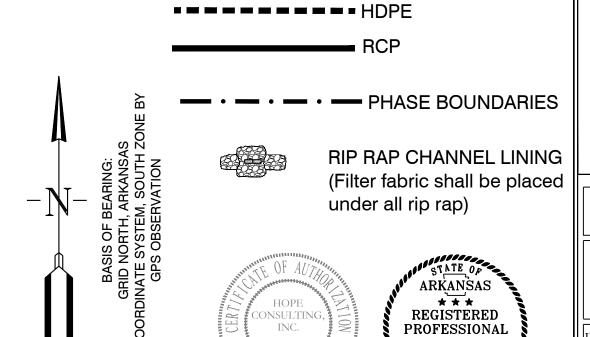

ENGINEER No. 14048




117 S. Market Street,
Benton, Arkansas 72015
PH. (501)315-2626
FAX (501) 315-0024
www.hopeconsulting.com

FOR USE AND BENEFIT OF: VIGGINS FAMILY REAL ESTATE HOLDIN


WIGGINS FAMILY REAL ESTATE HOLDINGS, LLC


STARLIGHT VILLAGE SUBDIVISION
STREET LAYOUT
A SUBDIVISION IN CITY OF BRYANT, SALINE COUNTY, ARKANSAS

ı	11	30001113101	VIIV CITT OI	DKI	1111, 52	THILL C	<i>J</i> 01 <b>v</b>	11,71111	11110110
	DATE:	10/5/2023	C.A.D	). BY:			D	RAWING	NUMBER:
	REVISED:	, ,	CHEC	CKED	BY:			10	0020
	SHEET:	C-1.0	SCAL	E:				19-	-0238
t	<u> </u>								

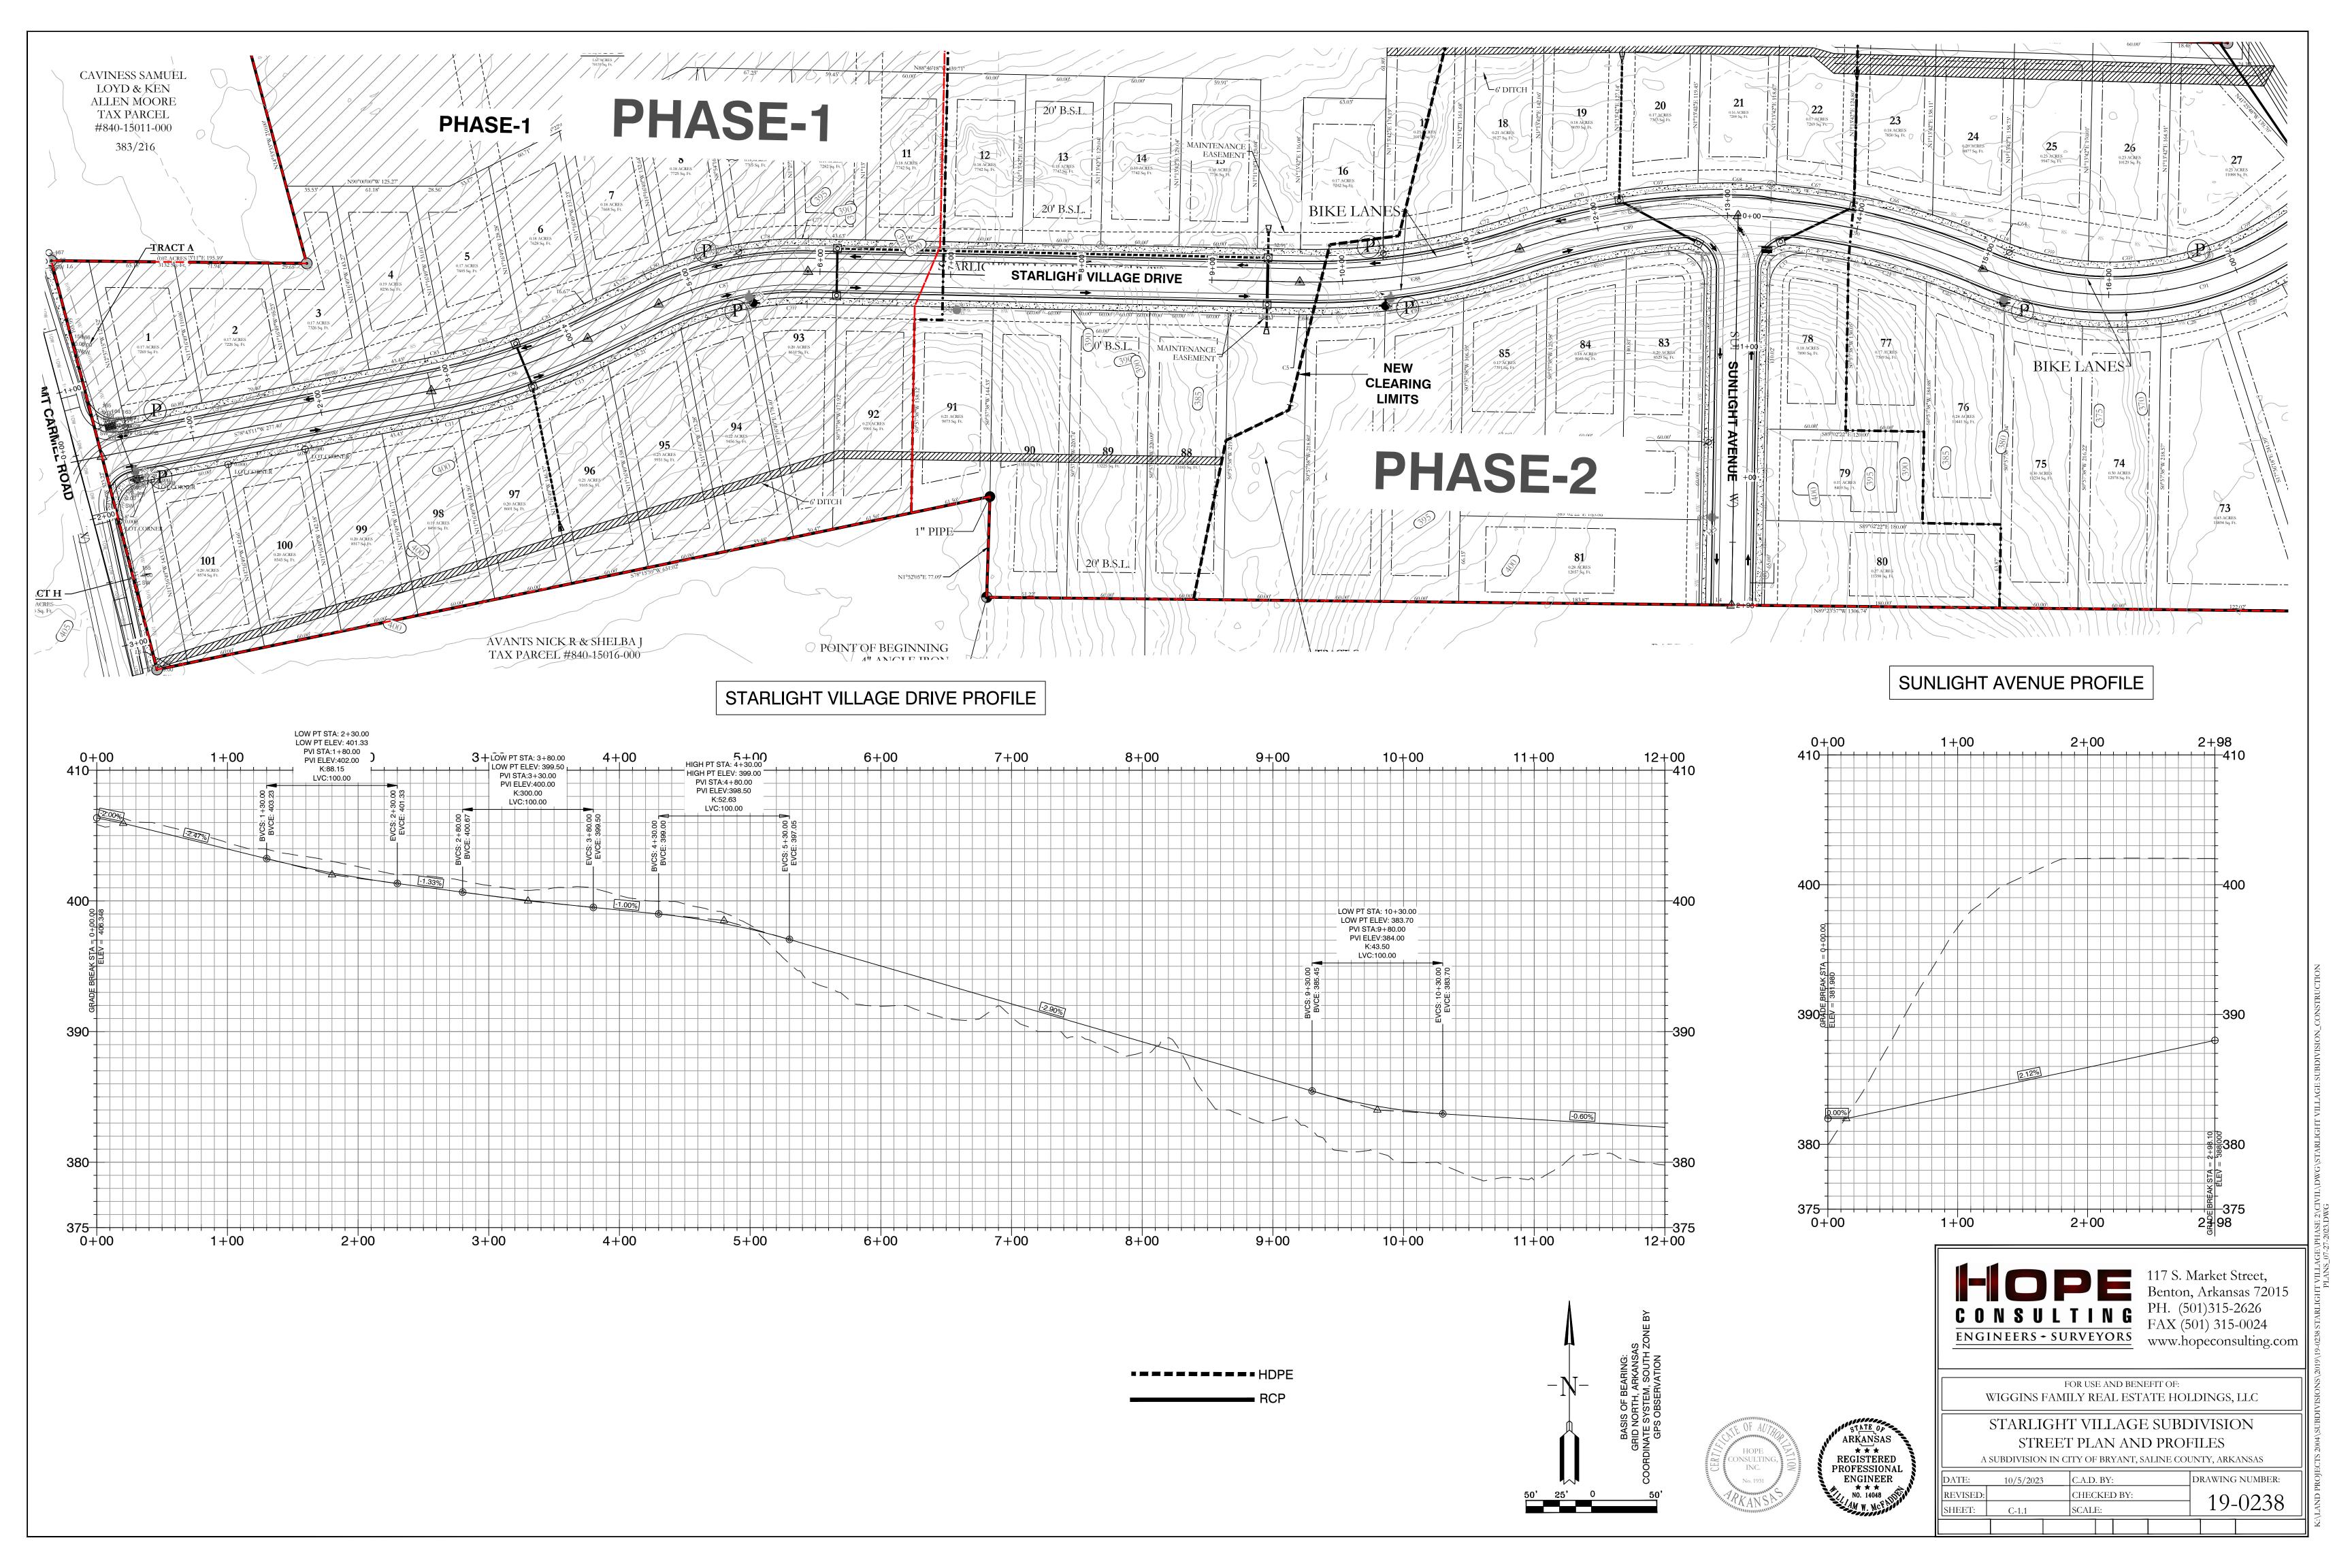

## STARLIGHT VILLAGE DRIVE PROFILE

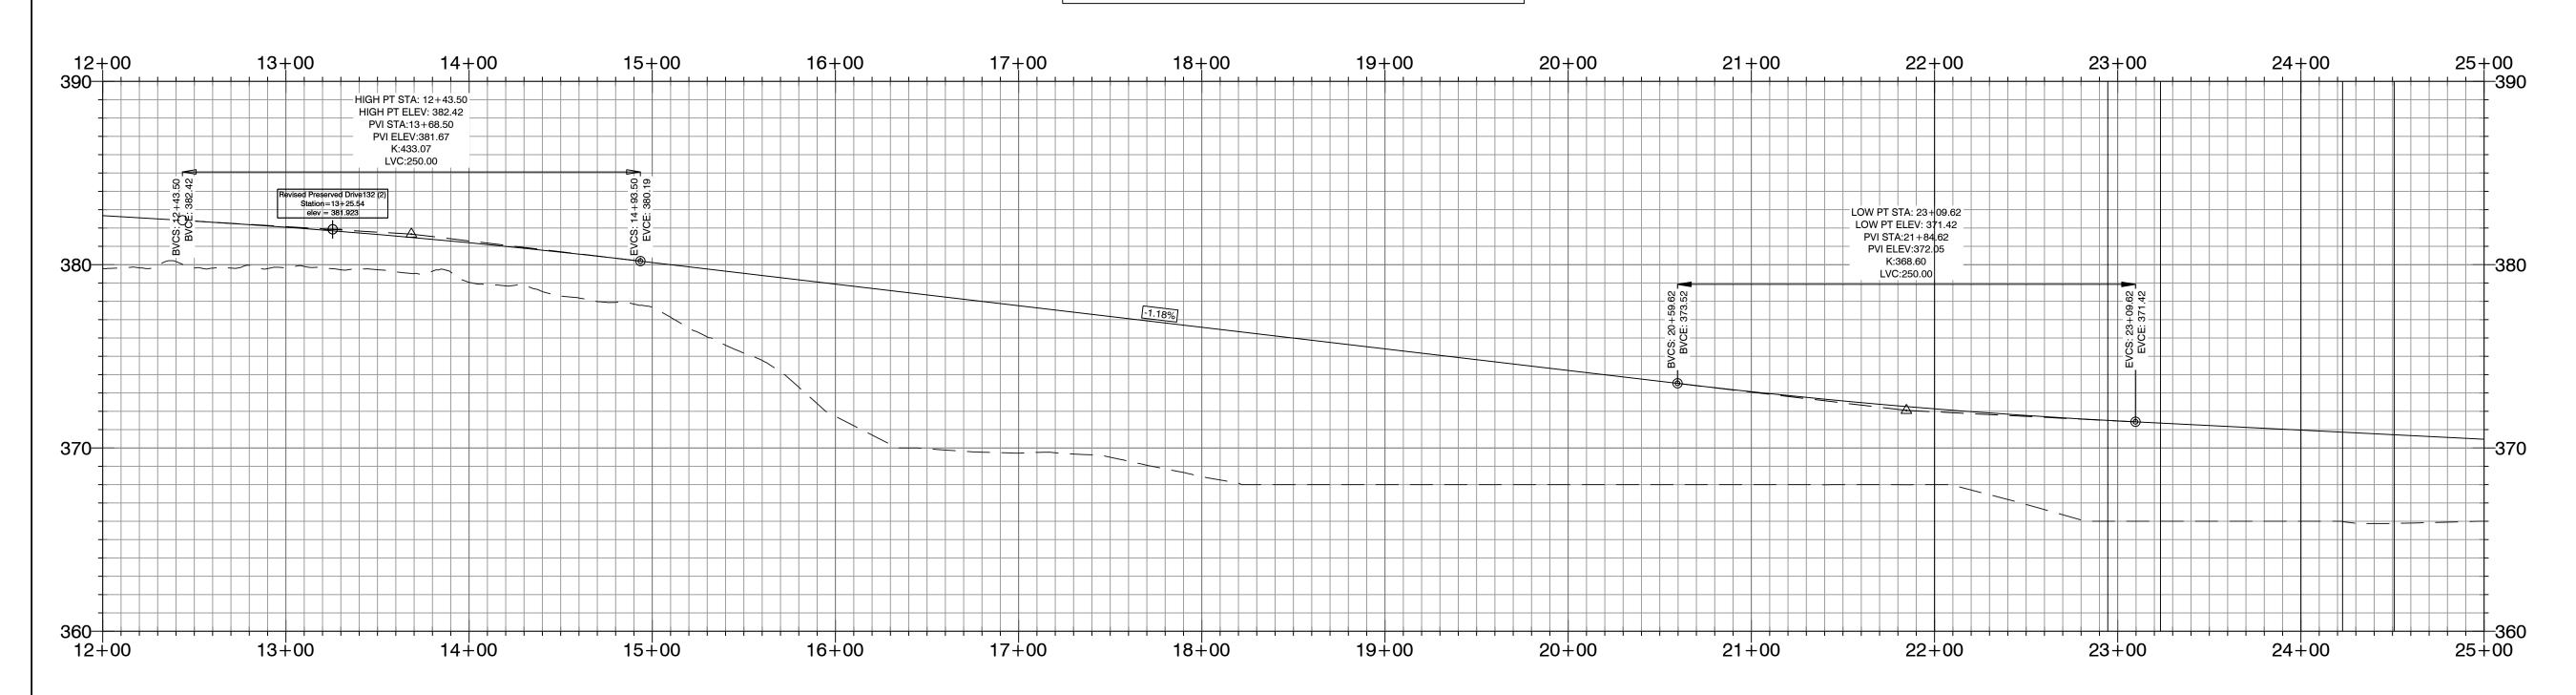

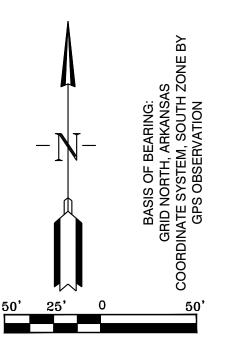







ENGINEERS - SURVEYORS www.hopeconsulting.com


FOR USE AND BENEFIT OF:

WIGGINS FAMILY REAL ESTATE HOLDINGS, LLC


STARLIGHT VILLAGE SUBDIVISION STREET PLAN AND PROFILE


A :	A SUBDIVISION IN CITY OF BRYANT, SALINE COUNTY, ARKANSAS									
DATE:	10/5/2023		C.A.D.	. BY:			DI	RAWING	NUMBER:	
REVISED:			CHEC	KEI	O BY:			10	0220	
SHEET:	C-1.2		SCALI	E:				19-	<u>-0238</u>	

## STARLIGHT VILLAGE DRIVE PROFILE

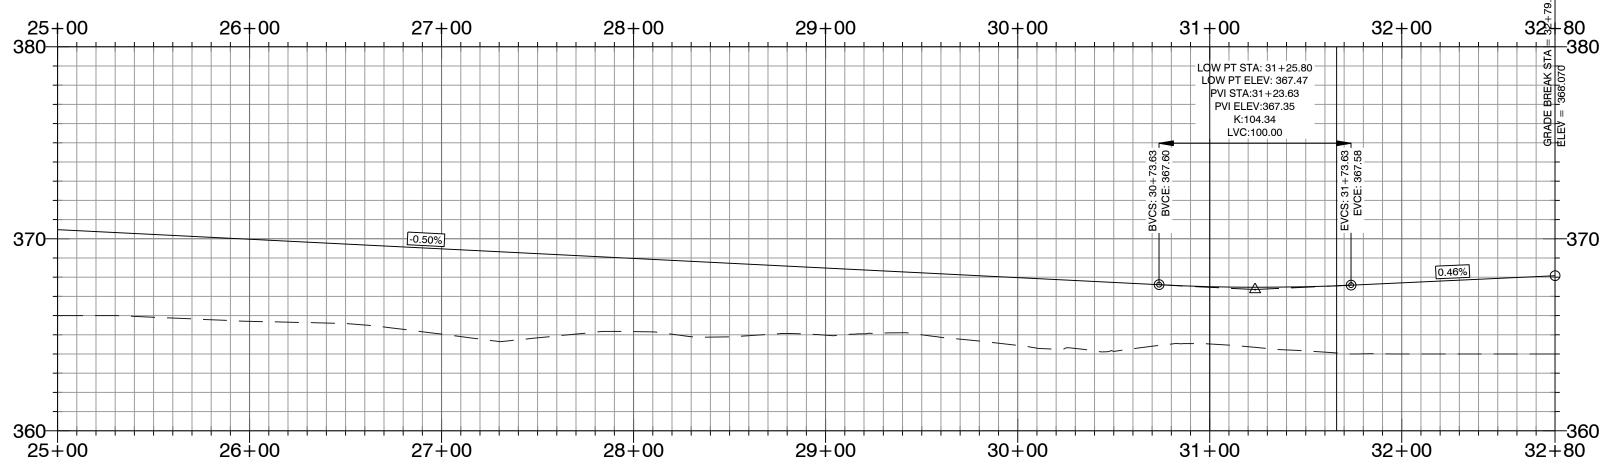

-----HDPE

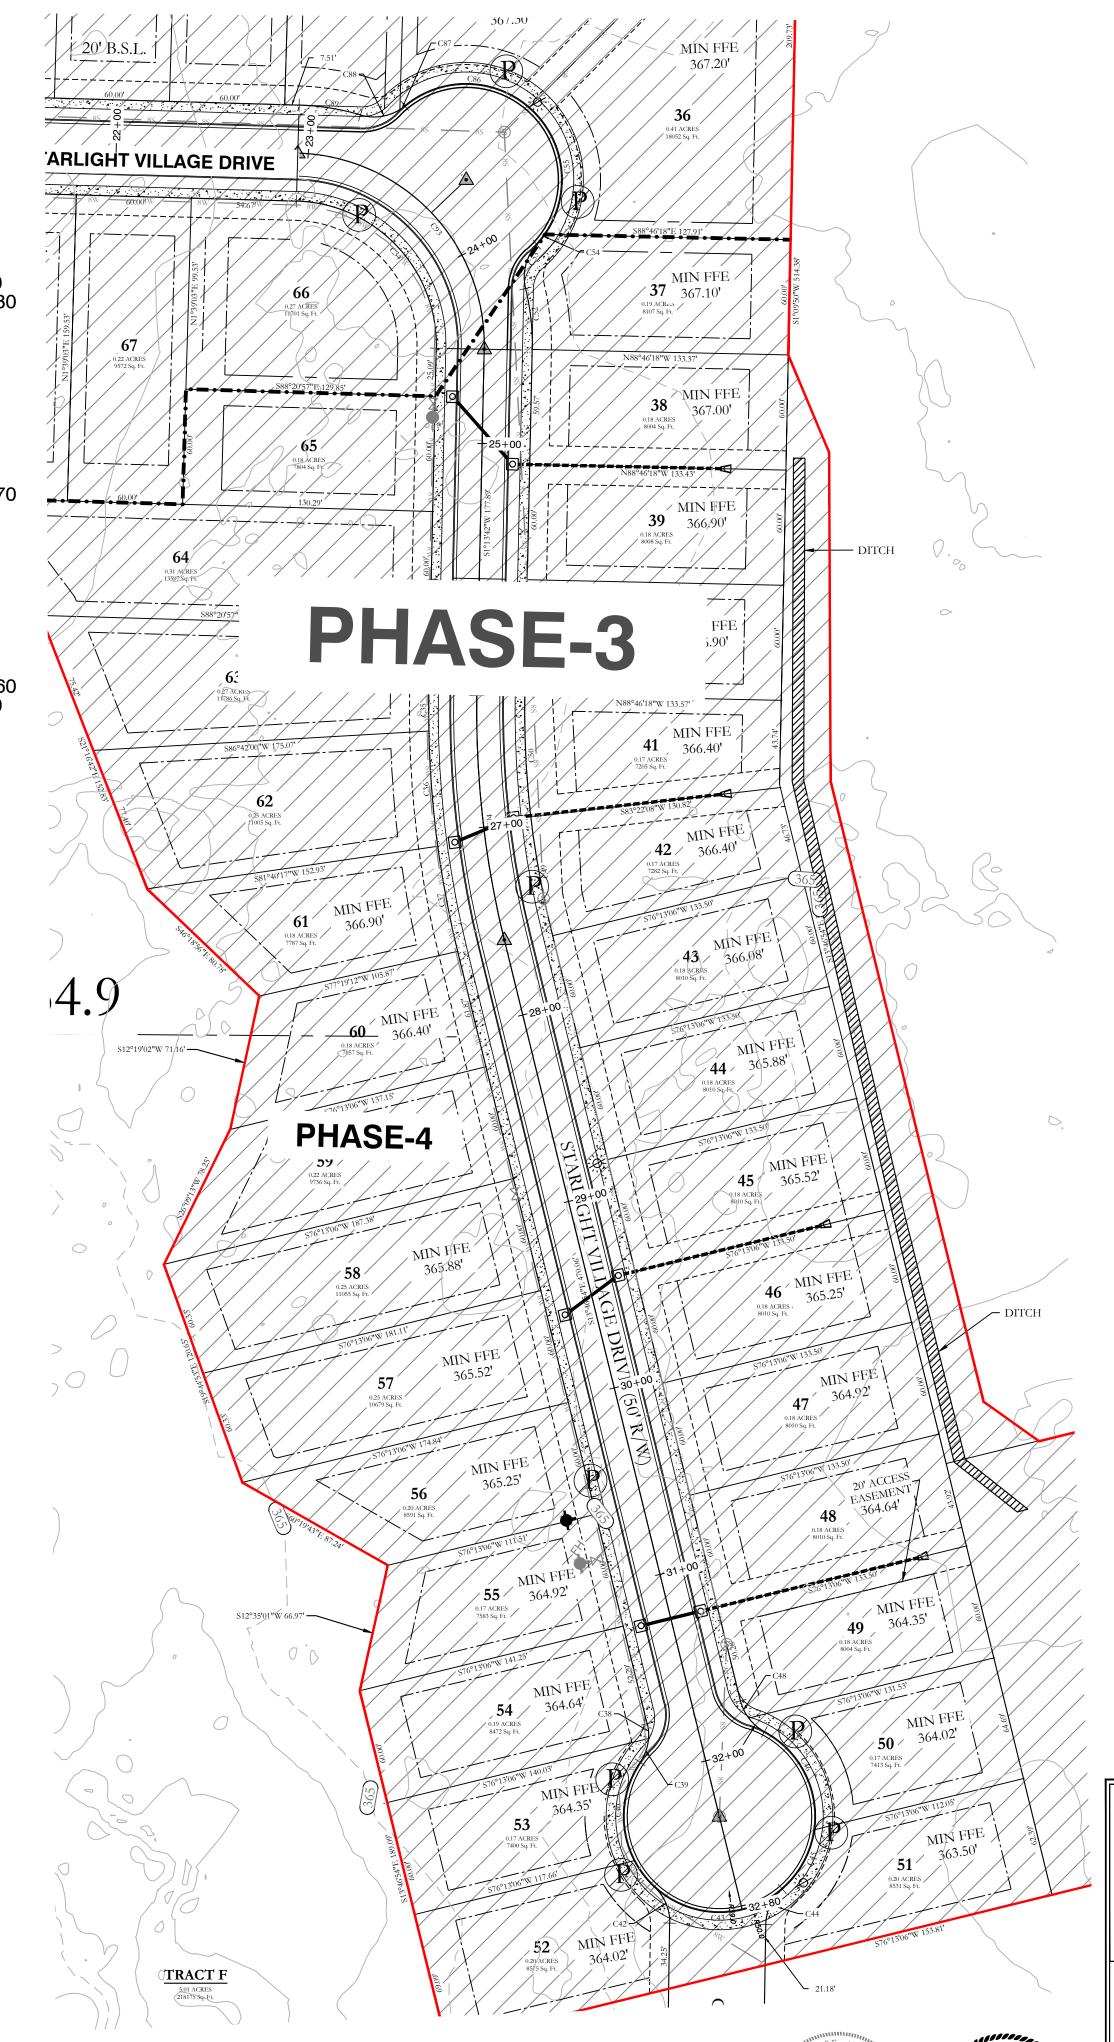

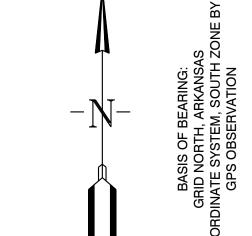






ENGINEERS - SURVEYORS www.hopeconsulting.com

FOR USE AND BENEFIT OF:

WIGGINS FAMILY REAL ESTATE HOLDINGS, LLC STARLIGHT VILLAGE SUBDIVISION

STREET PLAN AND PROFILE

DATE:	10/5/2023	C.A.D. BY:	DRAWING NUMBER:
REVISED:		CHECKED BY:	10 0238
SHEET:	C-1.3	SCALE:	19-0238

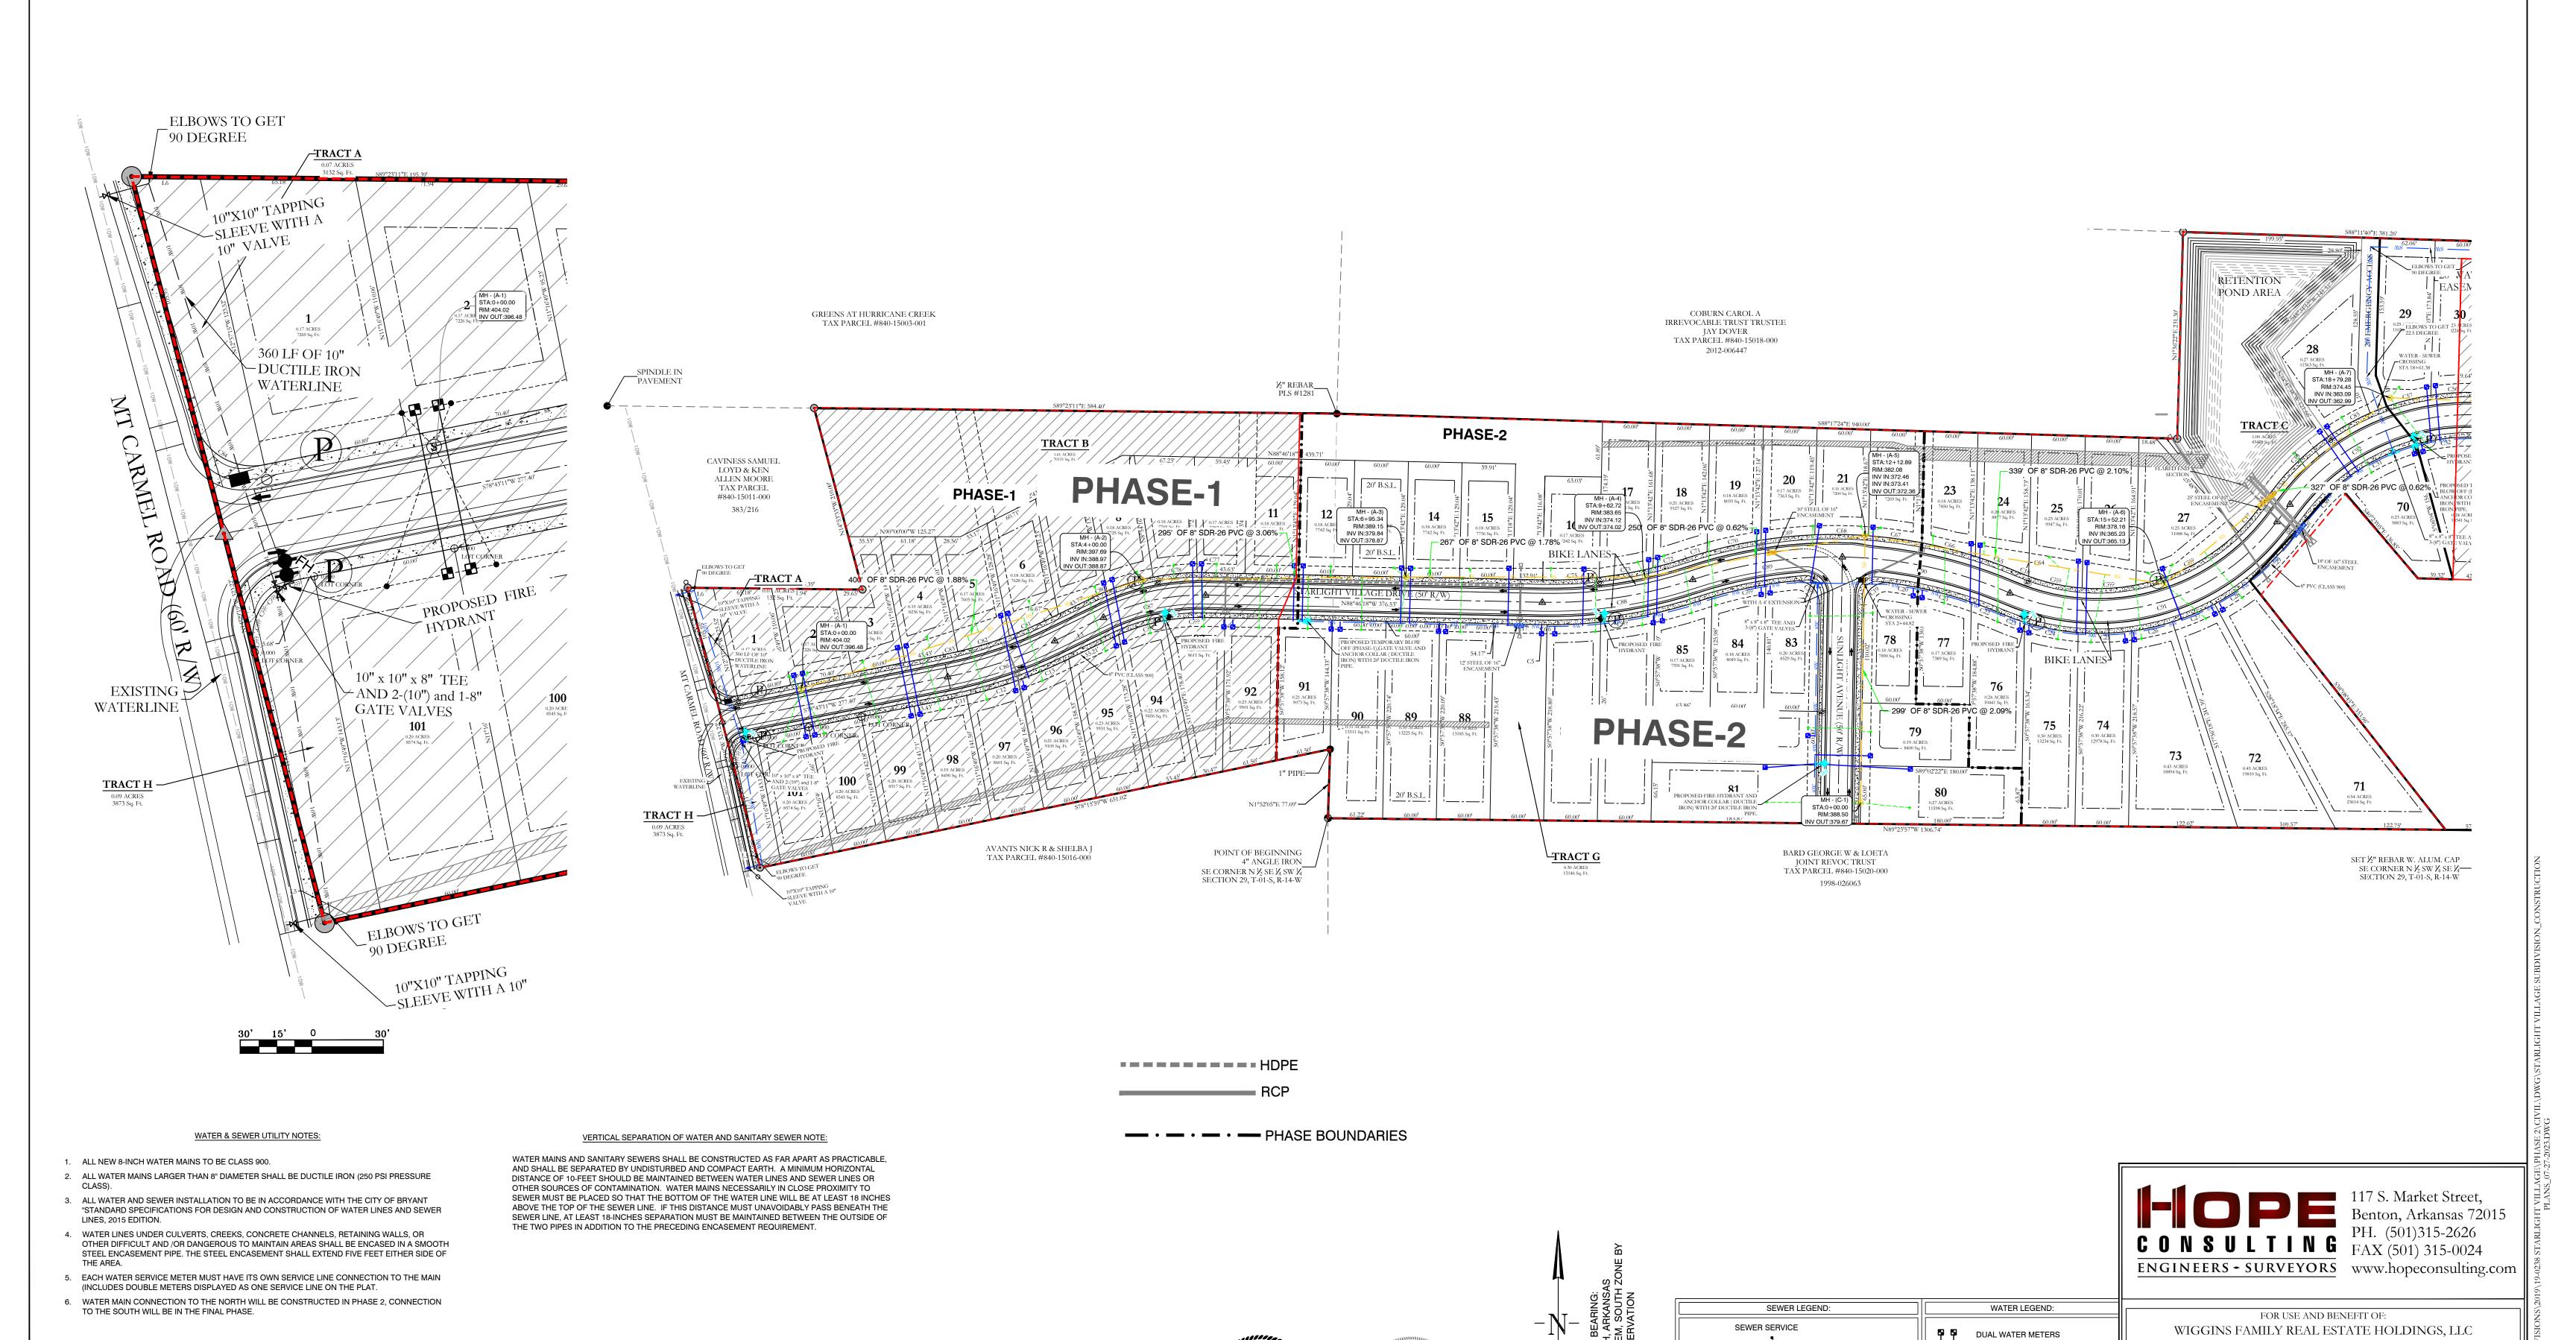

ARKANSAS

\* \* \*

REGISTERED

PROFESSIONAL

ENGINEER \*\*\*

SINGLE WATER METER

▼ GATE VALVE

√
45º FITTING

♦ 90º FITTING

FIRE HYDRANT

CROSS FITTING

—S SEWER MANHOLE

USE SDR-26 PVC SEWER PIPE EXCEPT WHERE DUCTILE

IRON PIPE REQUIRED FOR COVER. USE DUCTILE IRON

PIPE WHERE 3' MINIMUM COVER CANNOT BE

CONTRACTOR IS RESPONSIBLE FOR LOCATING ALL

BURIED UTILITIES PRIOR TO CONSTRUCTION.

SEWER MAIN ---

STARLIGHT VILLAGE SUBDIVISION

UTILITY PLAN

A SUBDIVISION IN CITY OF BRYANT, SALINE COUNTY, ARKANSAS

1S | 15W | 0 | 34 | 230 | 62 | 1807

DRAWING NUMBER:

C.A.D. BY:

CHECKED BY:

REVISED:

SHEET:


SEWER CONSTRUCTION NOTES:

SPECIFICATIONS FOR DESIGN AND CONSTRUCTION OF WATER LINES AND SEWER LINES, 2015

1. ALL SEWER INSTALLATION TO BE IN ACCORDANCE WITH THE CITY OF BRYANT " STANDARD

2. ALL SEWER LINES CROSSING UNDER ALL CONCRETE STORM DRAINS OR ANY STORM DRAIN 30-INCH DIAMETER AND LARGER, OR ALL STORM DRAINS WITH MULTIPLE PIPE RUNS, SHALL BE

STEEL ENCASED A MINIMUM OF 5 FEET EITHER SIDE OF THE STORM DRAIN.

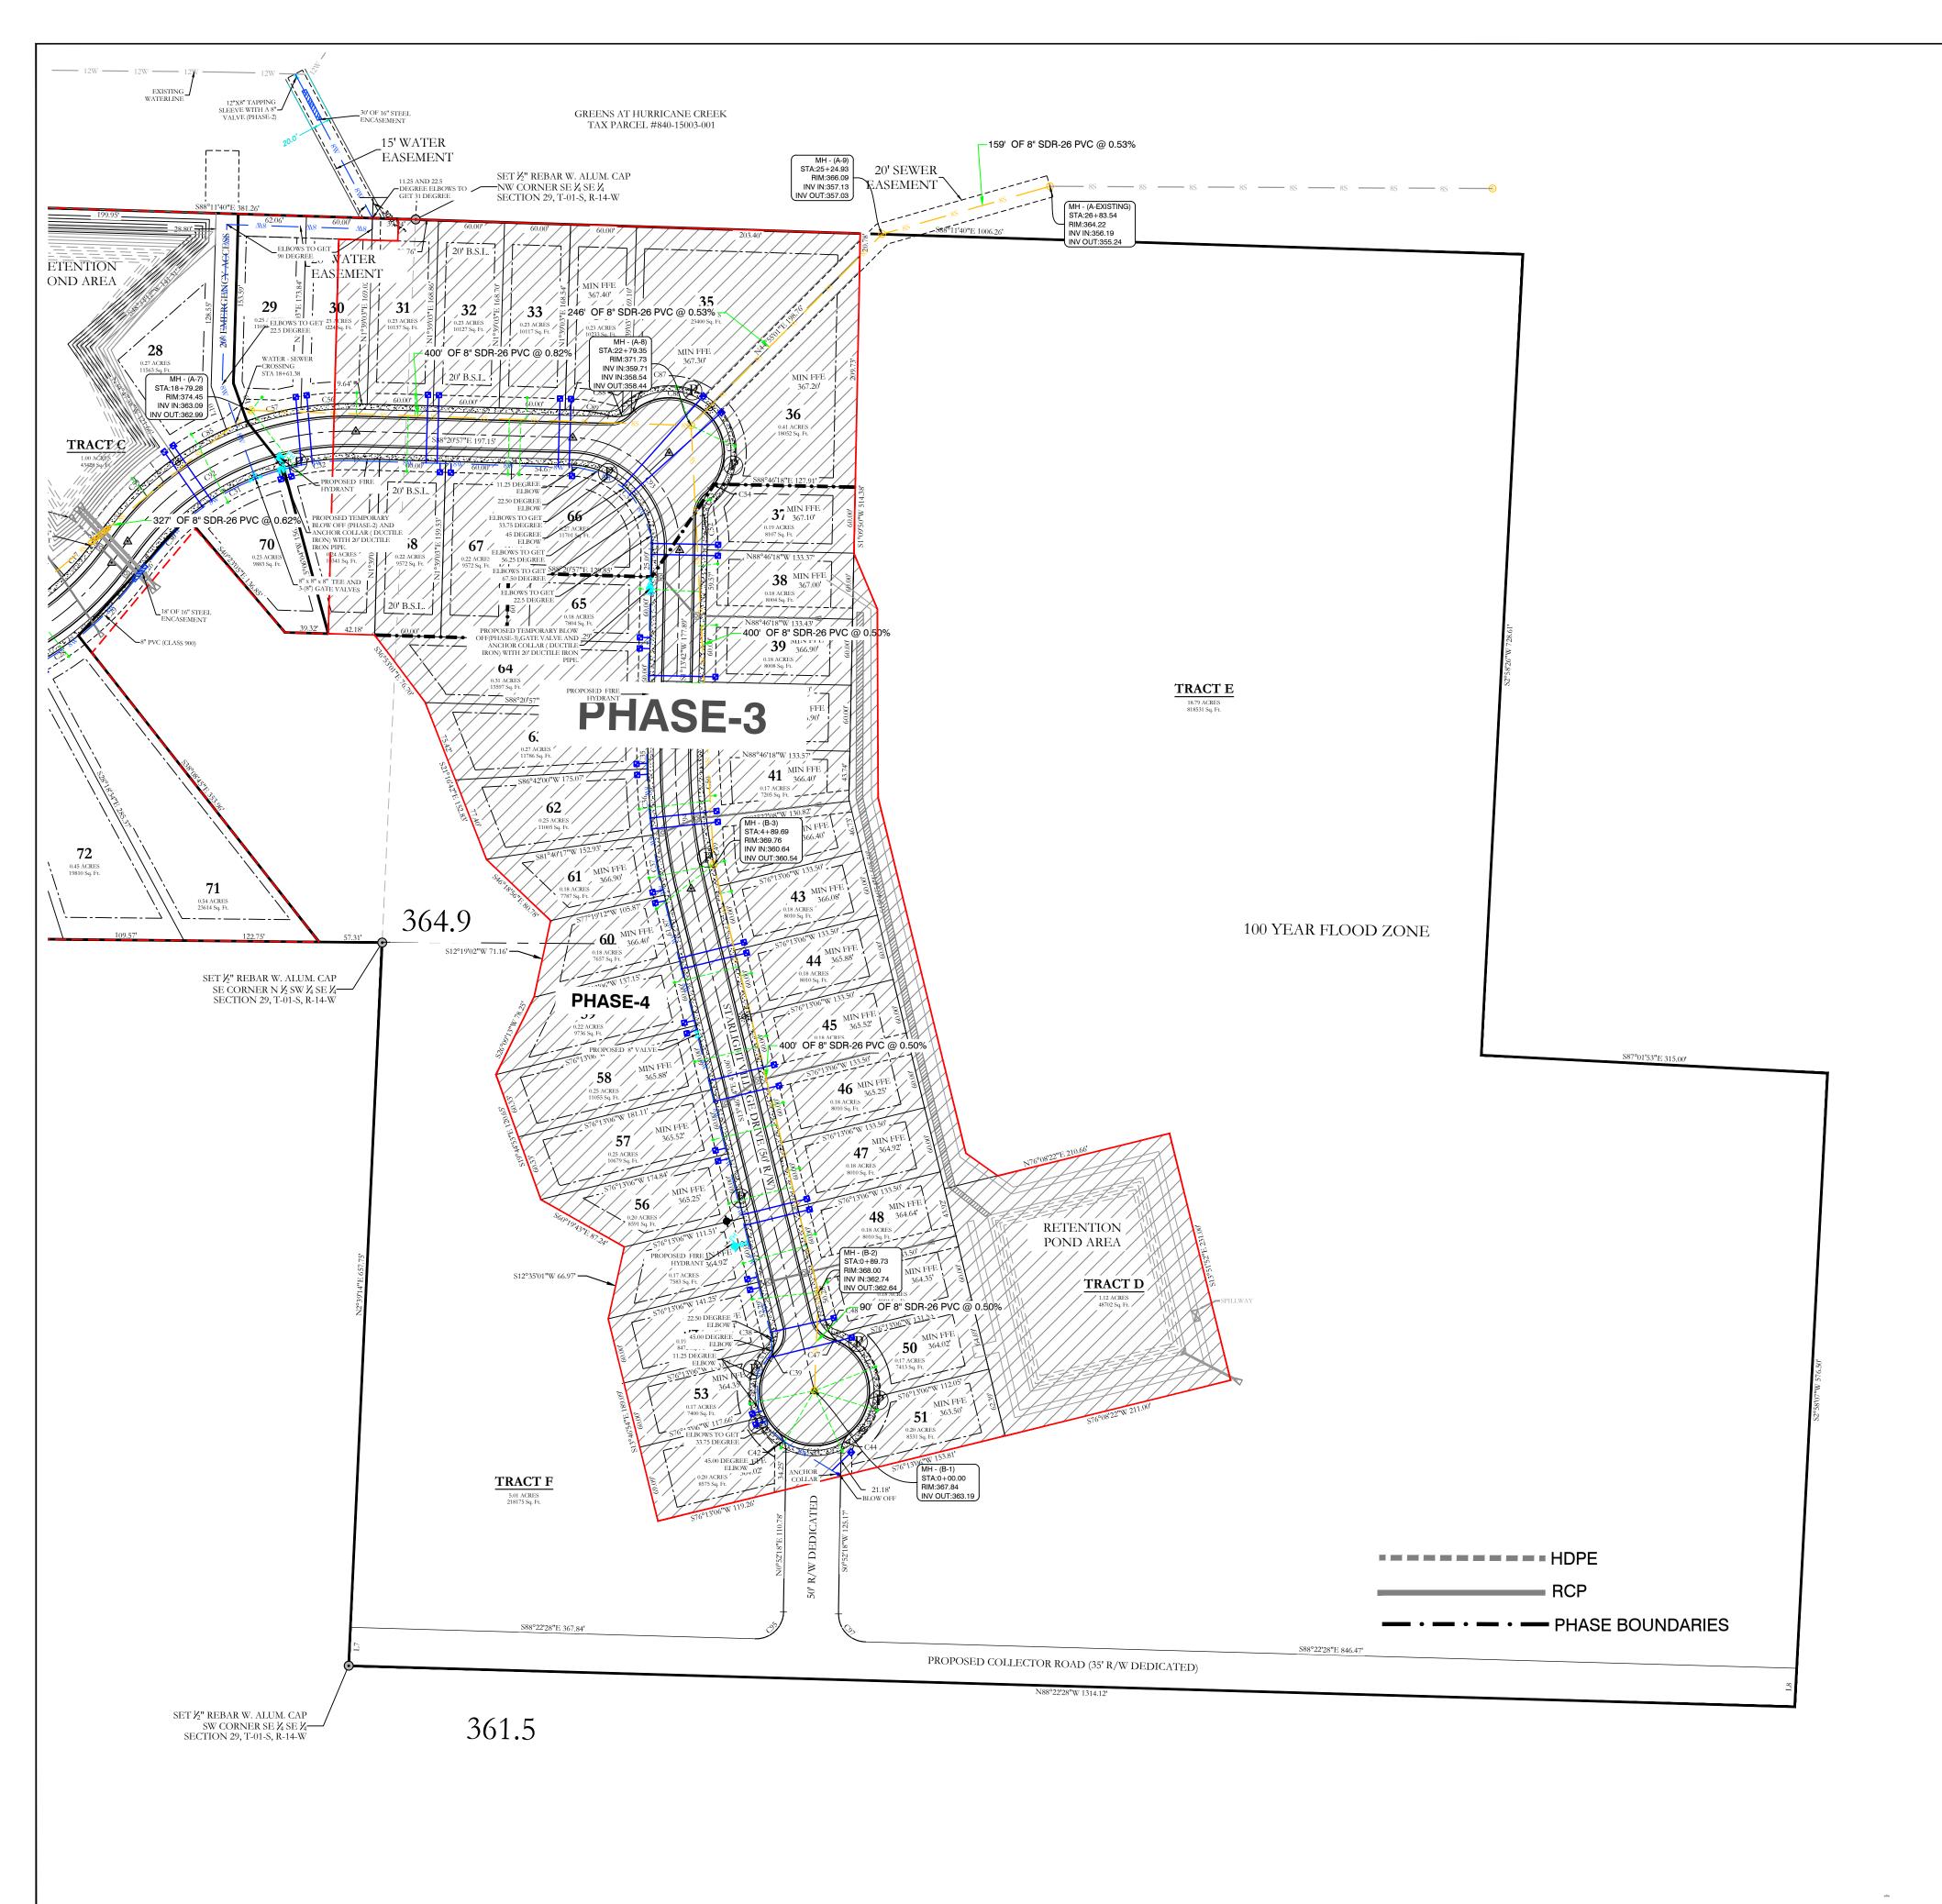

### WATER & SEWER UTILITY NOTES:


- 1. ALL NEW 8-INCH WATER MAINS TO BE CLASS 900.
- 2. ALL WATER MAINS LARGER THAN 8" DIAMETER SHALL BE DUCTILE IRON (250 PSI PRESSURE
- 3. ALL WATER AND SEWER INSTALLATION TO BE IN ACCORDANCE WITH THE CITY OF BRYANT "STANDARD SPECIFICATIONS FOR DESIGN AND CONSTRUCTION OF WATER LINES AND SEWER LINES, 2015 EDITION.
- 4. WATER LINES UNDER CULVERTS, CREEKS, CONCRETE CHANNELS, RETAINING WALLS, OR OTHER DIFFICULT AND /OR DANGEROUS TO MAINTAIN AREAS SHALL BE ENCASED IN A SMOOTH STEEL ENCASEMENT PIPE. THE STEEL ENCASEMENT SHALL EXTEND FIVE FEET EITHER SIDE OF
- 5. EACH WATER SERVICE METER MUST HAVE ITS OWN SERVICE LINE CONNECTION TO THE MAIN (INCLUDES DOUBLE METERS DISPLAYED AS ONE SERVICE LINE ON THE PLAT.
- 6. WATER MAIN CONNECTION TO THE NORTH WILL BE CONSTRUCTED IN PHASE 2, CONNECTION TO THE SOUTH WILL BE IN THE FINAL PHASE.

### SEWER CONSTRUCTION NOTES:

- 1. ALL SEWER INSTALLATION TO BE IN ACCORDANCE WITH THE CITY OF BRYANT " STANDARD SPECIFICATIONS FOR DESIGN AND CONSTRUCTION OF WATER LINES AND SEWER LINES, 2015
- 2. ALL SEWER LINES CROSSING UNDER ALL CONCRETE STORM DRAINS OR ANY STORM DRAIN 30-INCH DIAMETER AND LARGER, OR ALL STORM DRAINS WITH MULTIPLE PIPE RUNS, SHALL BE STEEL ENCASED A MINIMUM OF 5 FEET EITHER SIDE OF THE STORM DRAIN.

### VERTICAL SEPARATION OF WATER AND SANITARY SEWER NOTE:

WATER MAINS AND SANITARY SEWERS SHALL BE CONSTRUCTED AS FAR APART AS PRACTICABLE, AND SHALL BE SEPARATED BY UNDISTURBED AND COMPACT EARTH. A MINIMUM HORIZONTAL DISTANCE OF 10-FEET SHOULD BE MAINTAINED BETWEEN WATER LINES AND SEWER LINES OR OTHER SOURCES OF CONTAMINATION. WATER MAINS NECESSARILY IN CLOSE PROXIMITY TO SEWER MUST BE PLACED SO THAT THE BOTTOM OF THE WATER LINE WILL BE AT LEAST 18 INCHES ABOVE THE TOP OF THE SEWER LINE. IF THIS DISTANCE MUST UNAVOIDABLY PASS BENEATH THE SEWER LINE, AT LEAST 18-INCHES SEPARATION MUST BE MAINTAINED BETWEEN THE OUTSIDE OF THE TWO PIPES IN ADDITION TO THE PRECEDING ENCASEMENT REQUIREMENT.

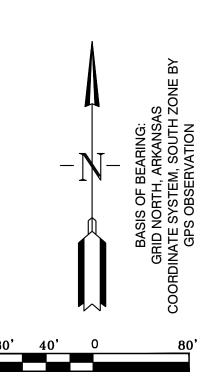







SEWER LEGEND:	[
SEWER SERVICE	
SEWER MAIN S SEWER MANHOLE	
NOTE: USE SDR-26 PVC SEWER PIPE EXCEPT WHERE DUCTILE IRON PIPE REQUIRED FOR COVER. USE DUCTILE IRON PIPE WHERE 3' MINIMUM COVER CANNOT BE MAINTAINED.	
CONTRACTOR IS RESPONSIBLE FOR LOCATING ALL BURIED UTILITIES PRIOR TO CONSTRUCTION.	

## WATER LEGEND: P DUAL WATER METERS

- SINGLE WATER METER ▼ GATE VALVE
- 45º FITTING ♦ 90º FITTING
- TEE FITTING CROSS FITTING


FIRE HYDRANT

STARLIGHT VILLAGE SUBDIVISION

FOR USE AND BENEFIT OF: WIGGINS FAMILY REAL ESTATE HOLDINGS, LLC

UTILITY PLAN A SUBDIVISION IN CITY OF BRYANT, SALINE COUNTY, ARKANSAS

C.A.D. BY: DRAWING NUMBER: REVISED: CHECKED BY: SHEET: 1S 15W 0 34 230 62 1807

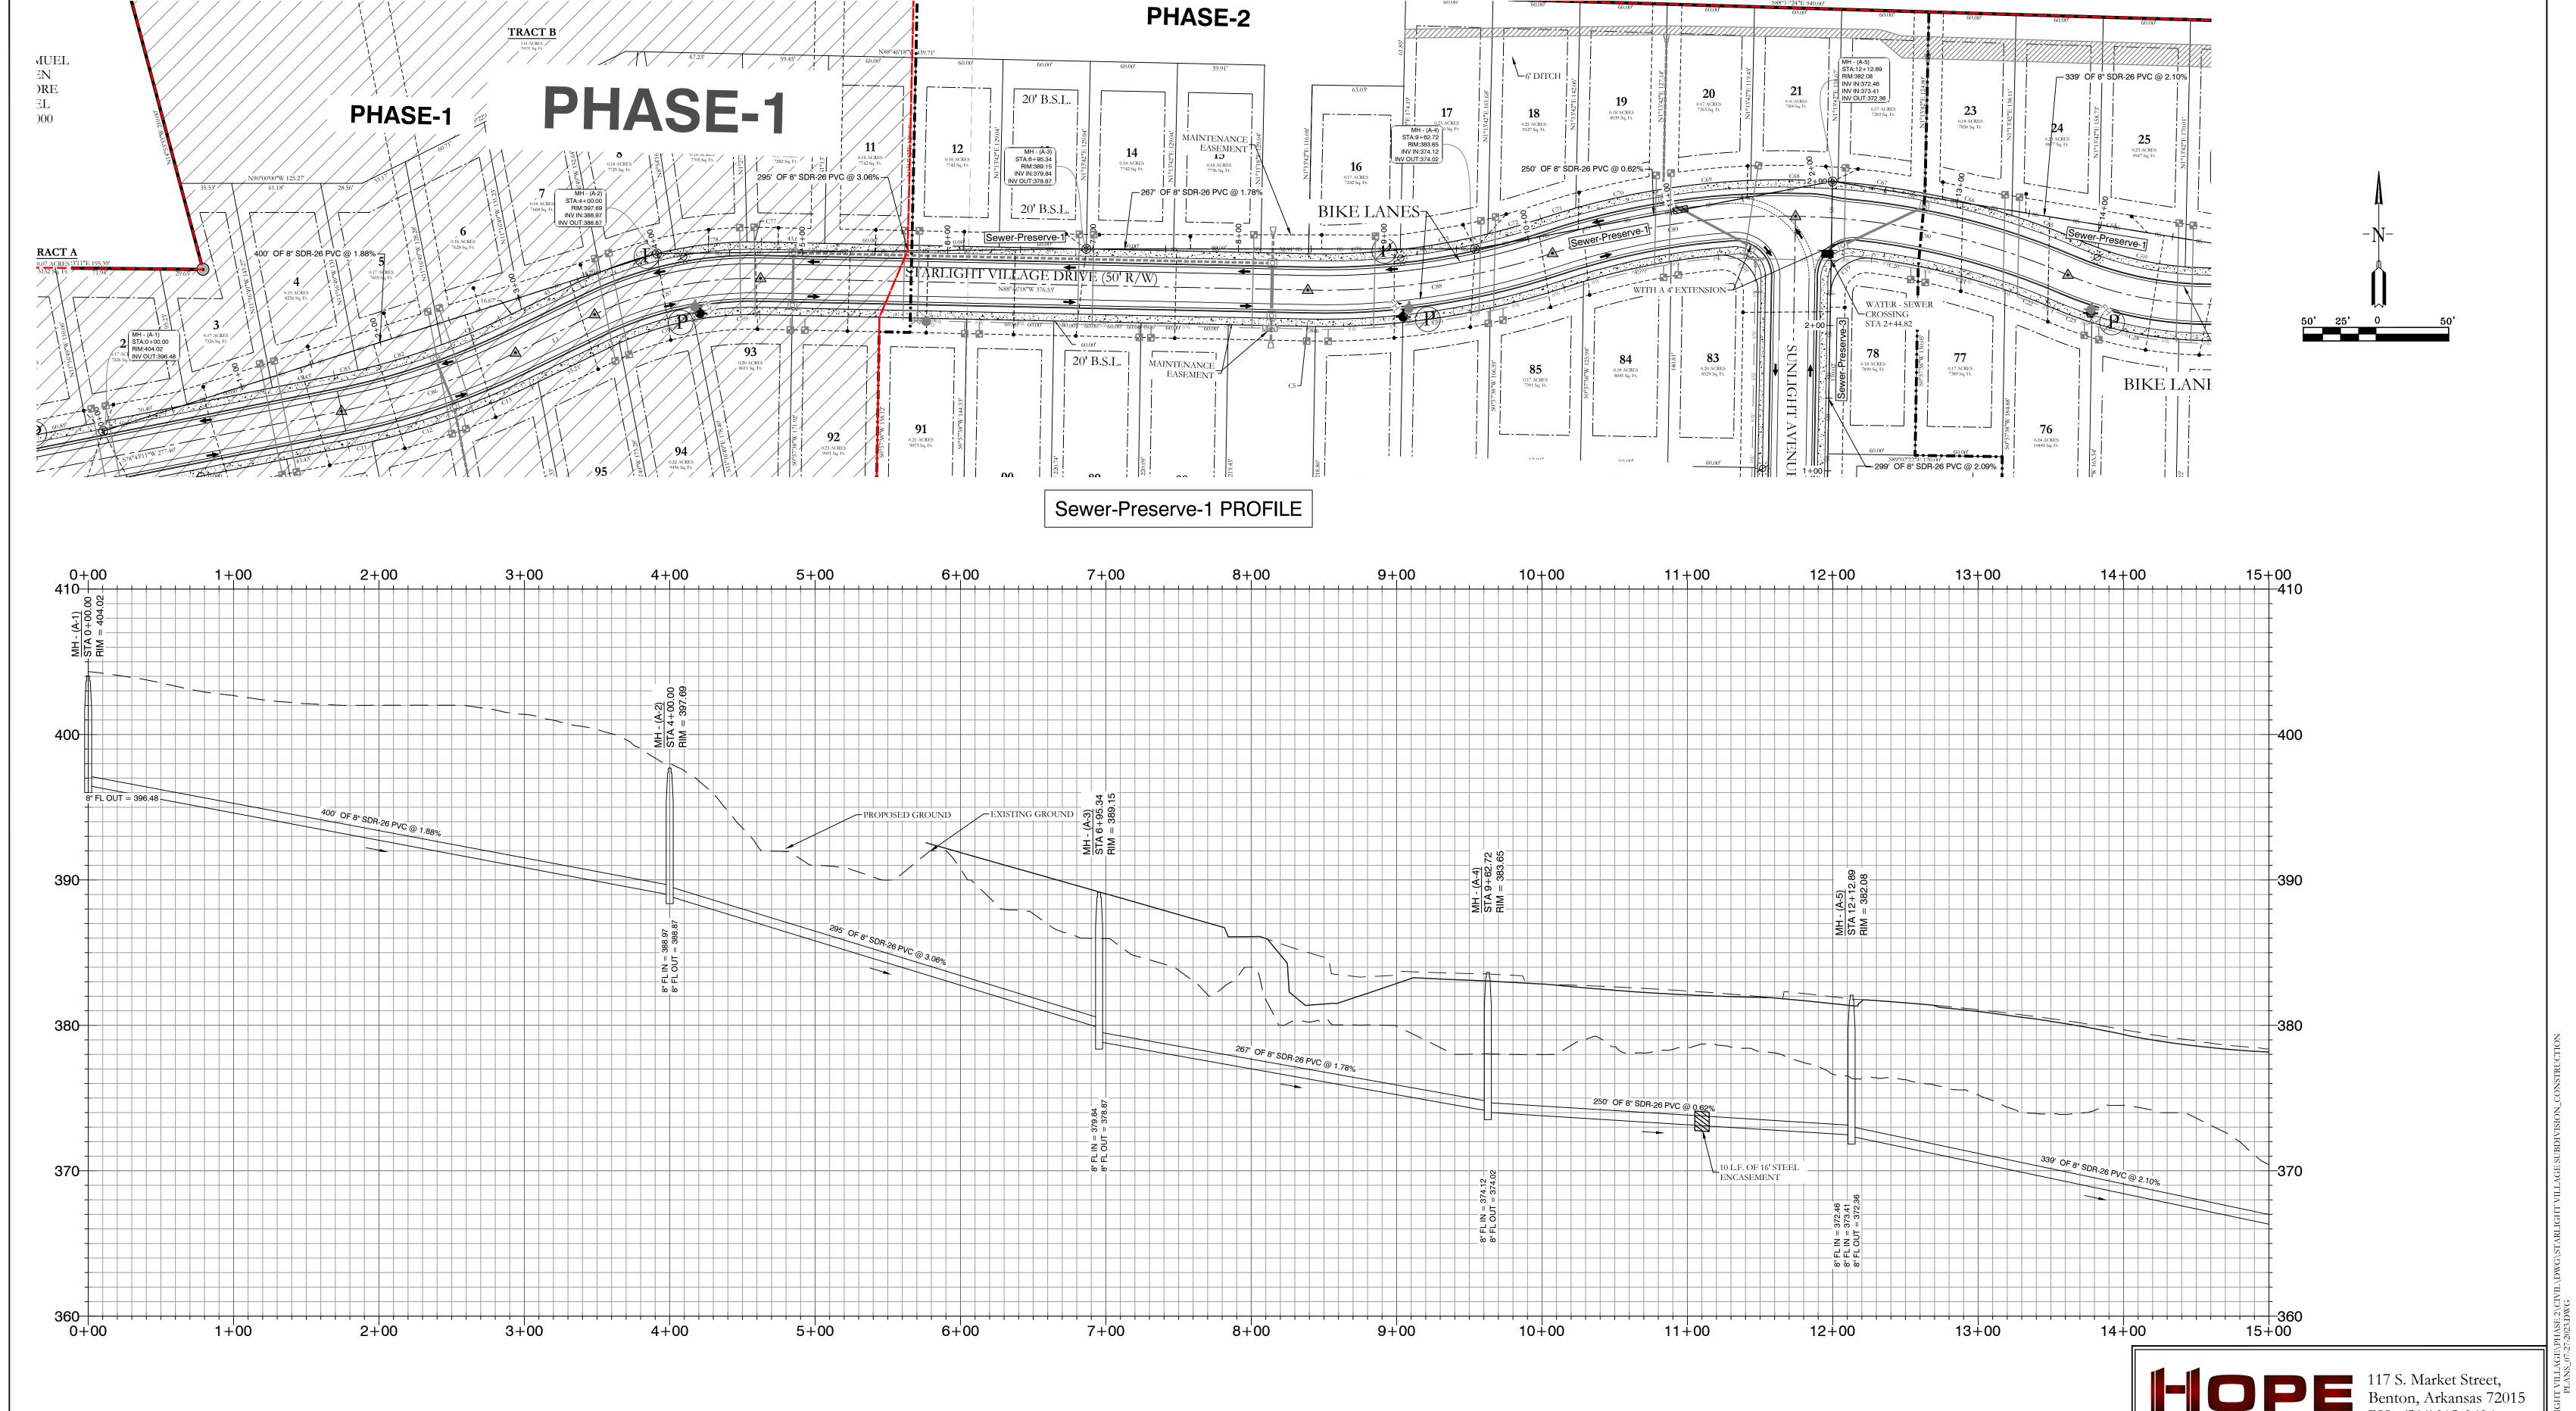







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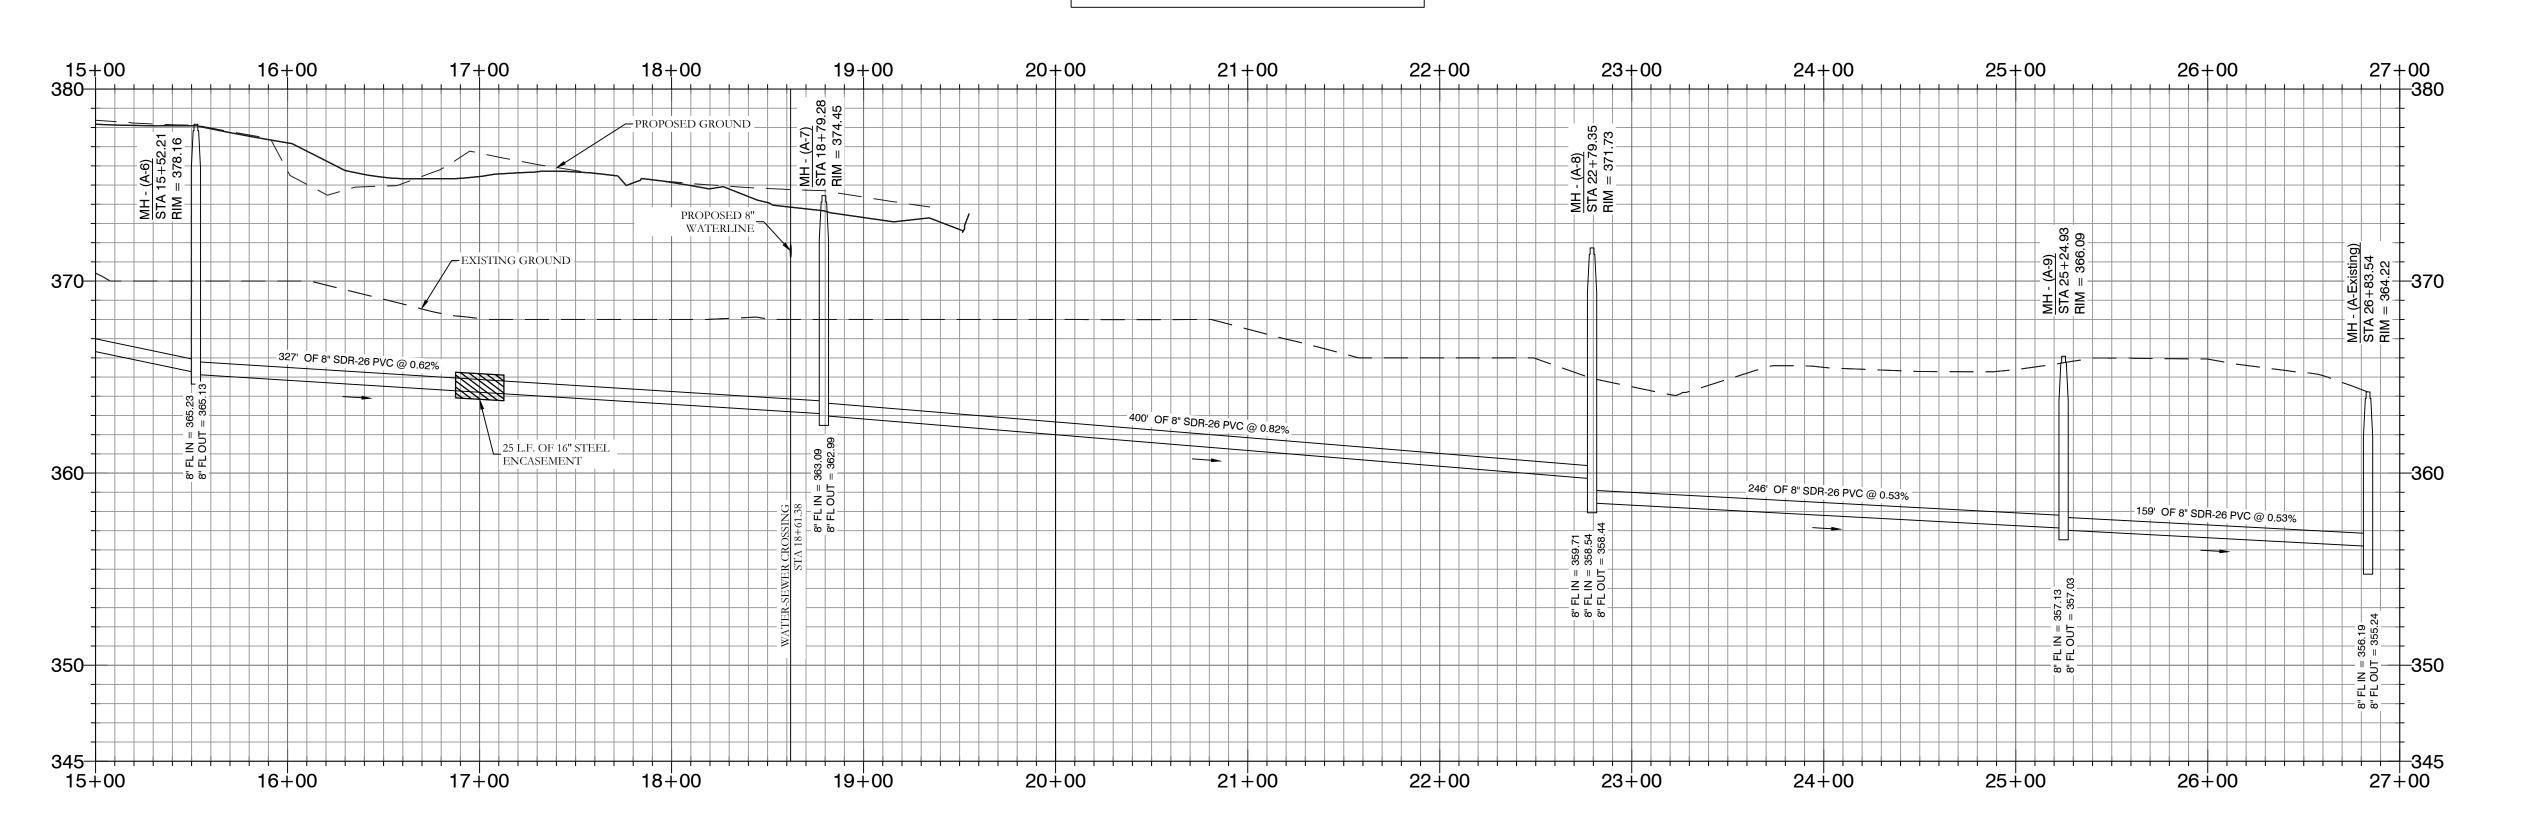
WIGGINS FAMILY REAL ESTATE HOLDINGS, LLC

STARLIGHT VILLAGE SUBDIVISION
SEWER PLAN AND PROFILE
A SUBDIVISION IN CITY OF BRYANT, SALINE COUNTY, ARKANSAS

DATE:	10/5/2023	C.	A.D. BY	:		DRAWING NUMBER:		
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K:\LAND PROJECTS 2004\SUBDIV

## Sewer-Preserve-1 PROFILE










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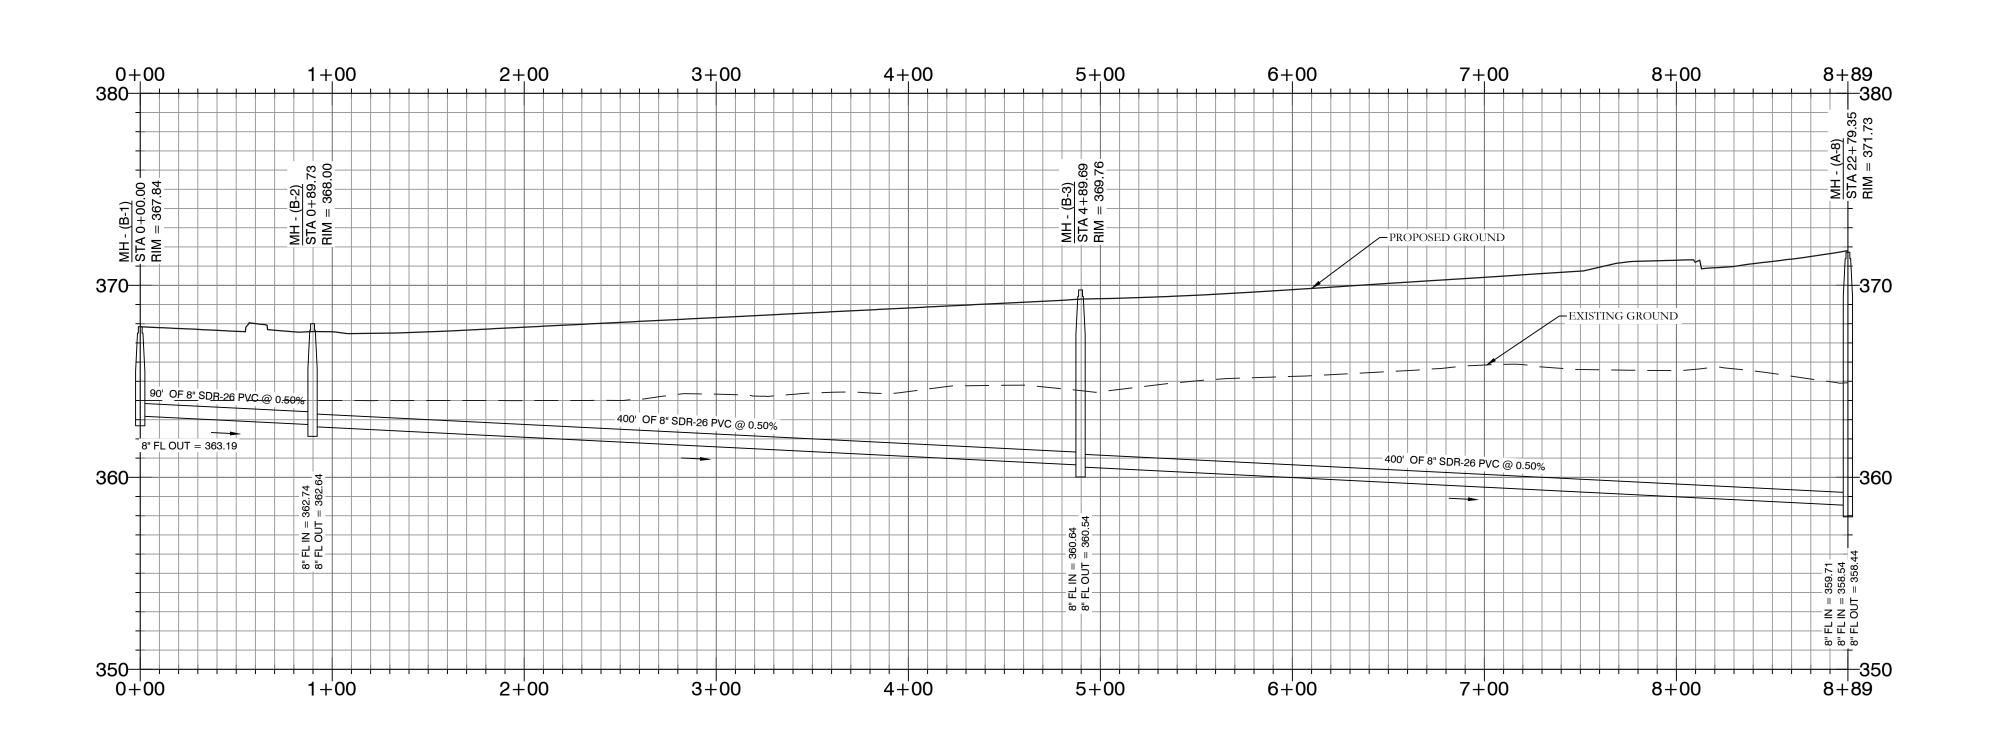
WIGGINS FAMILY REAL ESTATE HOLDINGS, LLC


STARLIGHT VILLAGE SUBDIVISION SEWER PLAN AND PROFILE A SUBDIVISION IN CITY OF BRYANT, SALINE COUNTY, ARKANSAS

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117 S. Market Street,
Benton, Arkansas 72015
PH. (501)315-2626
FAX (501) 315-0024

FOR USE AND BENEFIT OF:


WIGGINS FAMILY REAL ESTATE HOLDINGS, LLC

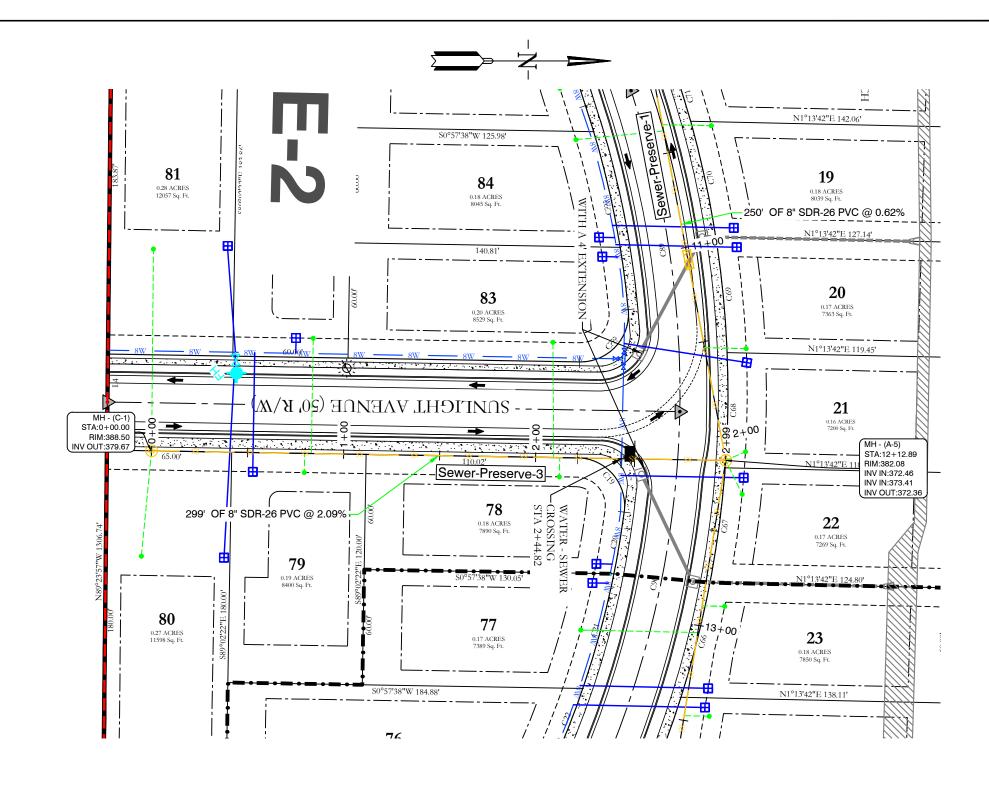STARLIGHT VILLAGE SUBDIVISION SEWER PLAN AND PROFILES

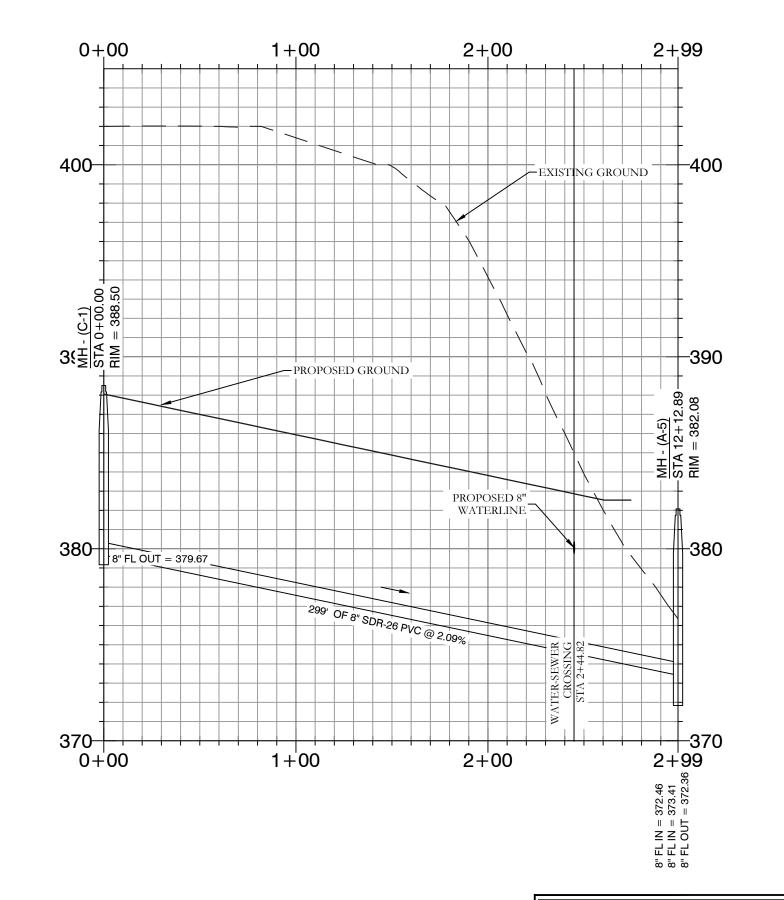A	A SUBDIVISION IN CITY OF BRYANT, SALINE COUNTY, ARKANSAS												
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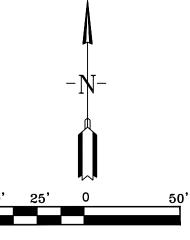
# 6'DITCH

## GENERAL NOTES

- 6' ditches will have a 3:1 slope ratio
- 6' ditches will have solid sod stabilization

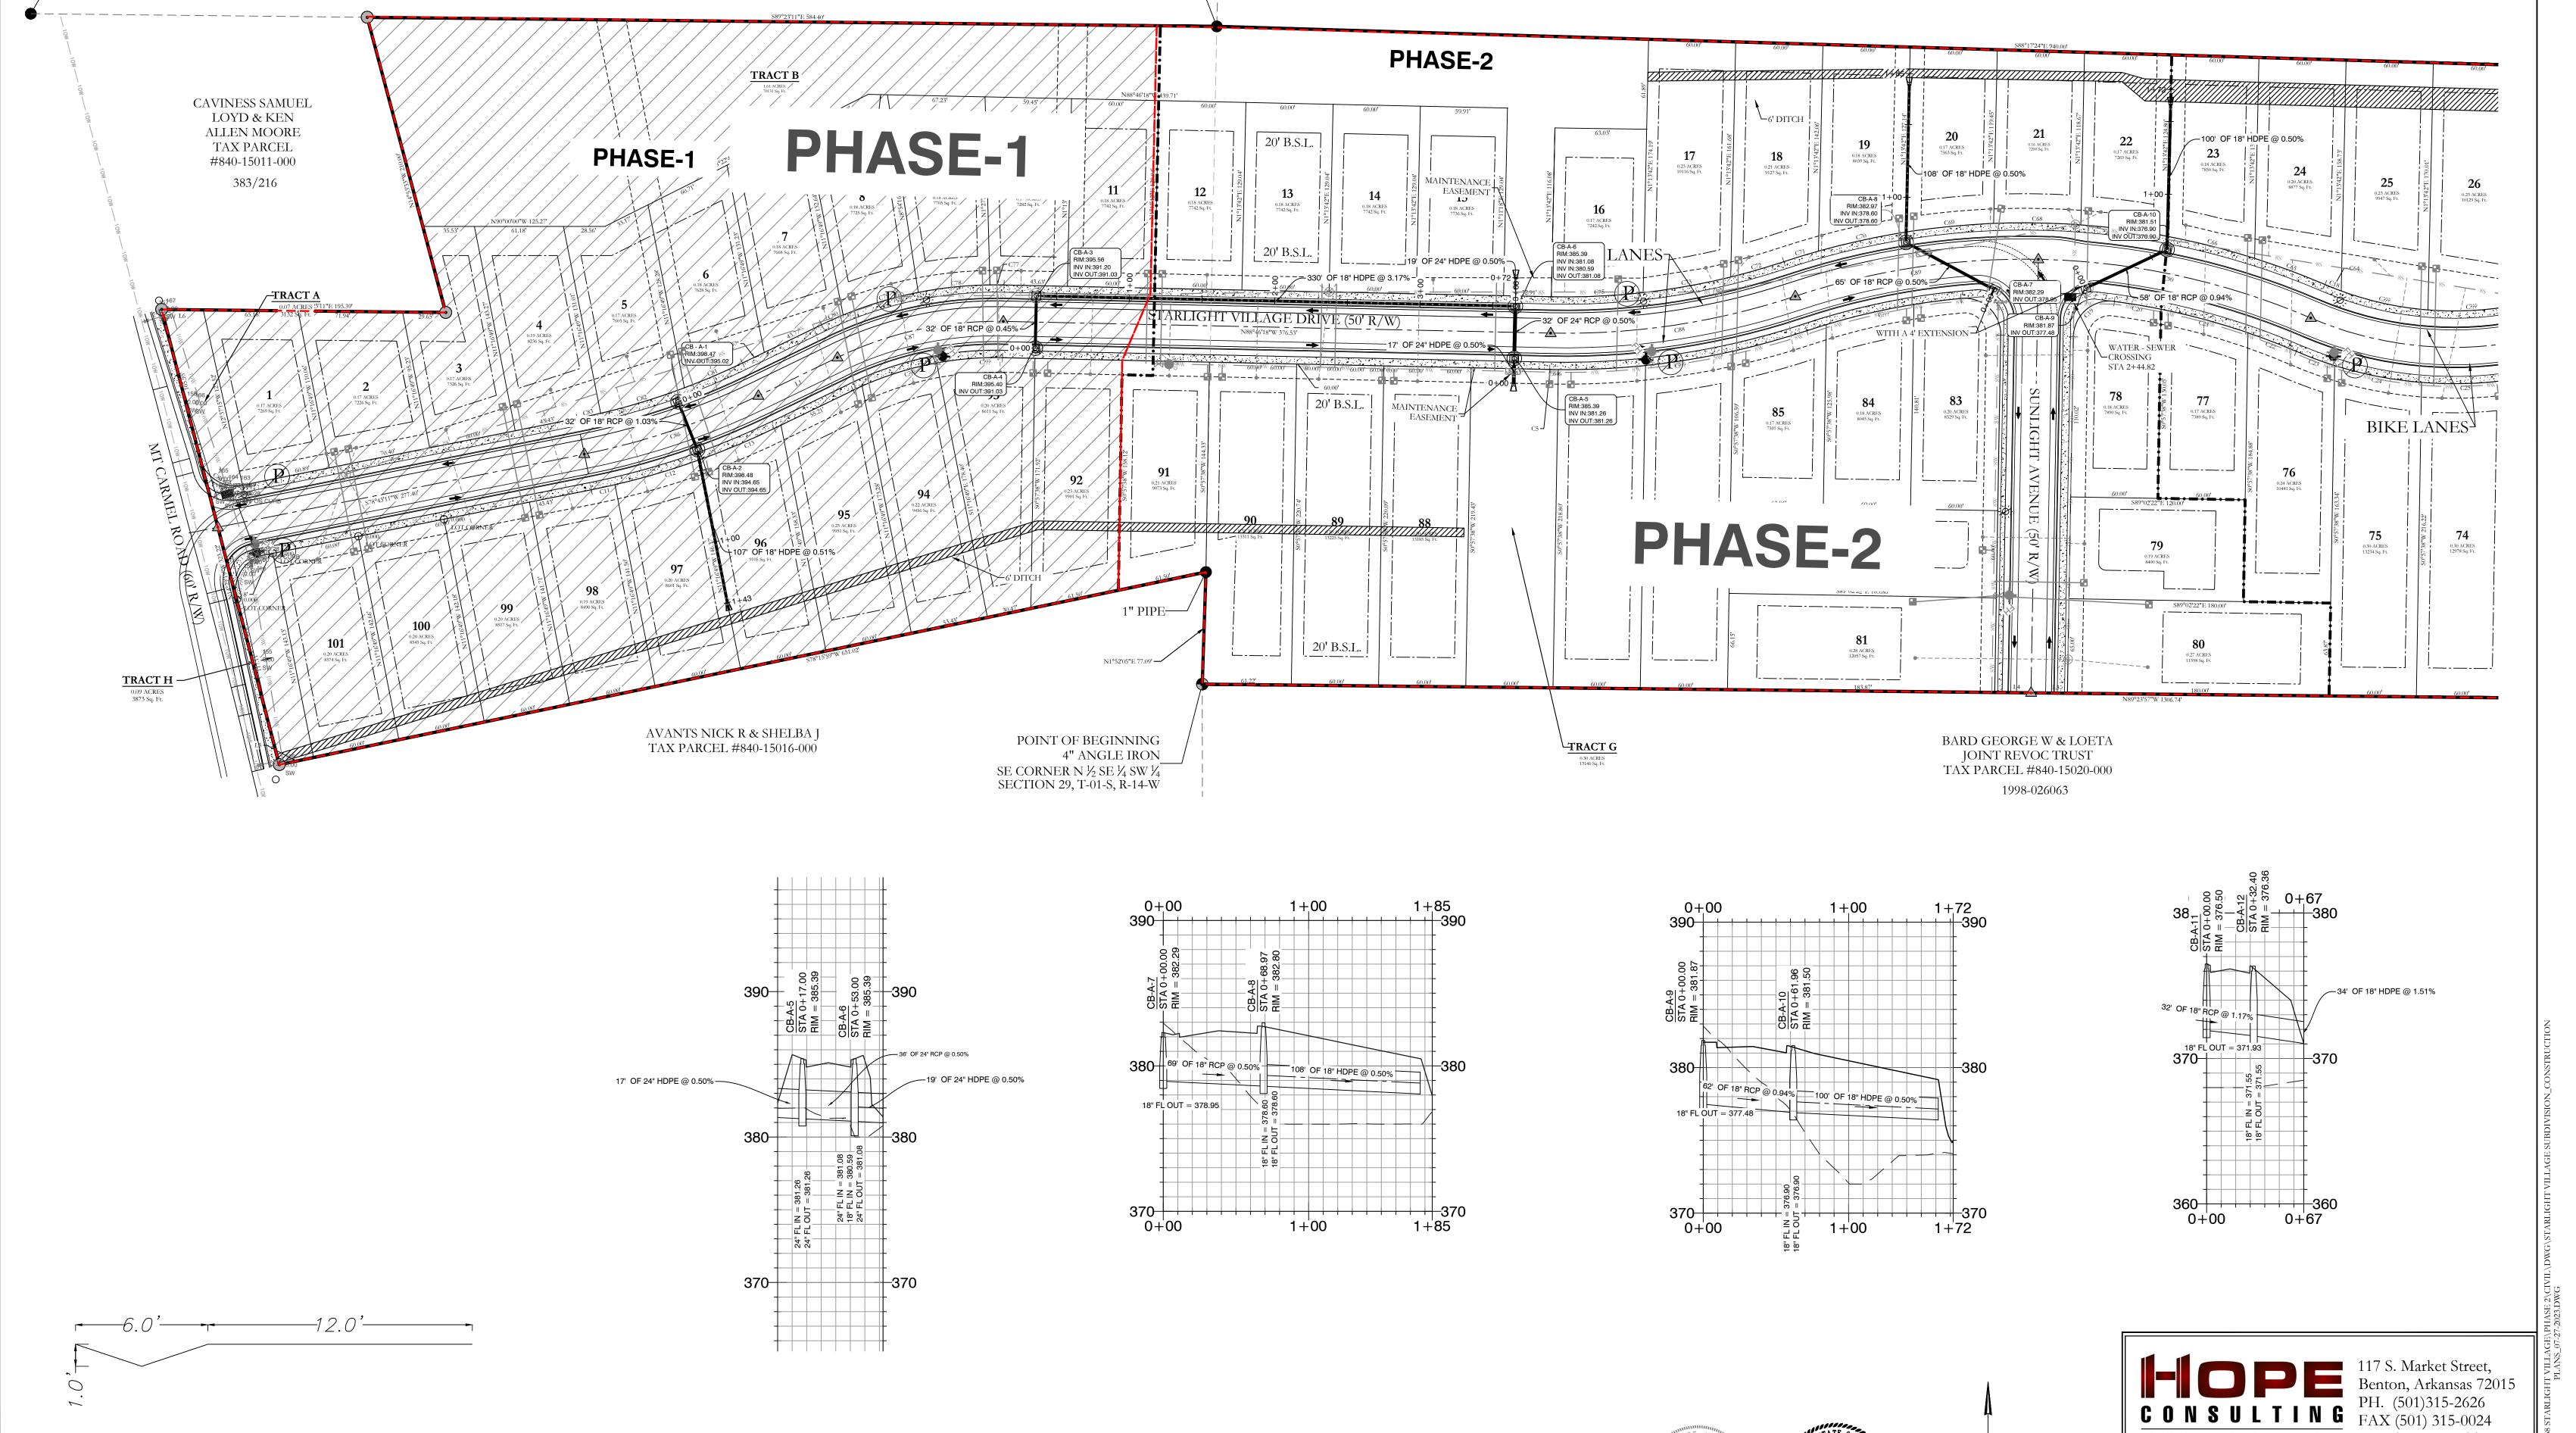








ENGINEERS - SURVEYORS www.hopeconsulting.com


FOR USE AND BENEFIT OF:

WIGGINS FAMILY REAL ESTATE HOLDINGS, LLC

STARLIGHT VILLAGE SUBDIVISION STROM DRAINAGE PLAN AND PROFILE A SUBDIVISION IN CITY OF BRYANT, SALINE COUNTY, ARKANSAS

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117 S. Market Street,
Benton, Arkansas 72015
PH. (501)315-2626
FAX (501) 315-0024 ENGINEERS - SURVEYORS www.hopeconsulting.com

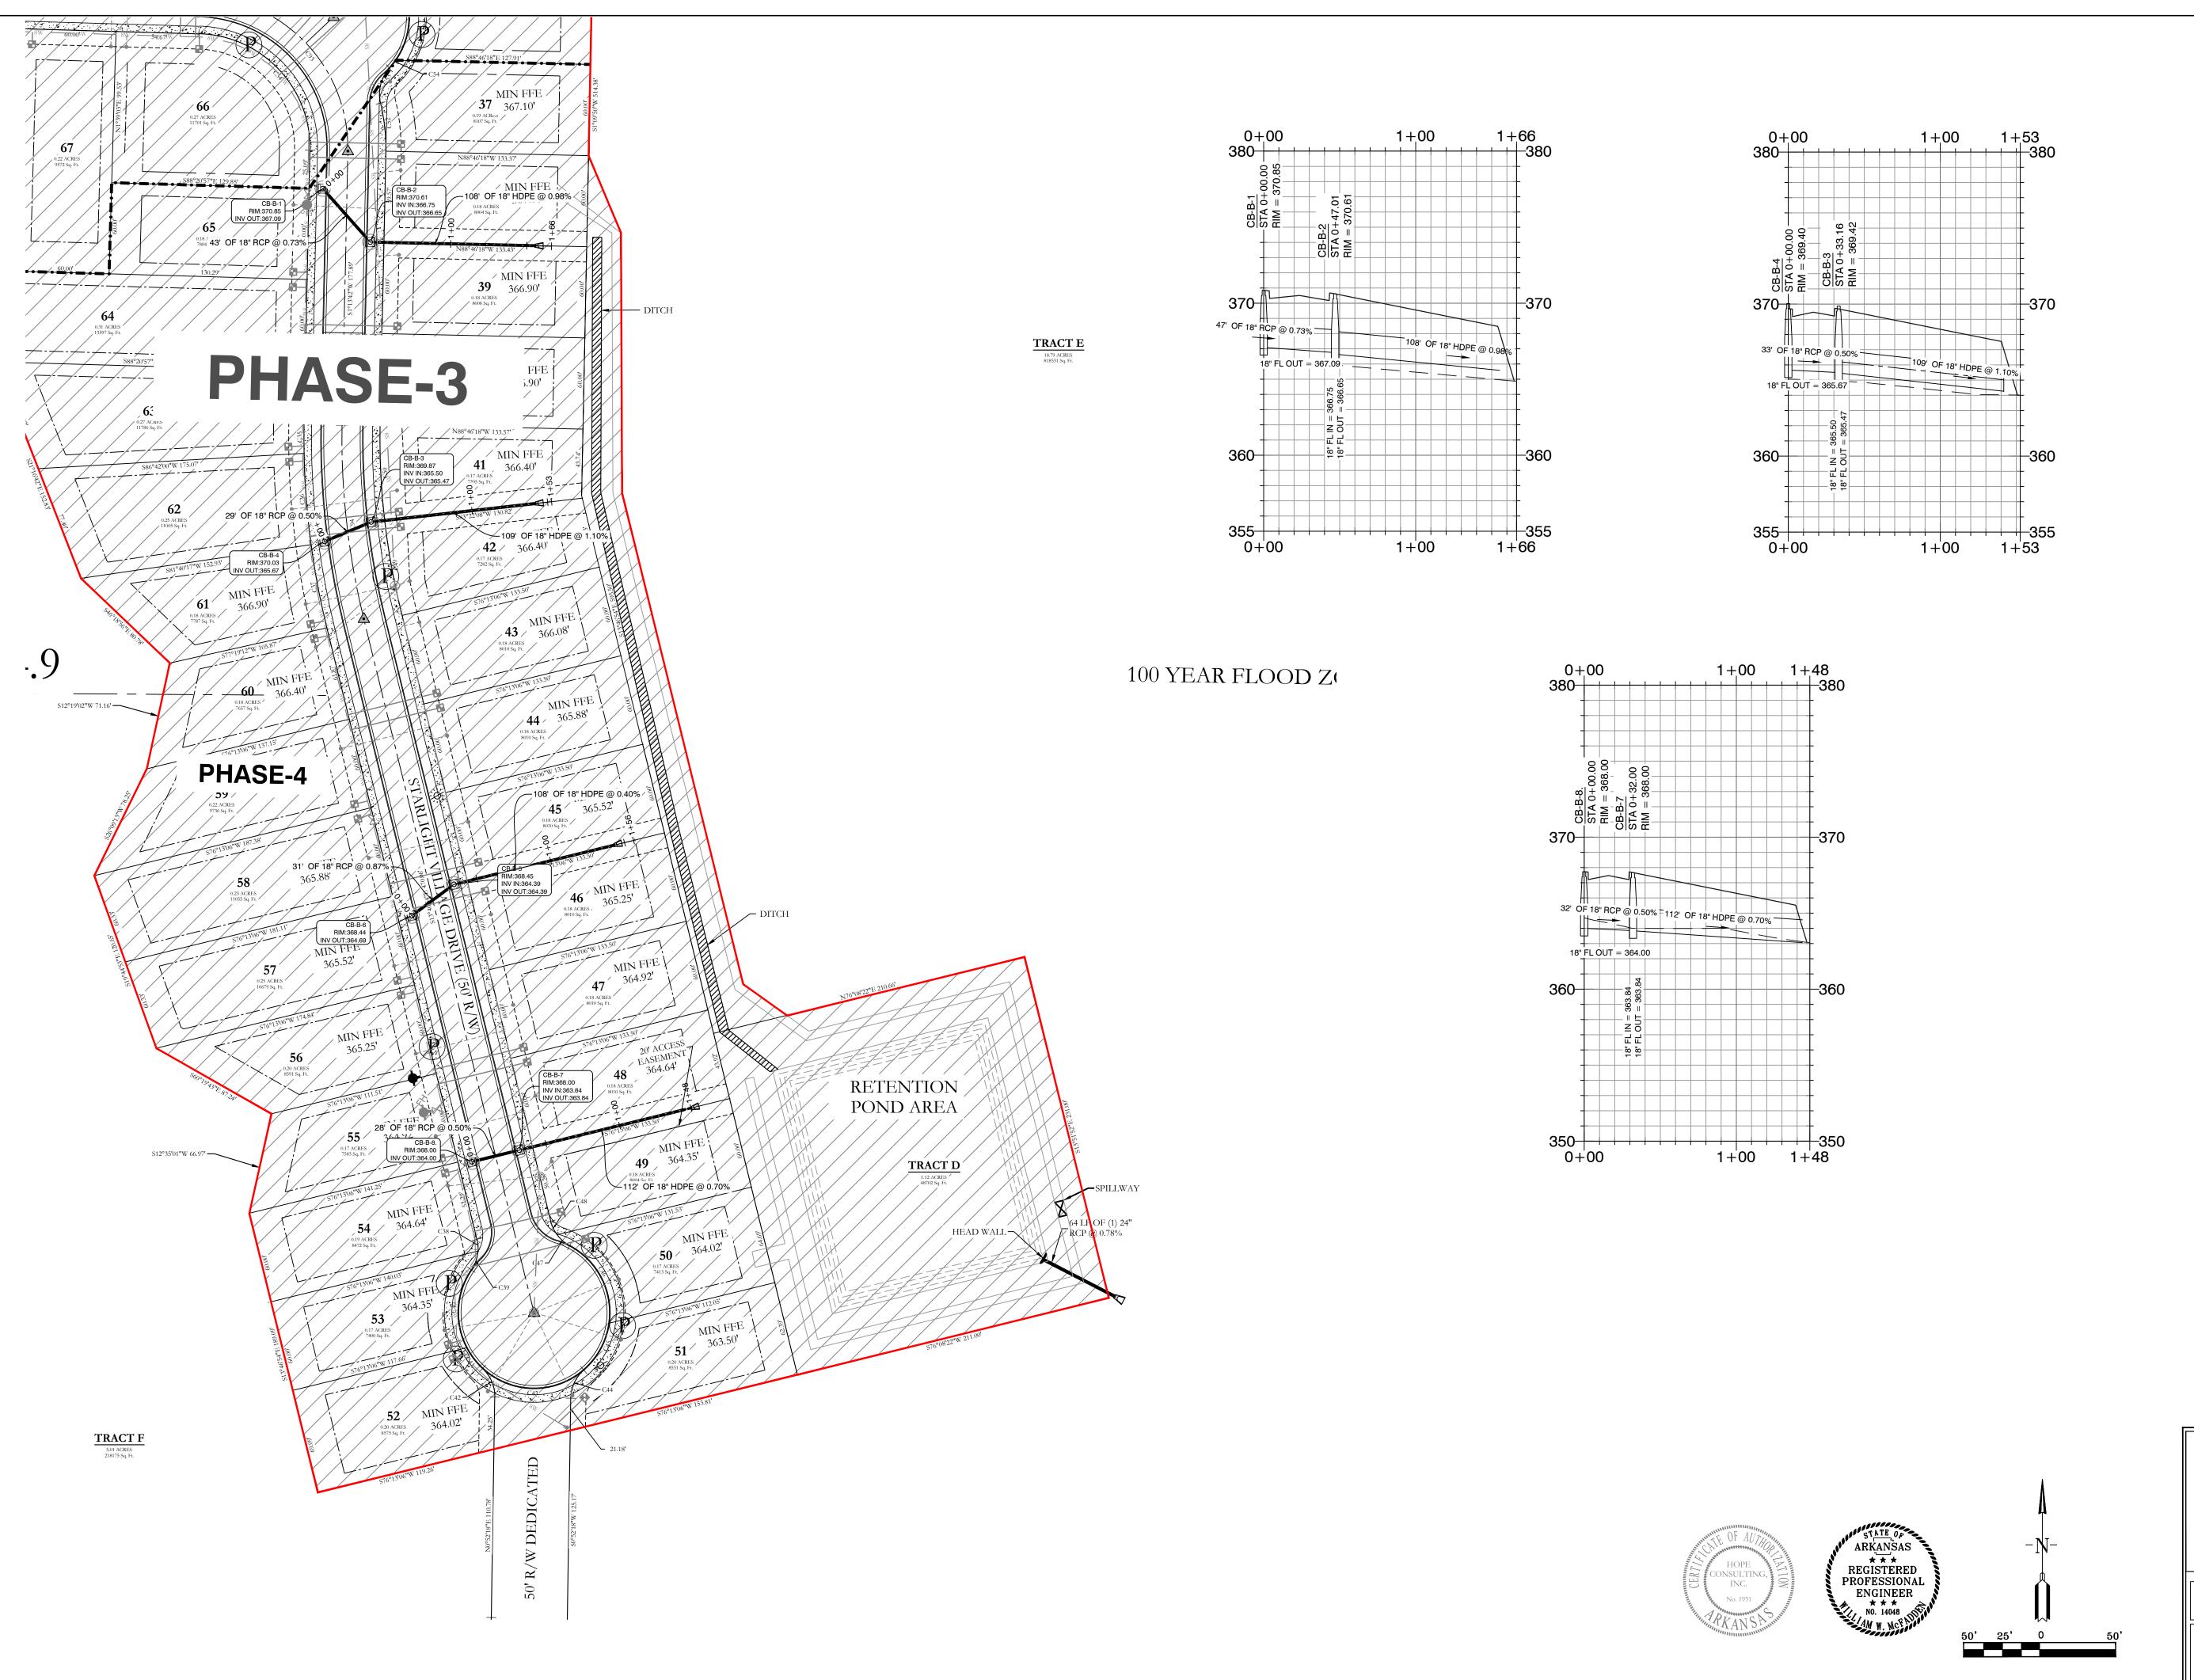FOR USE AND BENEFIT OF:

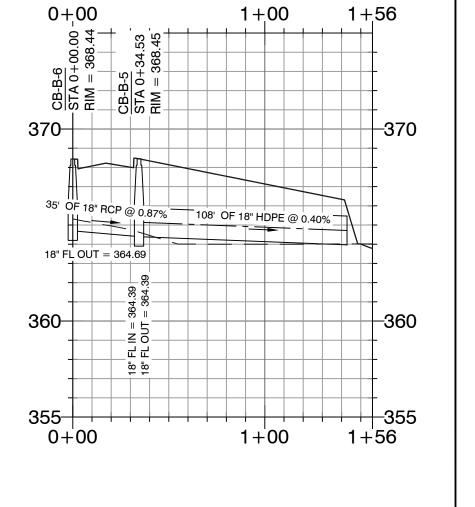WIGGINS FAMILY REAL ESTATE HOLDINGS, LLC

STARLIGHT VILLAGE SUBDIVISION STROM DRAINAGE PROFILES A SUBDIVISION IN CITY OF BRYANT, SALINE COUNTY, ARKANSAS


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## **PVC SEWER TRENCH UNDER FUTURE ASPHALT STREET**


1. IN LAWN AREAS, DISTURBED SOIL PLACEMENT OF SOD TO MATCH 2. IN FIELDS OR WOODED AREAS, DISTURBED SOIL SHALL BE

STABILIZED BY SEEDING.

CLEAR AND GRUB FULL WIDTH OF RIGHT-OF-WAY WIDTH

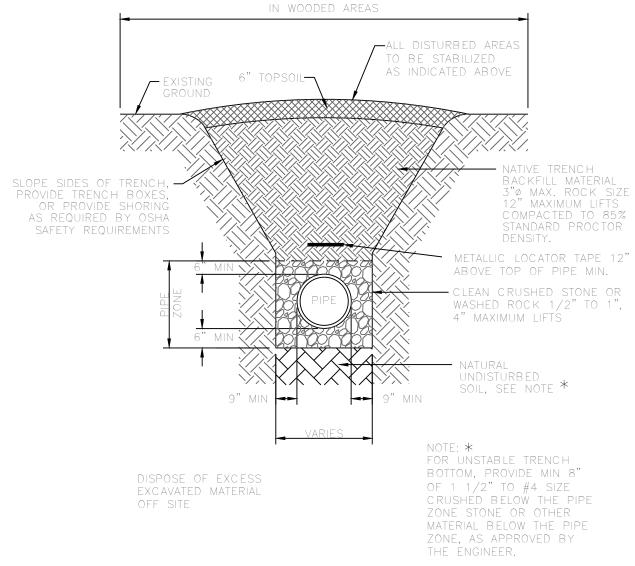

PVC SEWER TRENCH IN UNPAVED AREAS

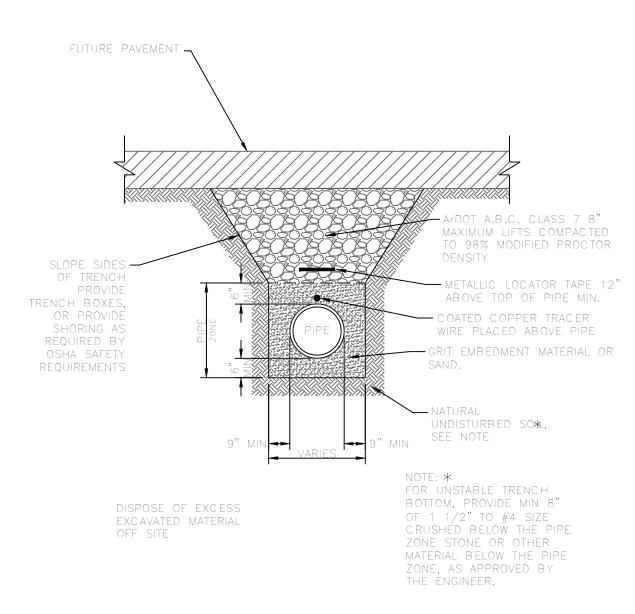


## PVC WATER LINE TRENCH UNDER FUTURE ASPHALT STREET

1. IN LAWN AREAS, DISTURBED SOIL SHALL BE STABILIZED BY


PLACEMENT OF SOD TO MATCH 2. IN FIELDS OR WOODED AREAS,

DISTURBED SOIL SHALL BE STABILIZED BY SEEDING.

CLEAR AND GRUB FULL WIDTH OF RIGHT-OF-WAY WIDTH

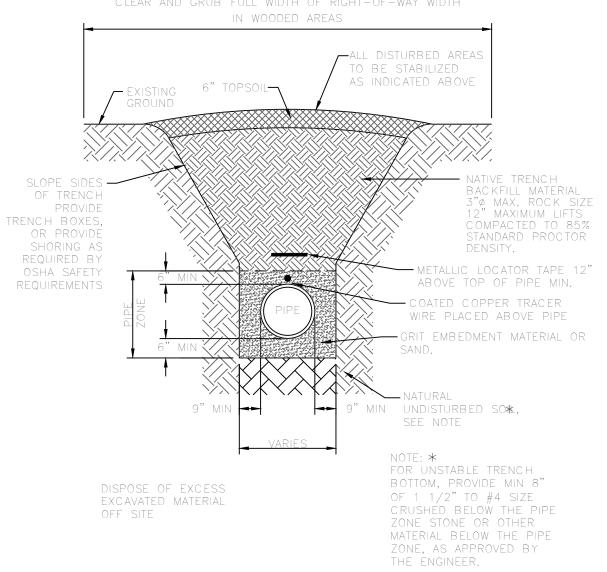

## **PVC WATER LINE TRENCH** IN UNPAVED AREAS

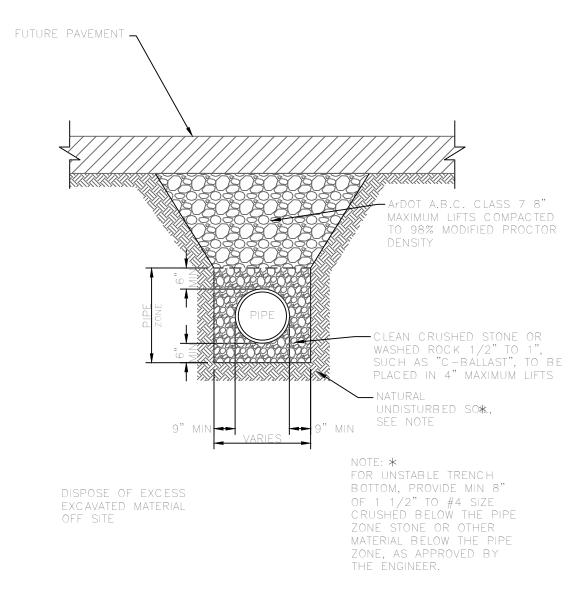


## DRAINAGE PIPE TRENCH UNDER **FUTURE ASPHALT STREET**

1. IN LAWN AREAS, DISTURBED SOIL SHALL BE STABILIZED BY PLACEMENT OF SOD TO MATCH

2. IN FIELDS OR WOODED AREAS, DISTURBED SOIL SHALL BE STABILIZED BY SEEDING.

CLEAR AND GRUB FULL WIDTH OF RIGHT-OF-WAY WIDTH

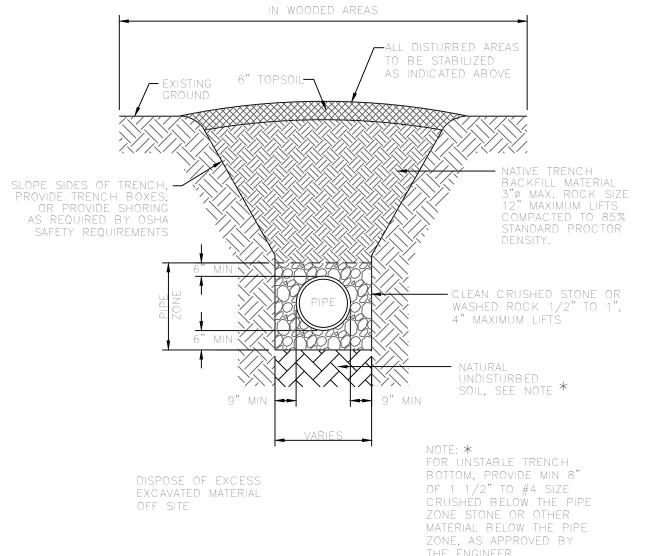

## DRAINAGE PIPES IN UNPAVED AREAS





FOR USE AND BENEFIT OF: WIGGINS FAMILY REAL ESTATE HOLDINGS, LLC


STARLIGHT VILLAGE SUBDIVISION TRENCH DETAILS


A SUBDIVISION IN CITY OF BRYANT, SALINE COUNTY, ARKANSAS DRAWING NUMBER:


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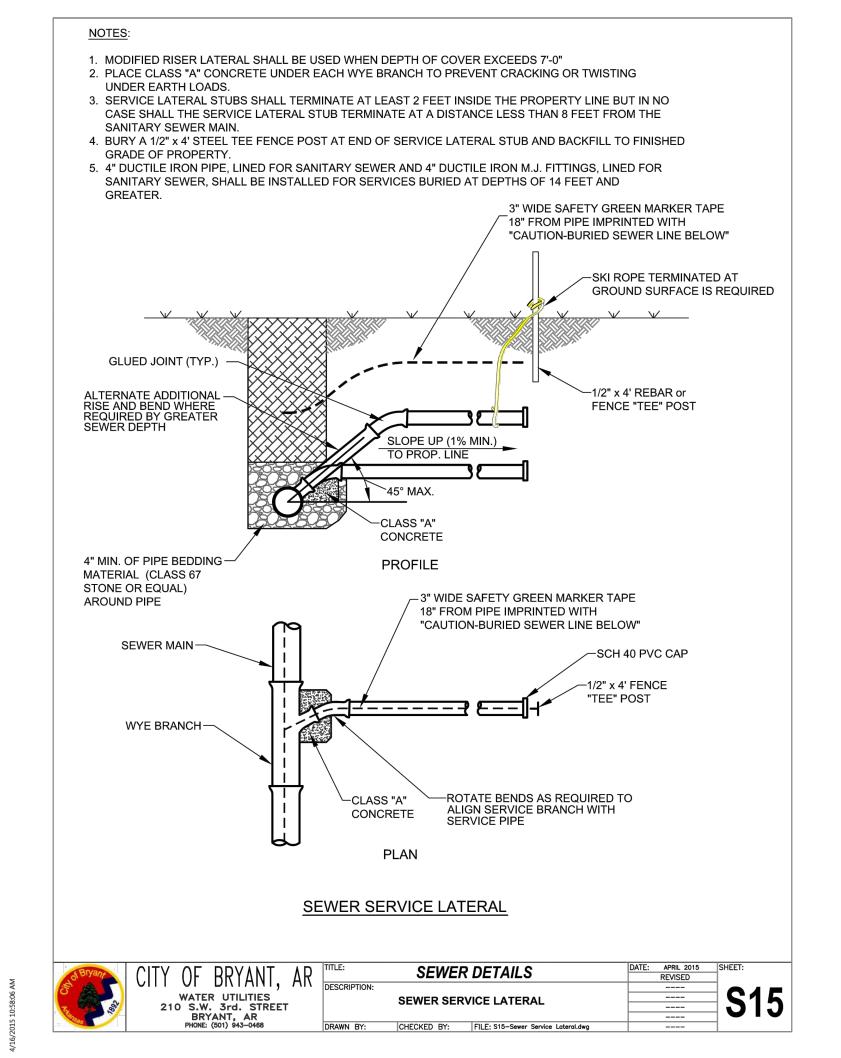


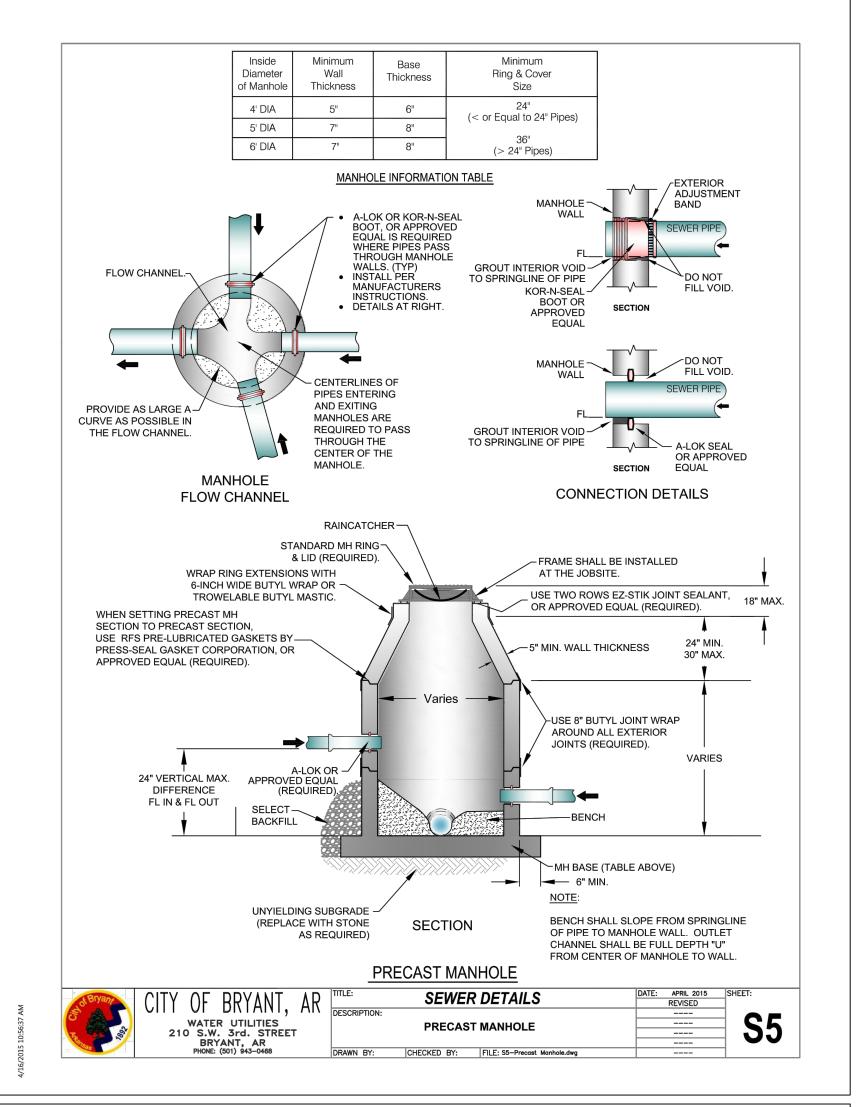

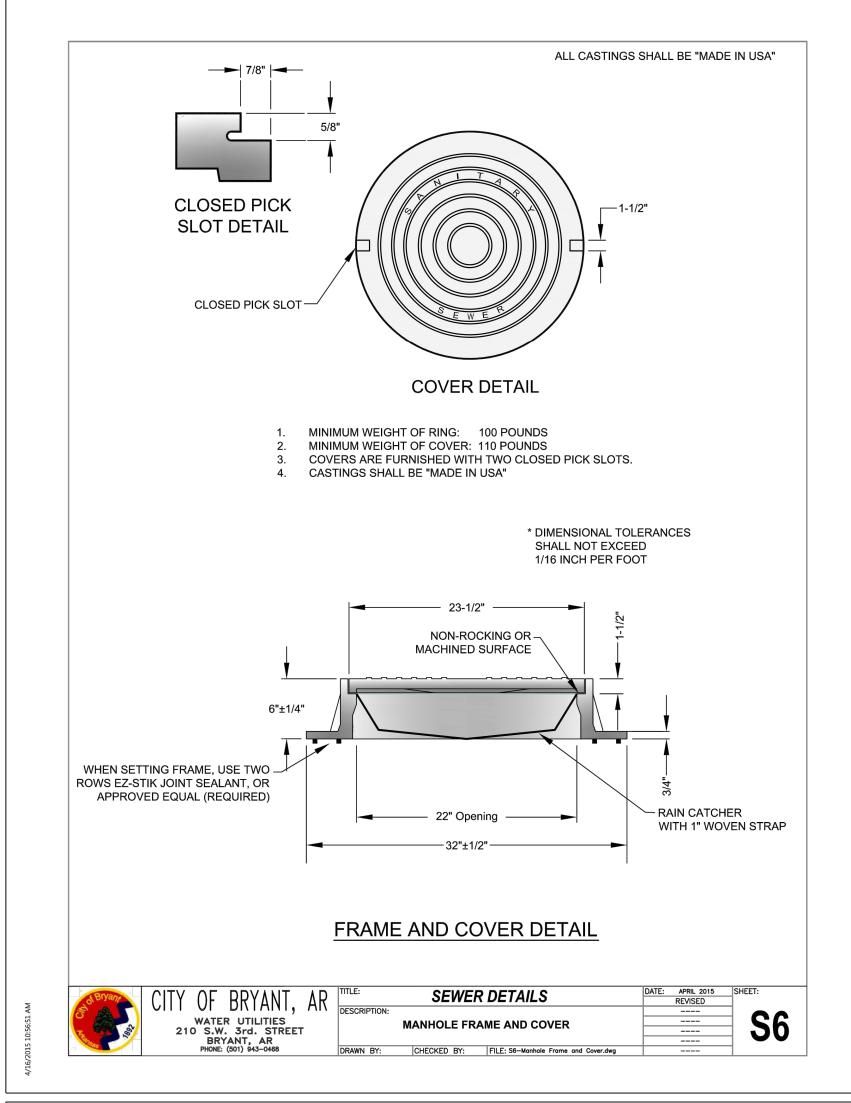

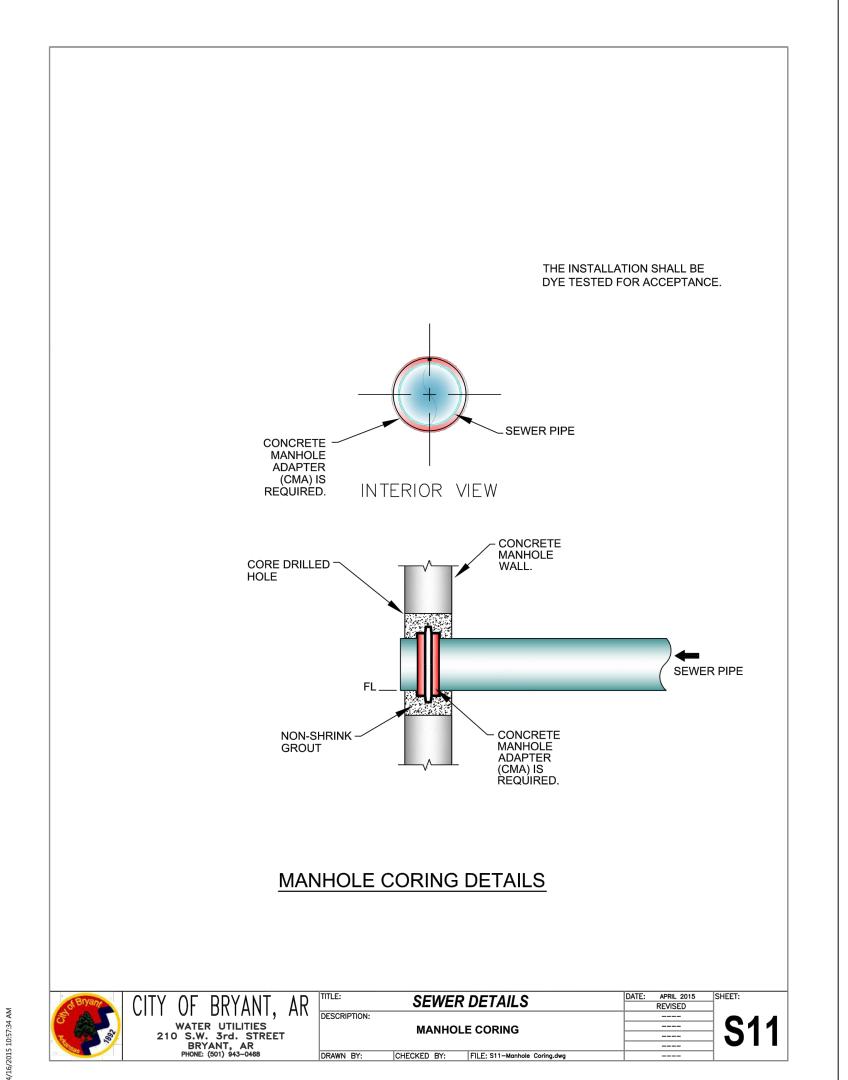

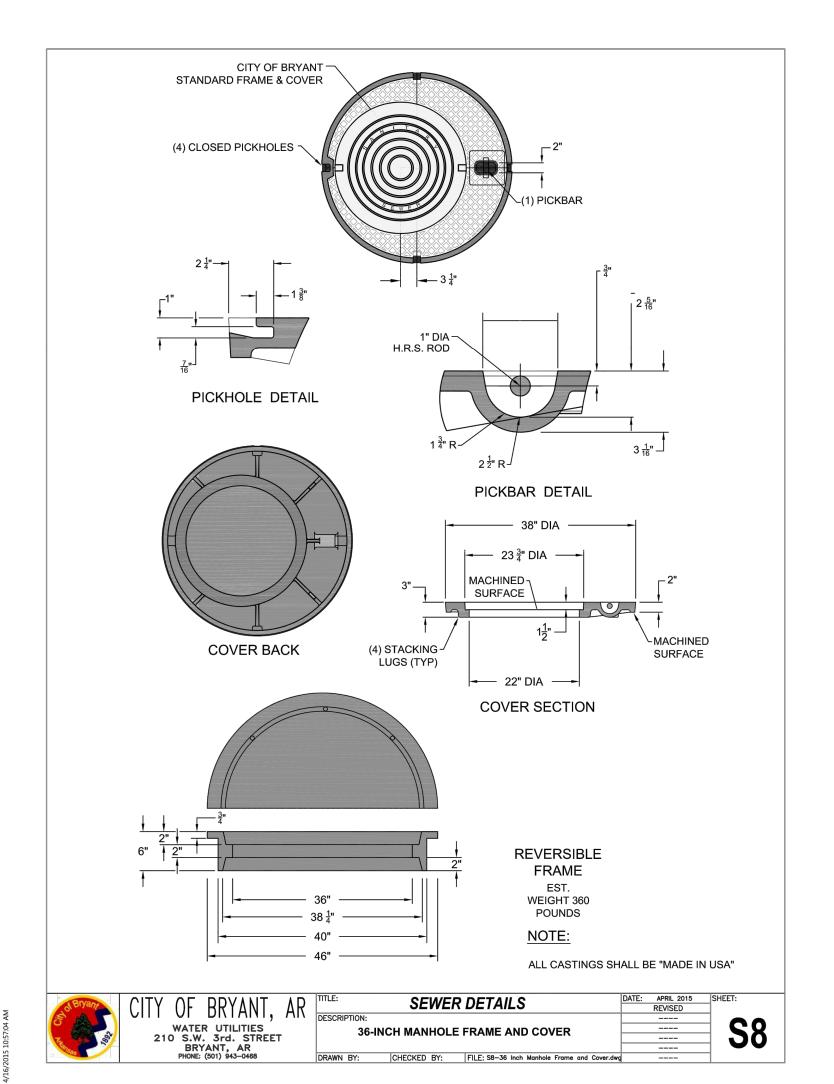

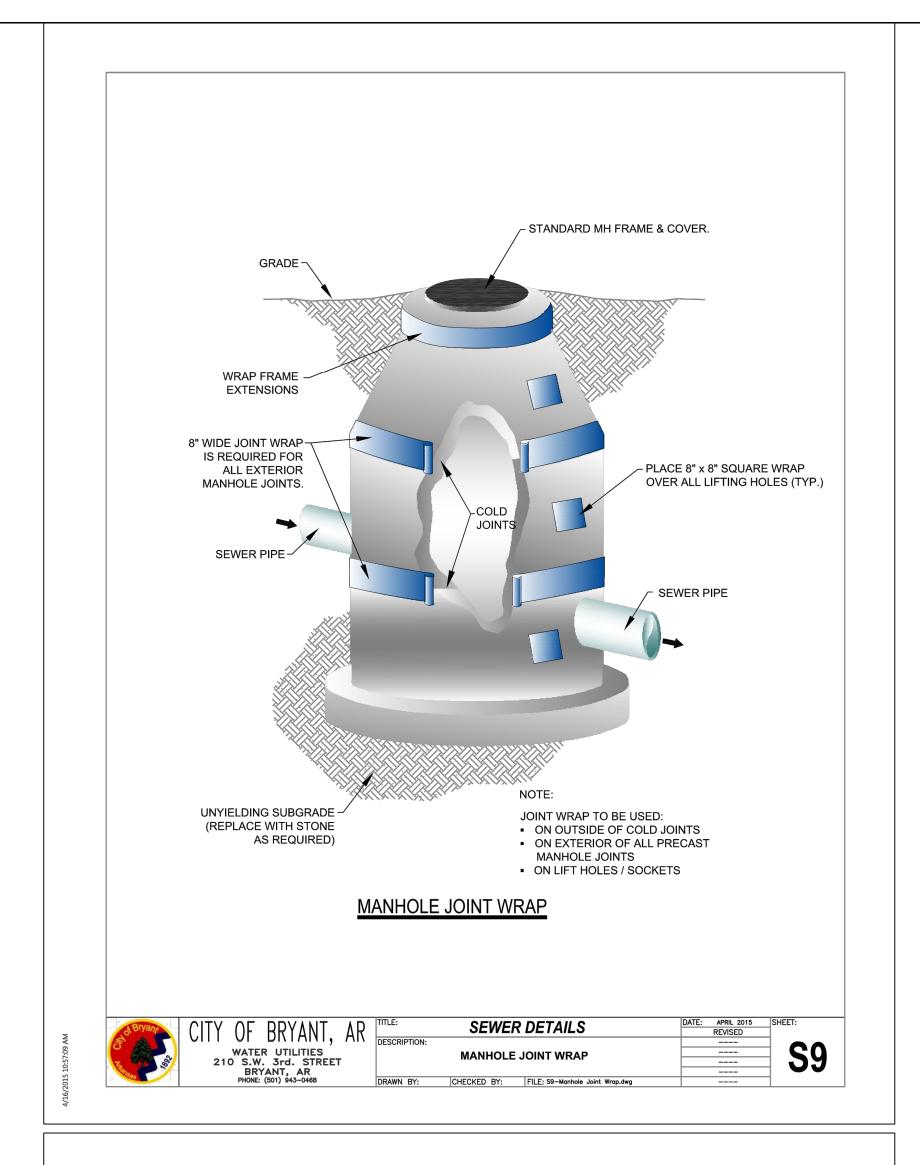



FOR USE AND BENEFIT OF:

WIGGINS FAMILY REAL ESTATE HOLDINGS, LLC

STARLIGHT VILLAGE SUBDIVISION SEWER DETAILS

A SUBDIVISION IN CITY OF BRYANT, SALINE COUNTY, ARKANSAS									
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OUTLET END VIEW

SPILLWAY END VIEW SCALE: 1" = 5'

SCALE: VARIES

RETENTION POND - OUTLET CROSS-SECTIONS & DETAILS

OUTLET PROFILE

SCALE: 1" = 10'

STARLIGHT VILLAGE SUBDIVISION DETENTION POND A SUBDIVISION IN CITY OF BRYANT, SALINE COUNTY, ARKANSAS C.A.D. BY: CHECKED BY:

**CONSULTING** PH. (501)315-2626 FAX (501) 315-0024 ENGINEERS - SURVEYORS

\*\*\* REGISTERED

**PROFESSIONAL** 

ENGINEER \*\*

0 + 00

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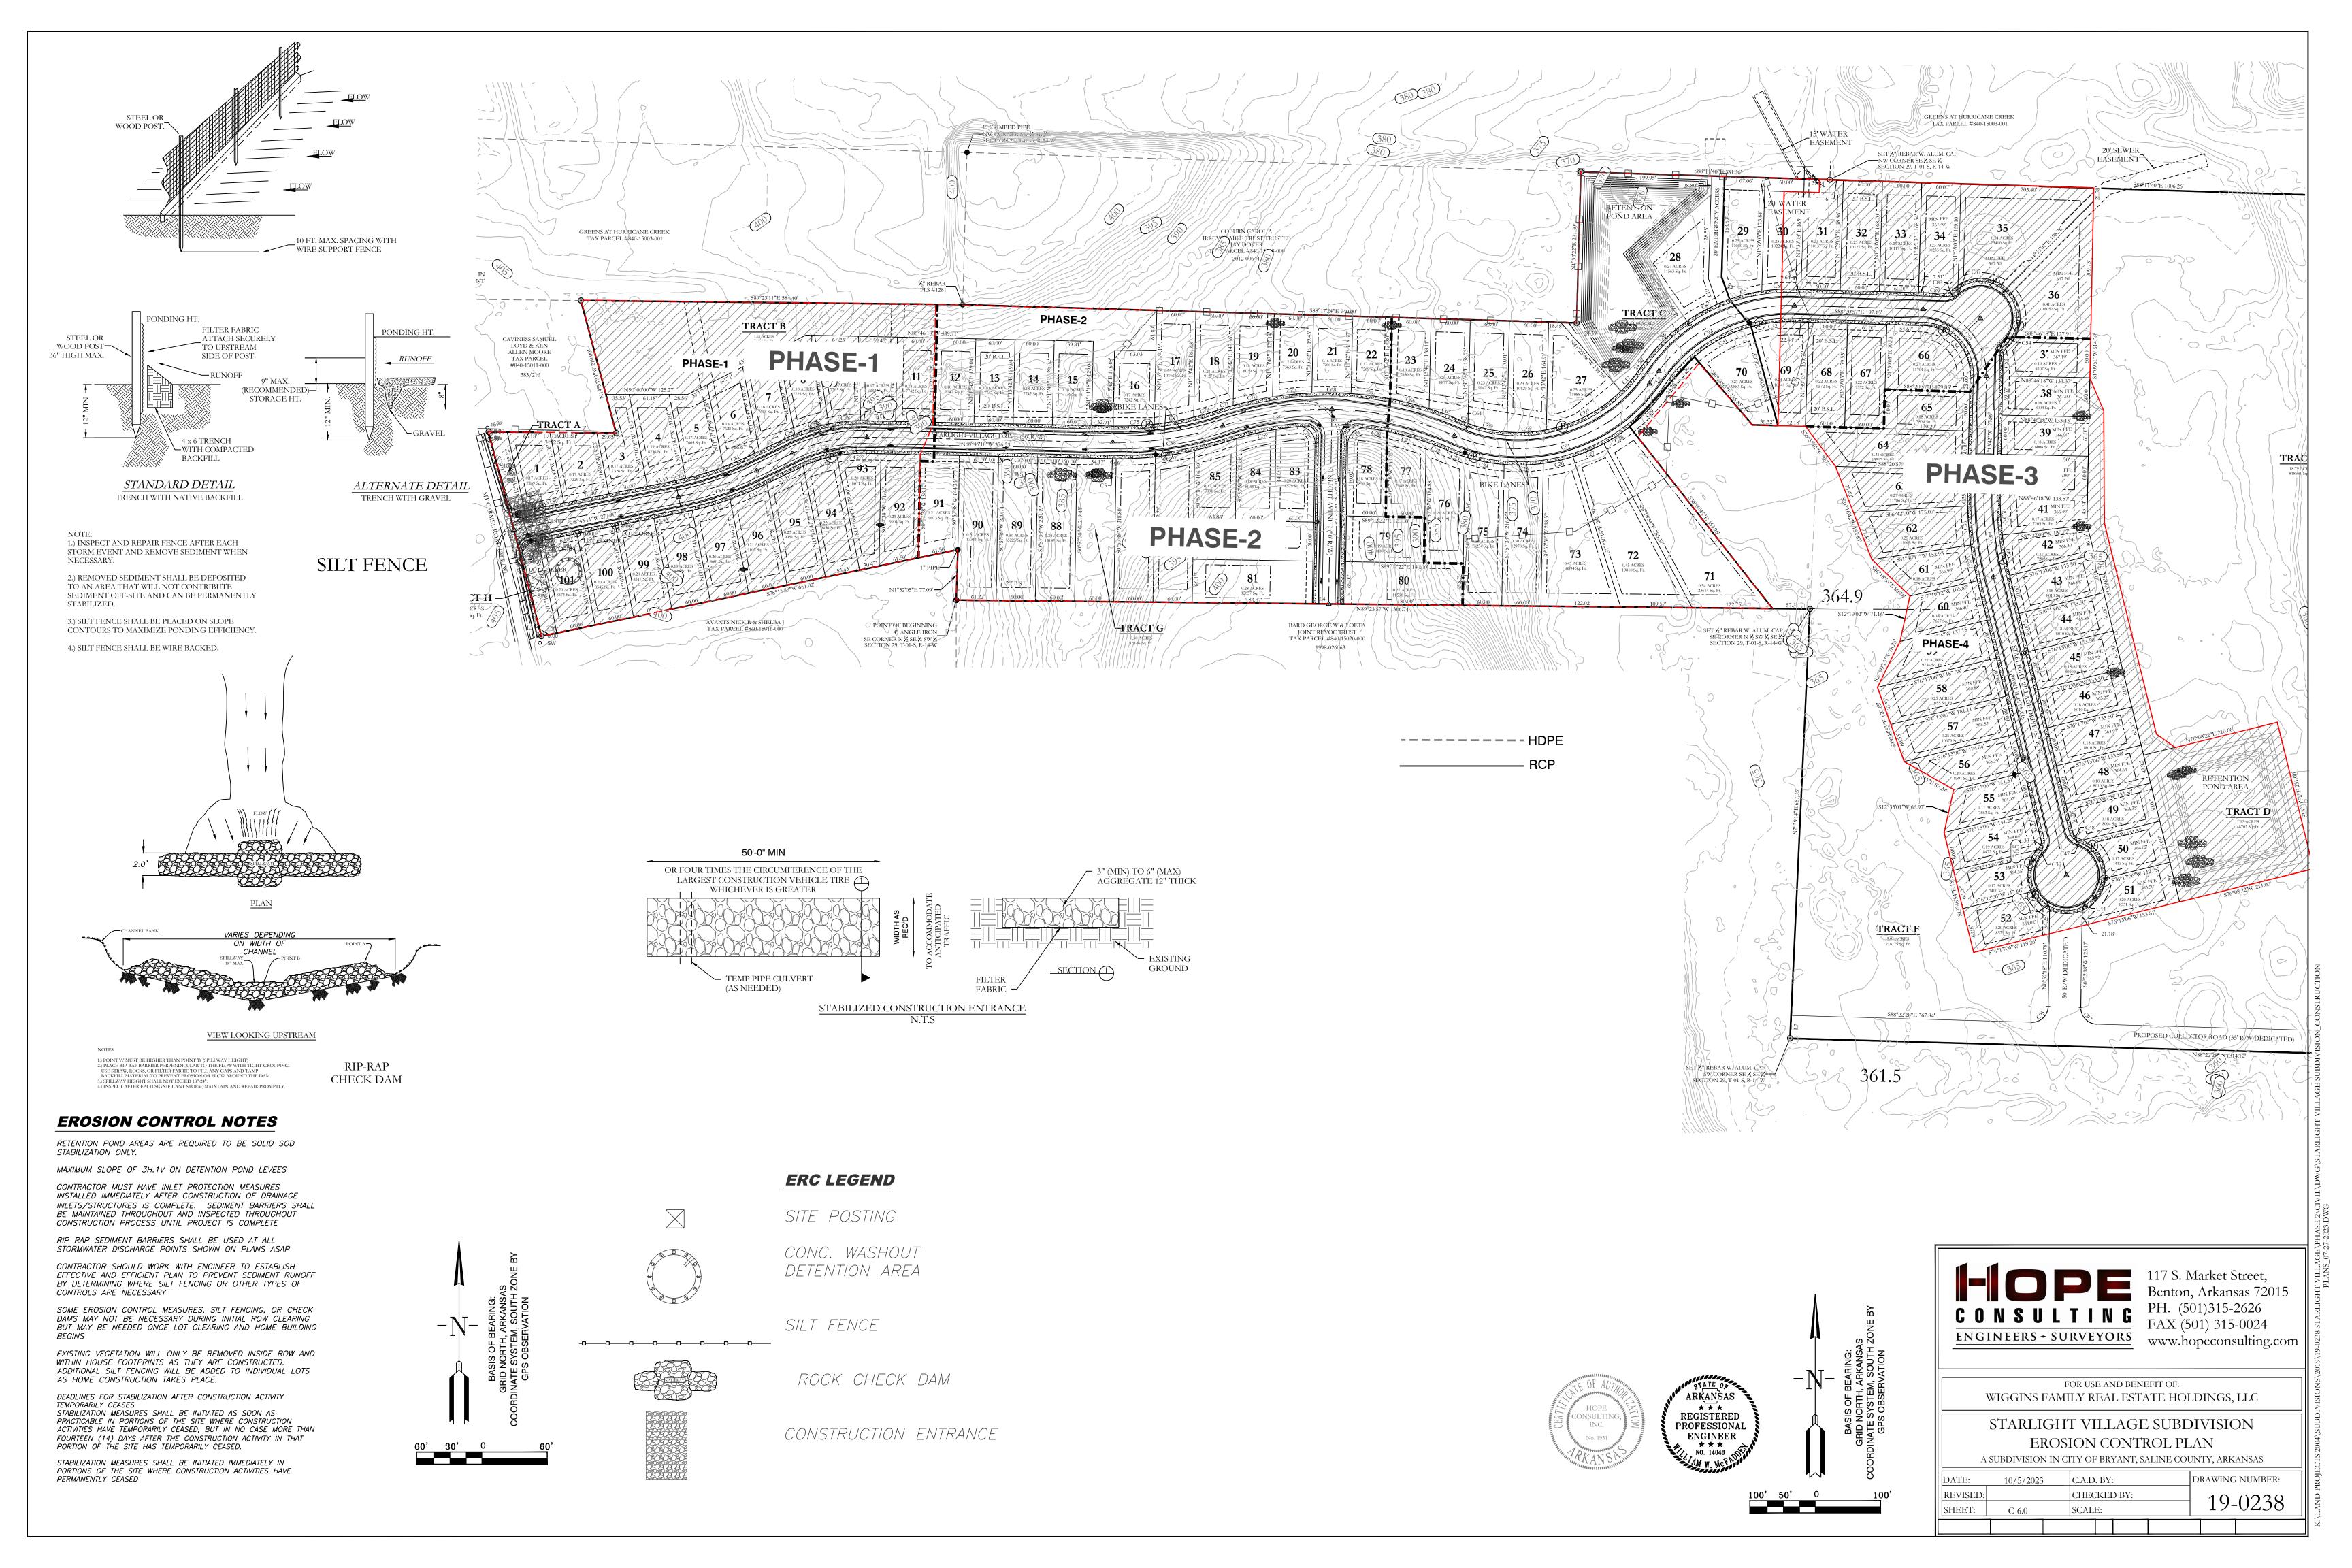
OF 36" RCP @ 1.08%

1<del>11 0</del>05

117 S. Market Street, Benton, Arkansas 72015 www.hopeconsulting.com

FOR USE AND BENEFIT OF: WIGGINS FAMILY REAL ESTATE HOLDINGS, LLC

DRAWING NUMBER: REVISED: 19-0238 SHEET: SCALE: C-5.0





3825 Mt Carmel Rd. Bryant, AR 72022

#### **GarNat Engineering, LLC**

P.O. Box 116 Benton, AR 72018

October 10, 2023

Mr. Truett Smith
Bryant Planning Coordinator/Planning Commission Secretary
210 SW 3<sup>rd</sup> Street
Bryant, AR 72022

Re: Final Plat – Creekside Addition, Phase 2

Dear Mr. Smith:

Please allow this letter and following list of enclosures to serve as my application for approval of the referenced final plat. It is my desire that this matter be included on the agenda for your November 13, 2023 City of Bryant Planning Commission meeting. The developer for the project is Diamond Development II, 1599 Lawson Oaks Drive, Little Rock, Arkansas 72210, jbhastingsjr@aol.com, (501) 690-6601.

#### List of Enclosures

- Bryant Subdivision Checklist
- Certification letter signed by developer and professional engineer
- Final Plat review fees of \$46.00

If you have questions or need any additional information, please do not hesitate to contact me.

Sincerely,

GarNat Engineering, LLC

Vernon J. Williams, P.E., President



#### **GarNat Engineering, LLC**

#### **Designing our client's success**

P.O. Box 116 Benton, Arkansas 72018 3825 Mt Carmel Road Bryant, Arkansas 72022 PH: (501) 408-4650

FX: (888) 900-3068 garnatengineering@gmail.com

July 10, 2018

Truett Smith
Planning & Community Development
210 S.W. 3rd Street
Bryant, AR 72022

Re:

Final Plat Certification

Creekside Addition-Phase 2

Dear Mr. Smith:

Please allow this letter to serve as the certification for the referenced project required by Paragraph 15.12.05.a of the City of Bryant Subdivision Regulations. To that end, we certify that all improvements and installation to the subdivision required for its approval under the terms of the City of Bryant Subdivision Rules and Regulations have been made, added, or installed. Furthermore, these improvements were constructed in accordance with the approved plans and specifications.

If you have questions or need any additional information, please do not hesitate to contact us.


Sincerely,

GarNat Engineering, LLC

Vernon J. Williams, P.E., President

Diamond Development II

Jim Hastings

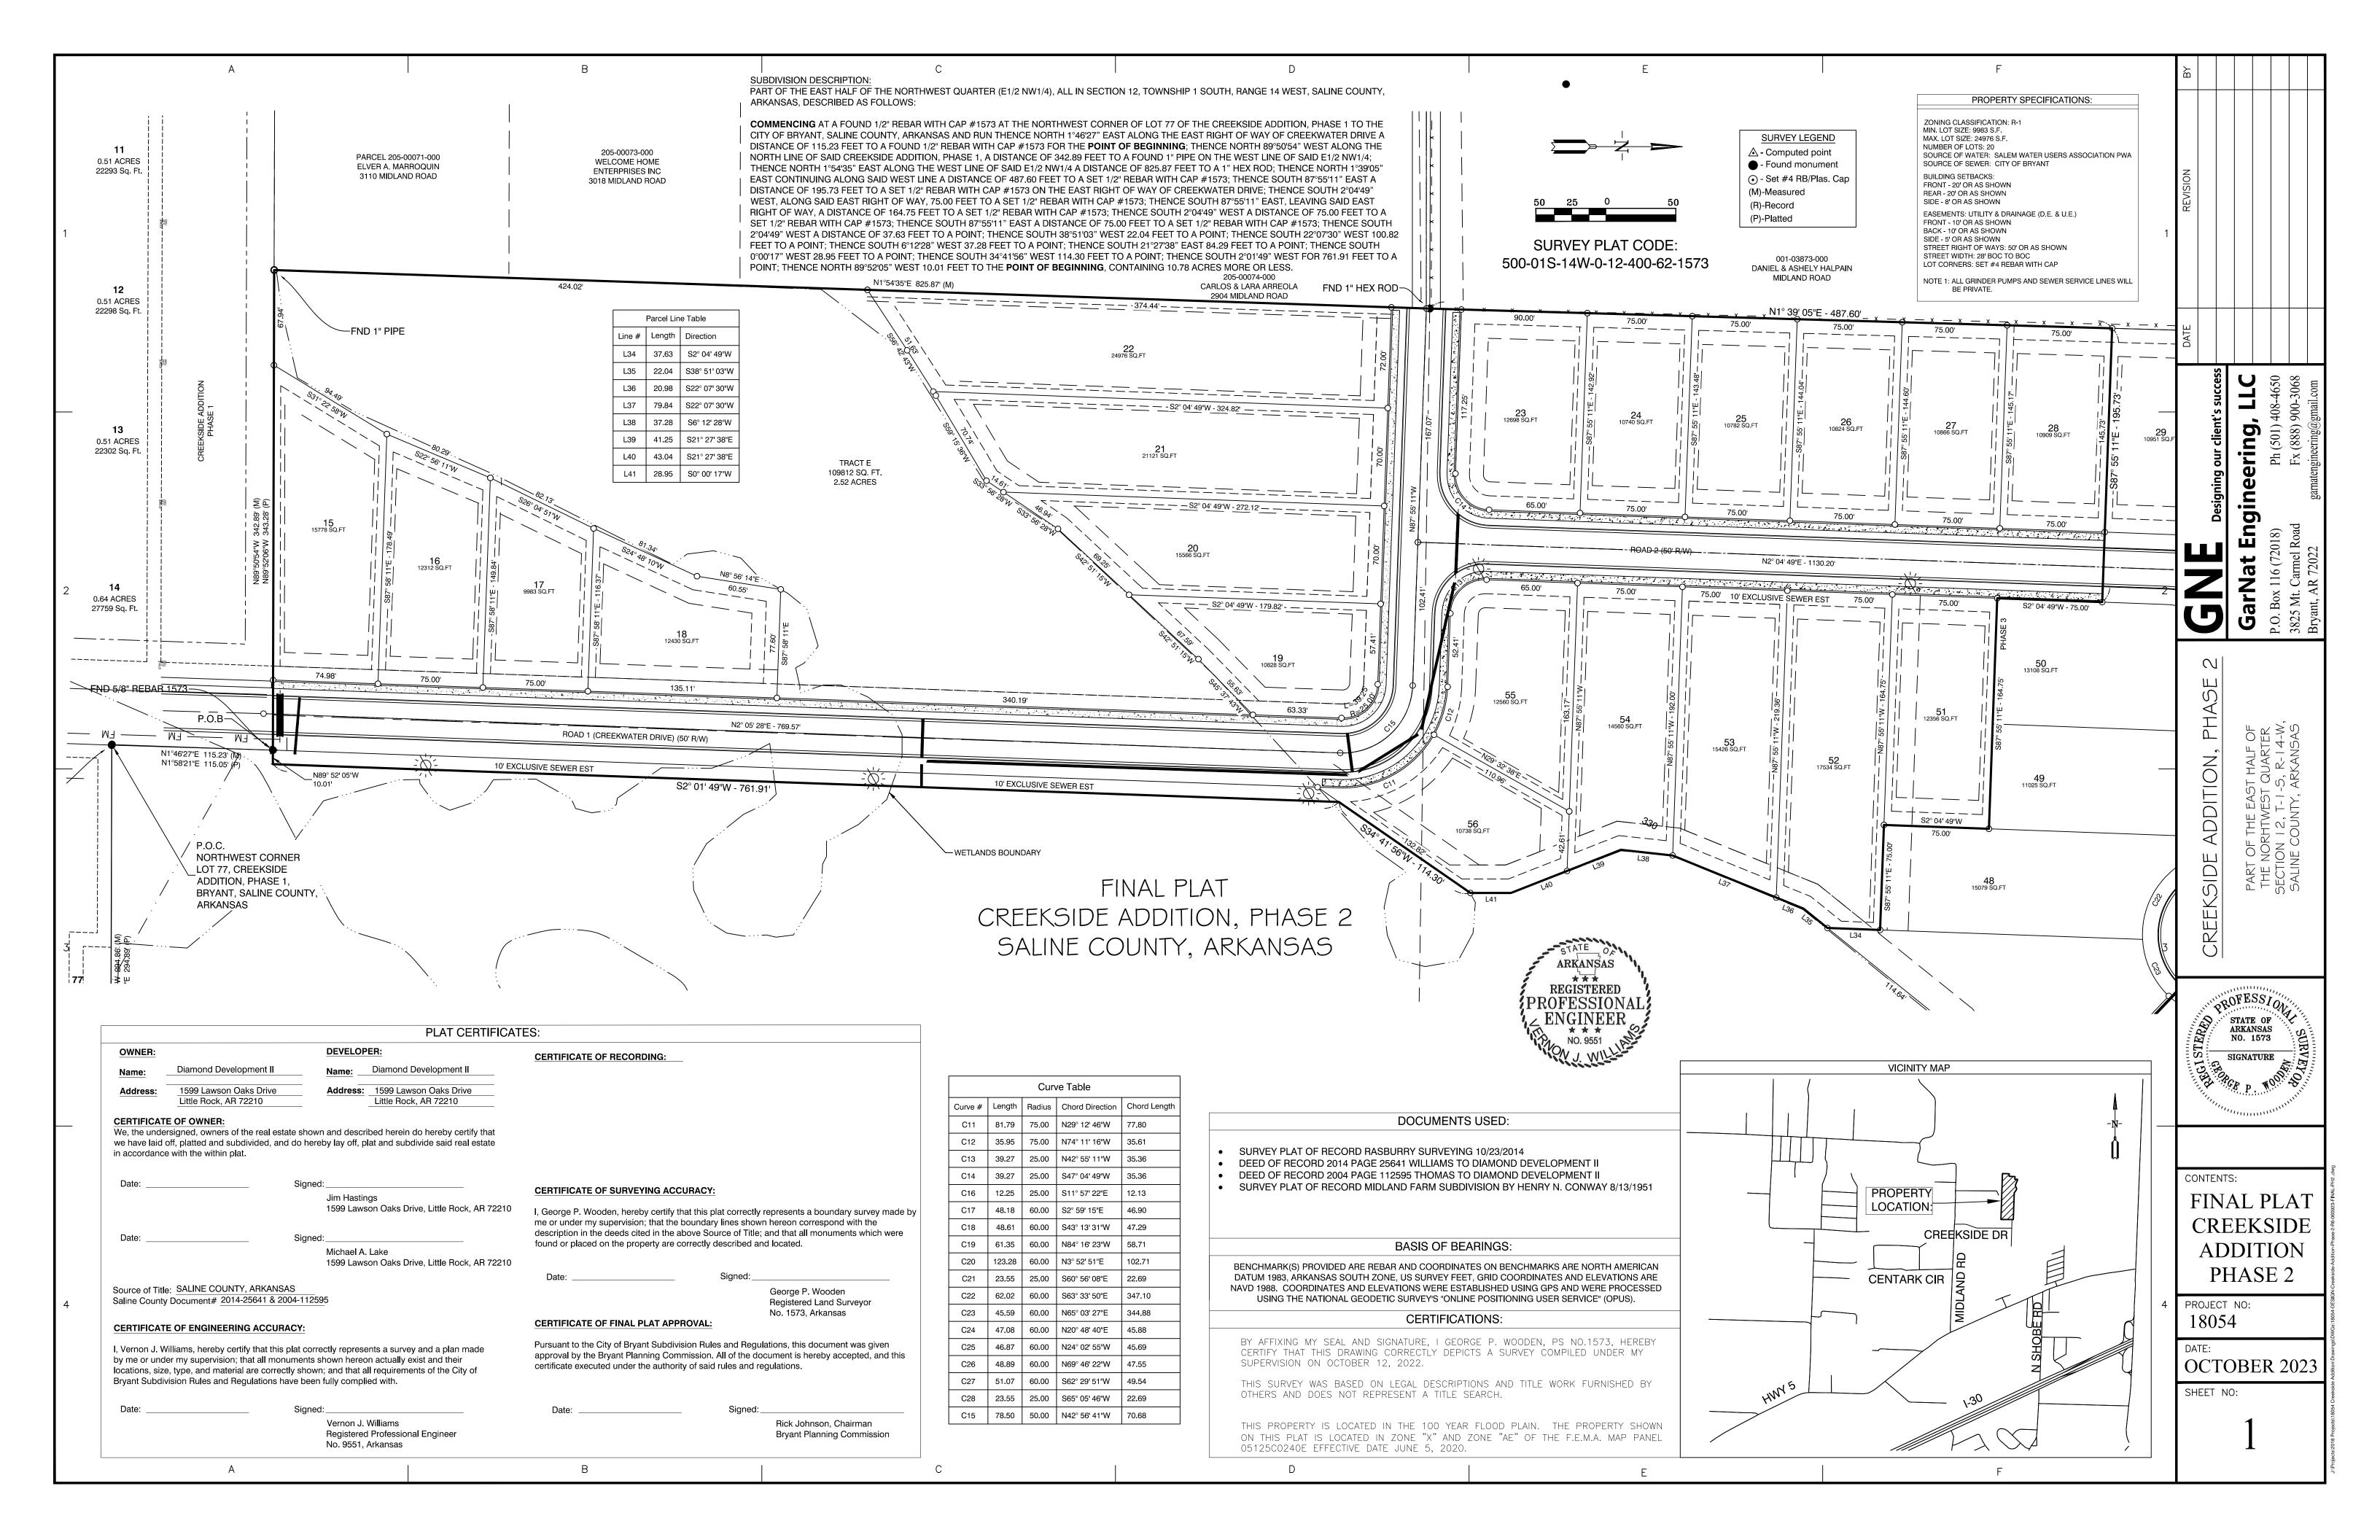


# CREEKSIDE ADDITION PHASE 2 BRYANT, ARKANSAS

# Prepared by: GarNat Engineering, LLC

Designing our client's success www.garnatengineering.com

P.O. Box 116
Benton, AR 72018
Ph (501) 408-4650

3825 Mt Carmel Road Bryant, AR 72022 Fx (888) 900-3068

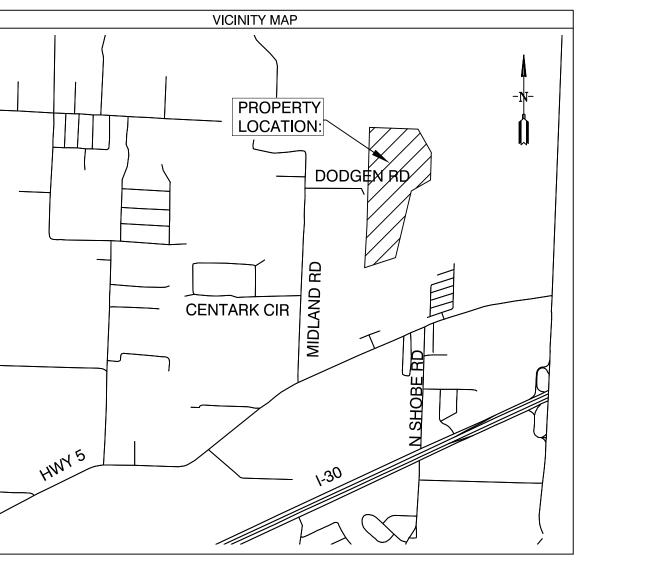






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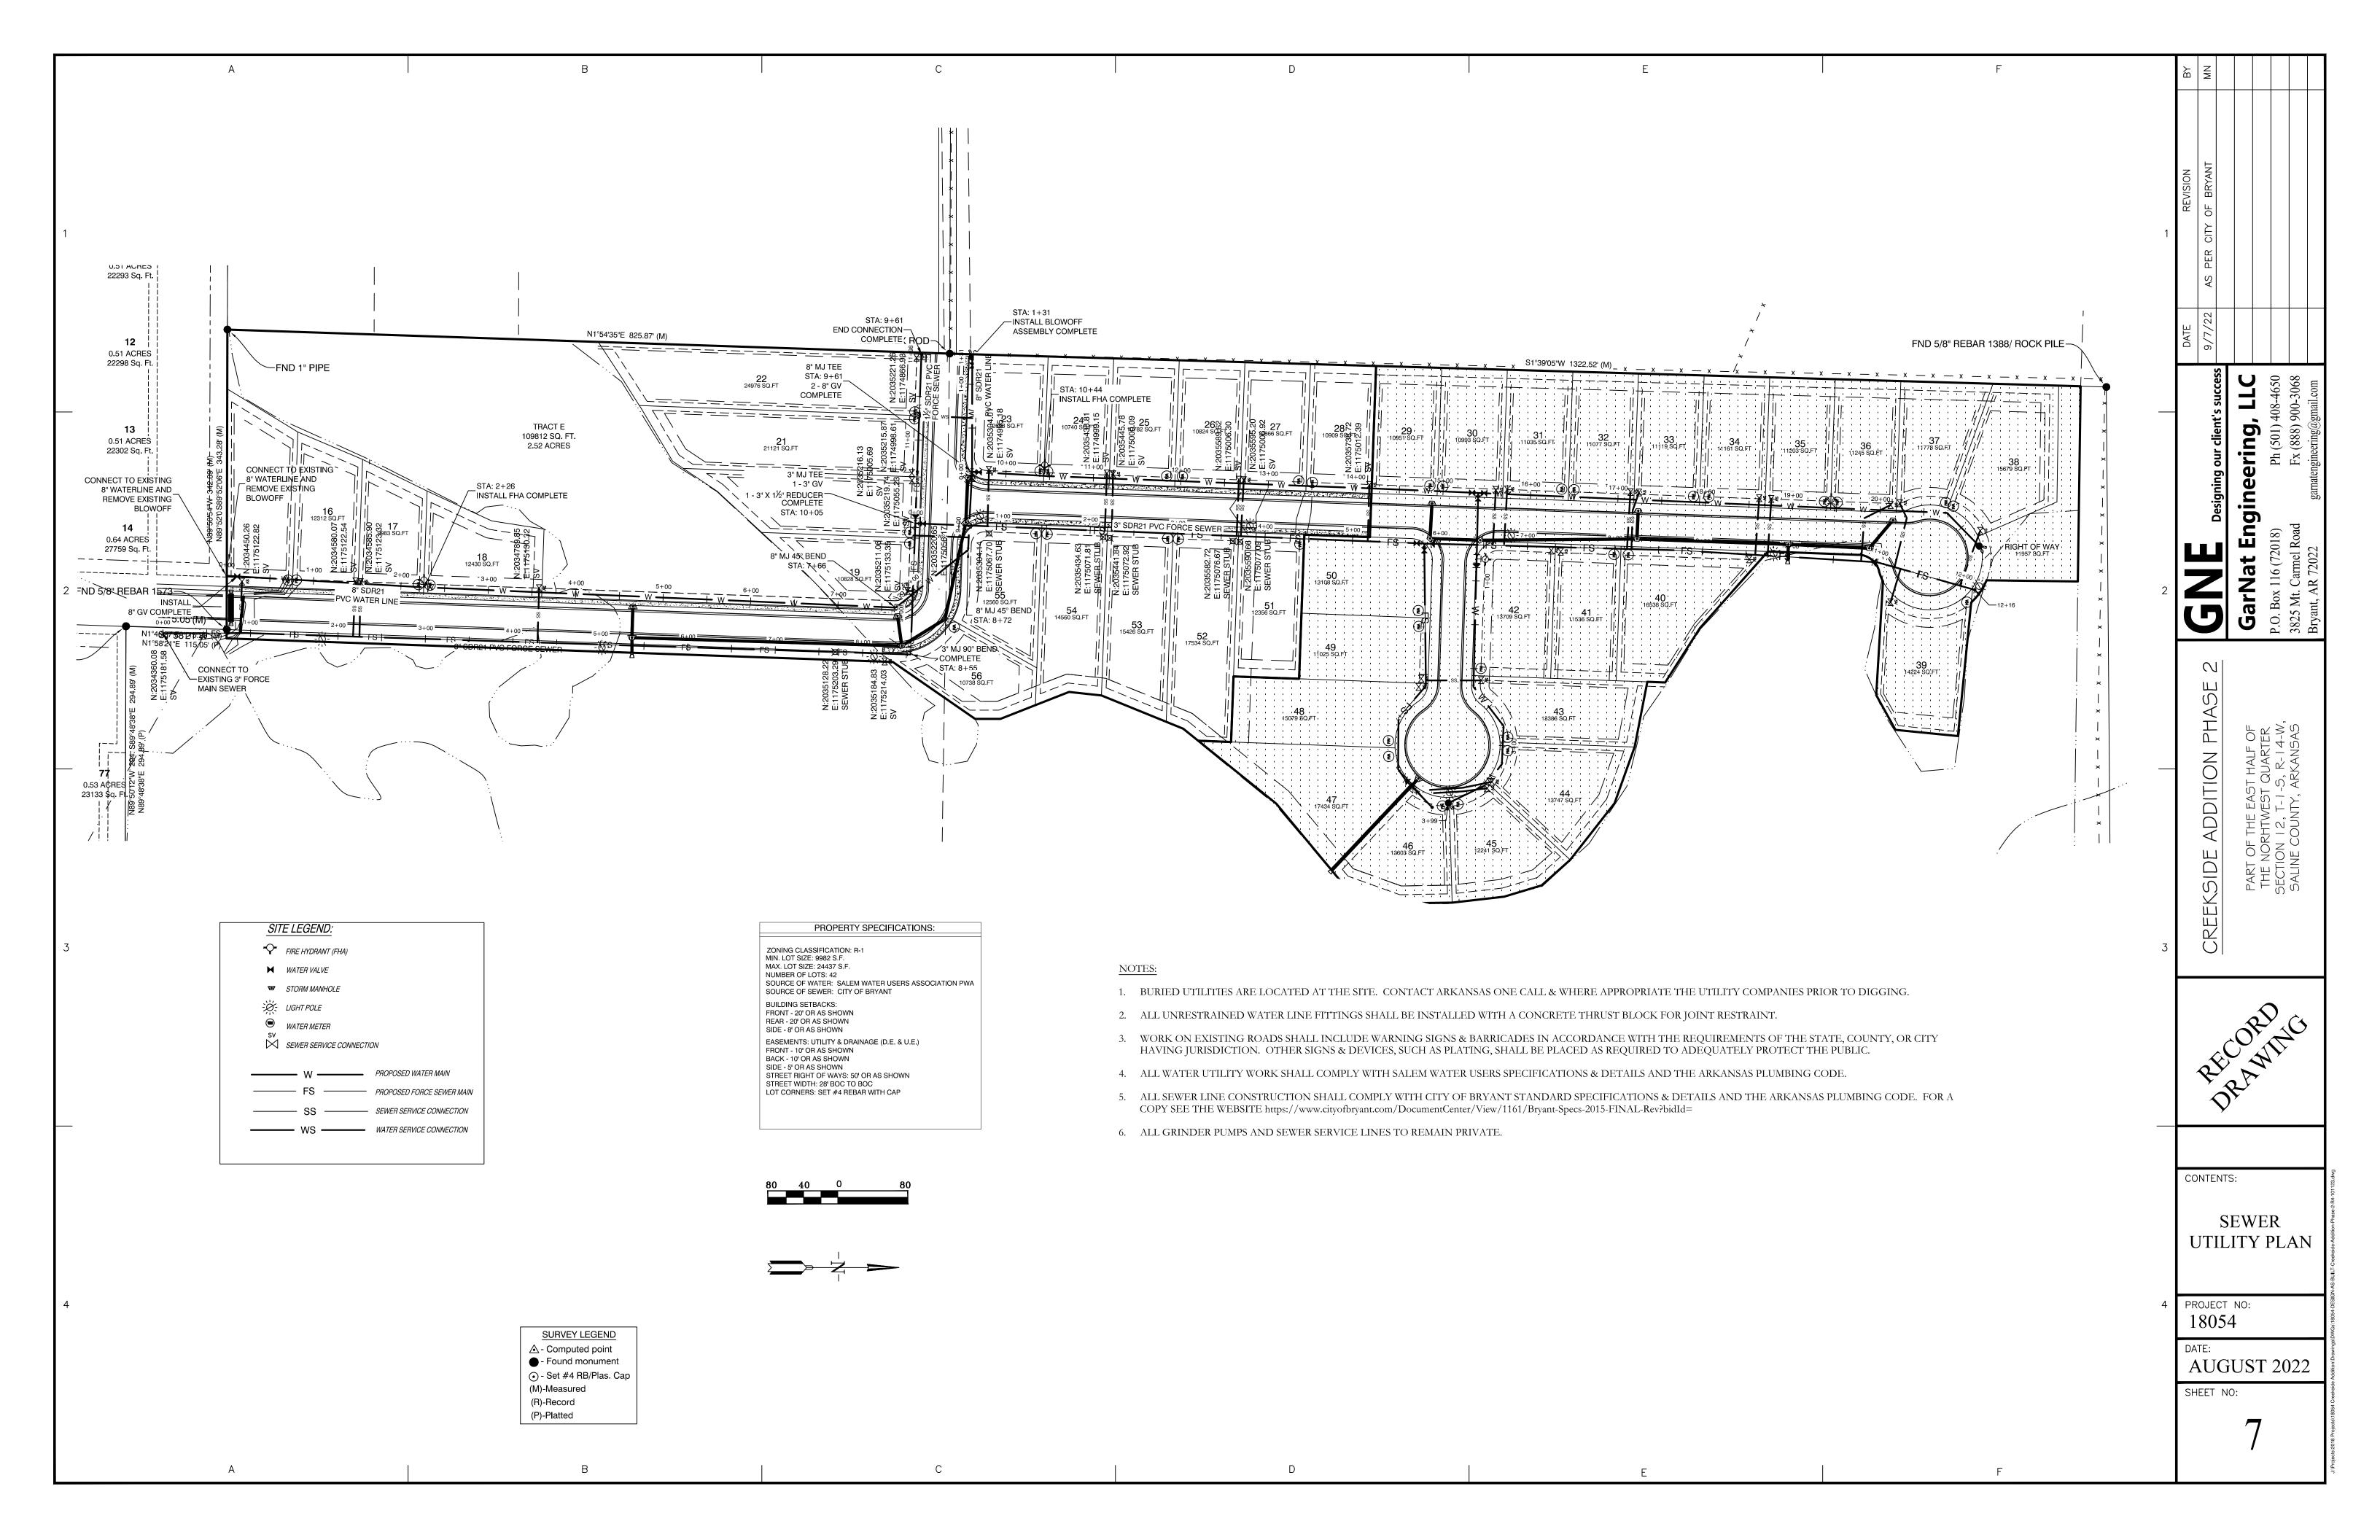
- 1 FINAL PLAT PHASE 2
- 5 WATER UTILITY PLAN
- 6 PLAN & PROFILE CREEKWATER DRIVE
- 7 SEWER UTILITY PLAN





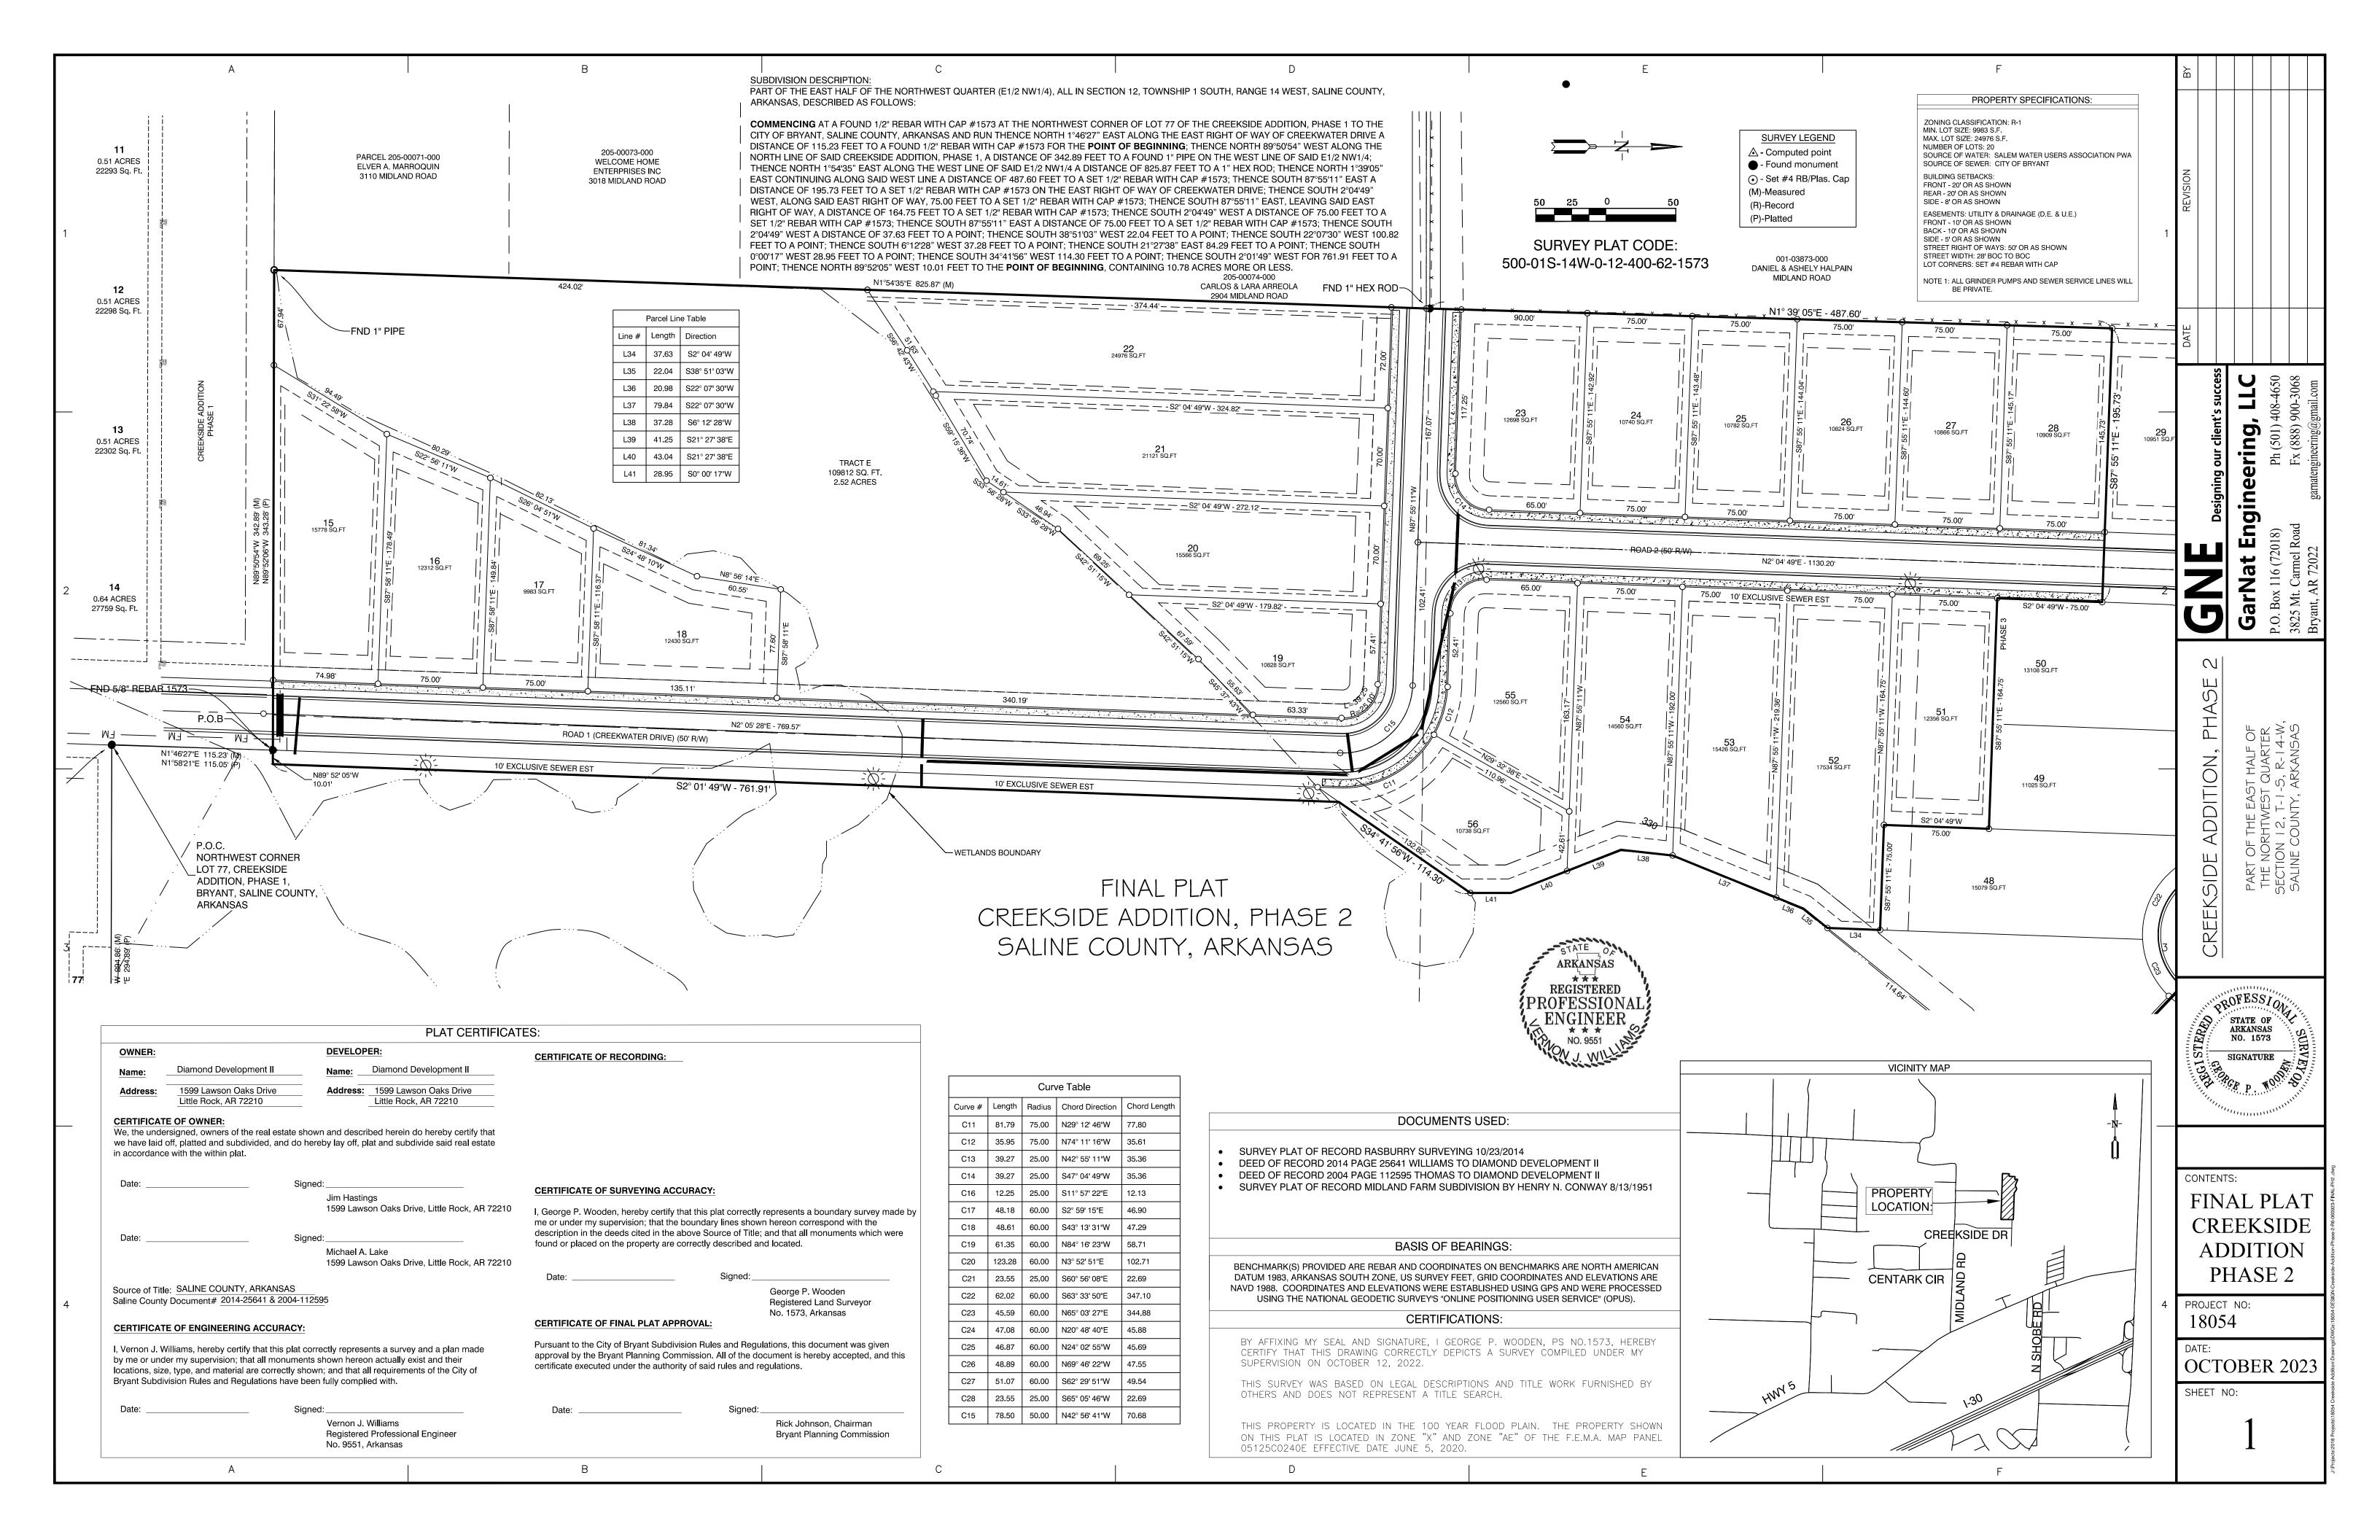

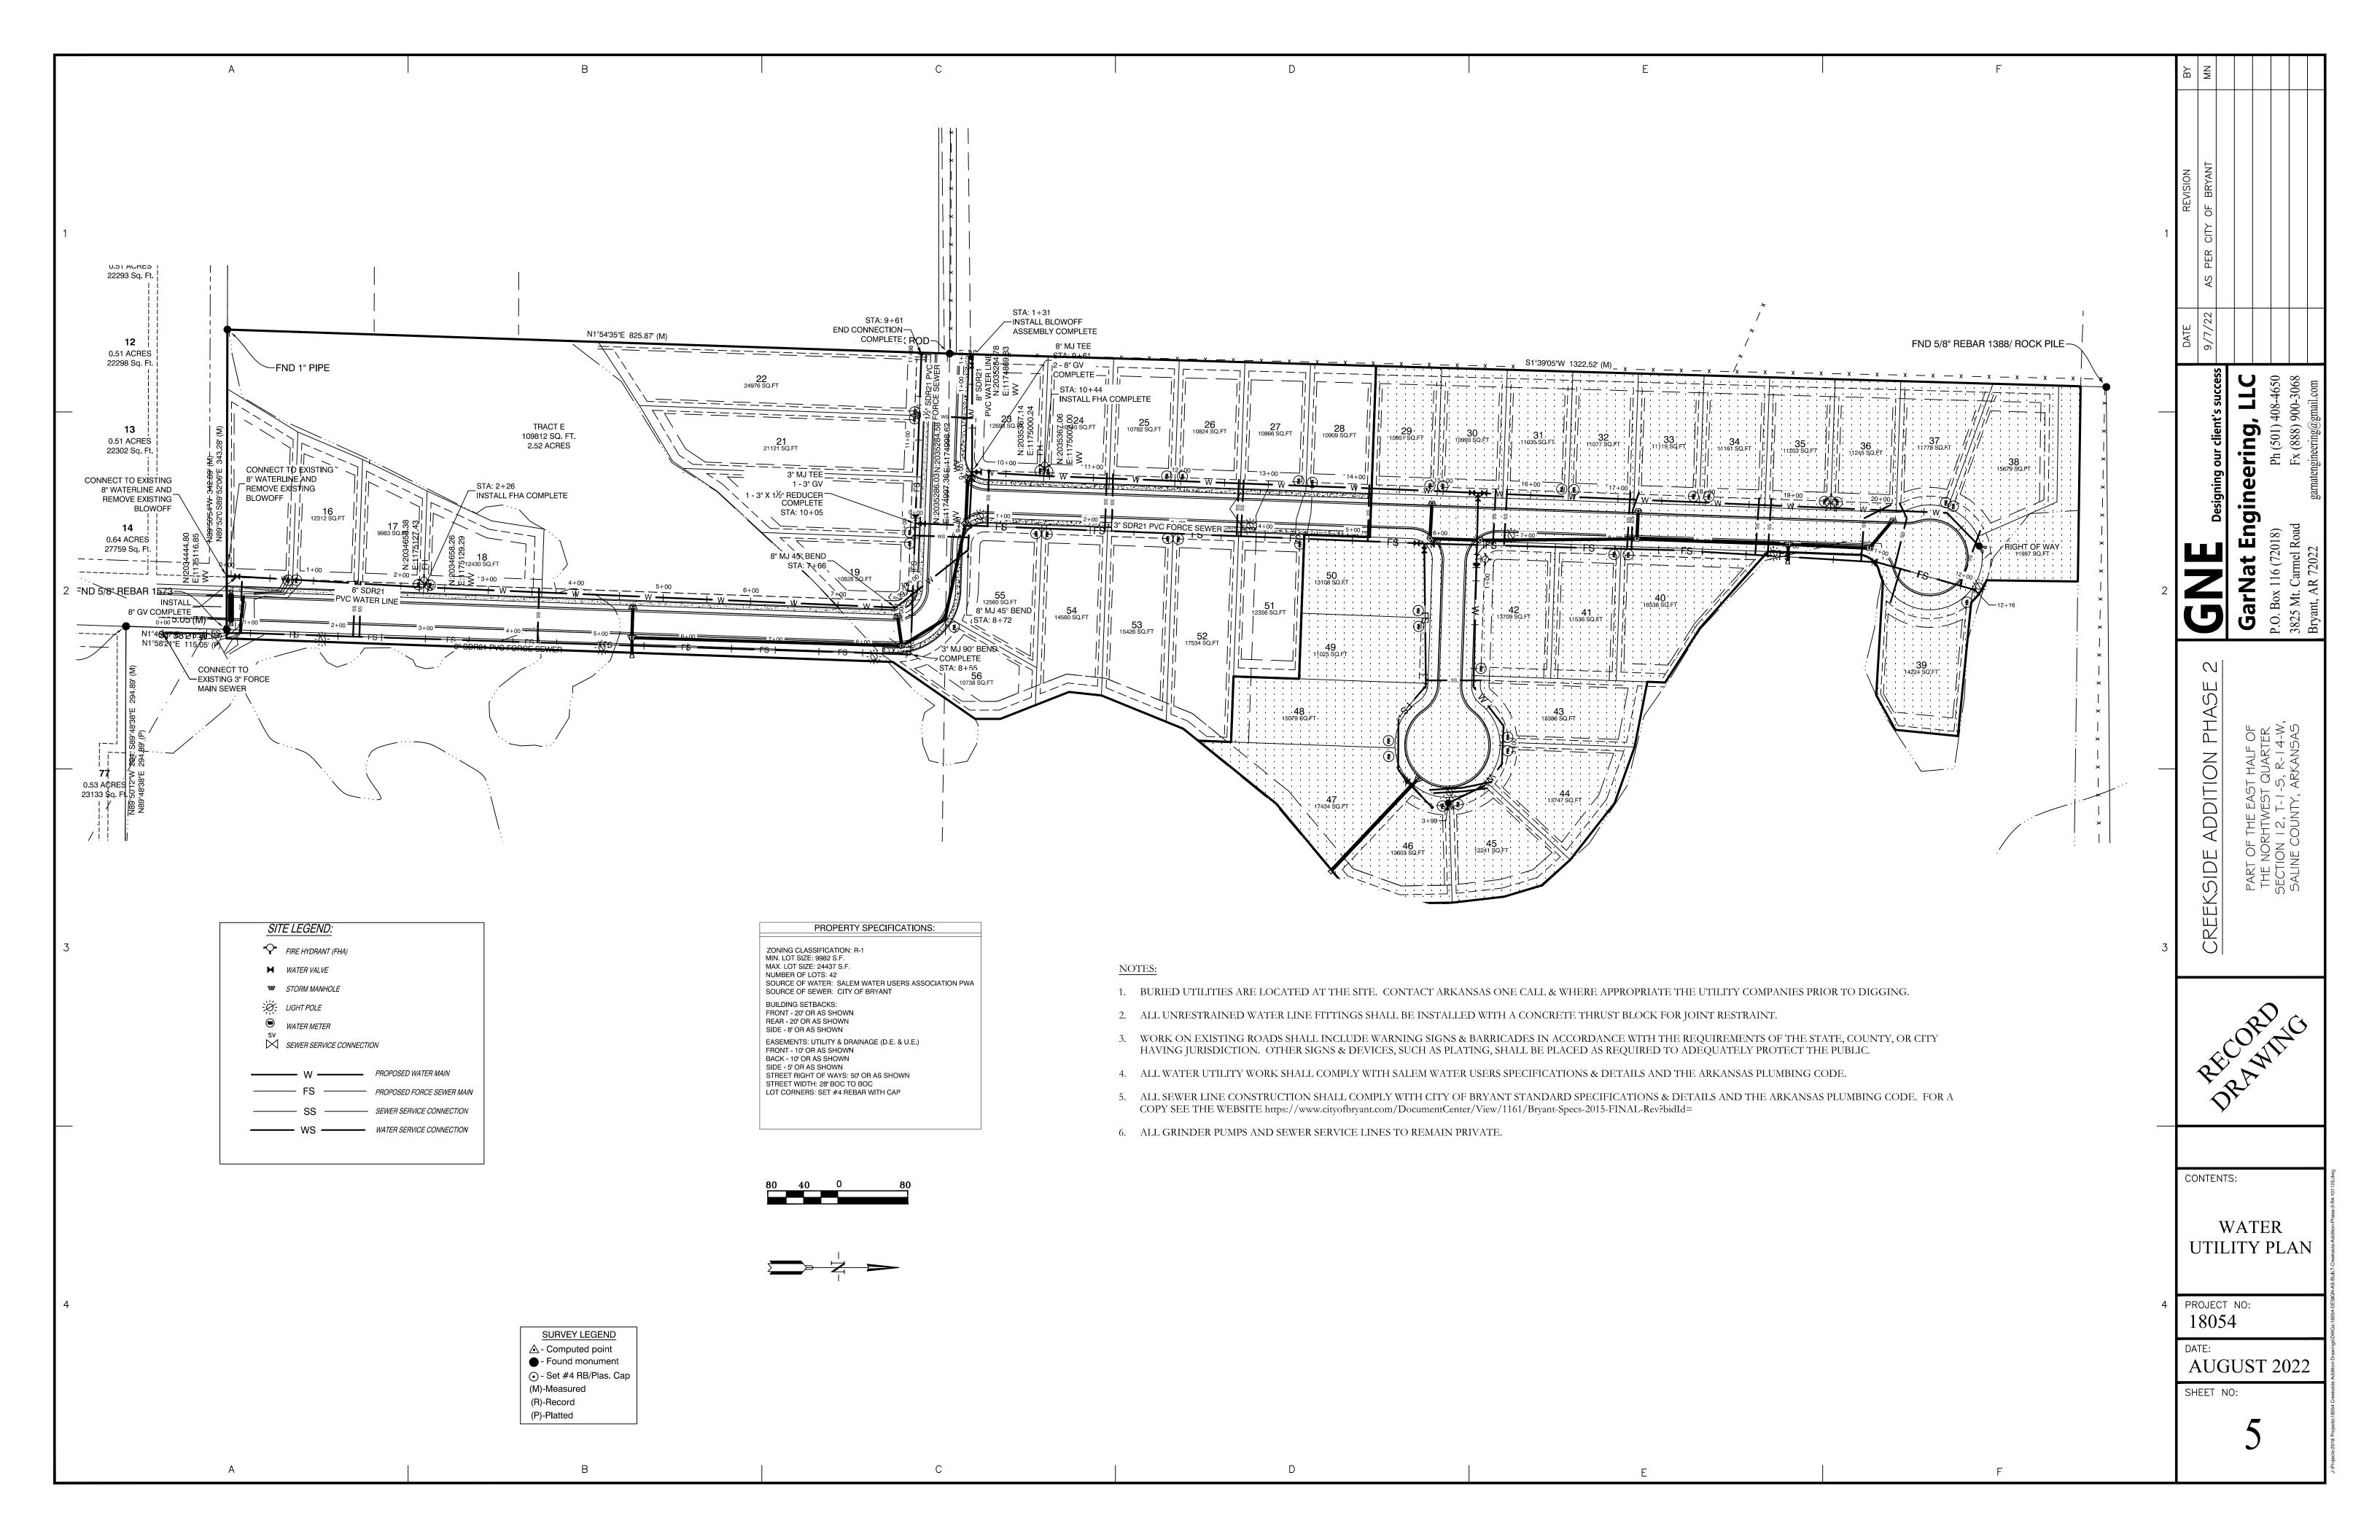

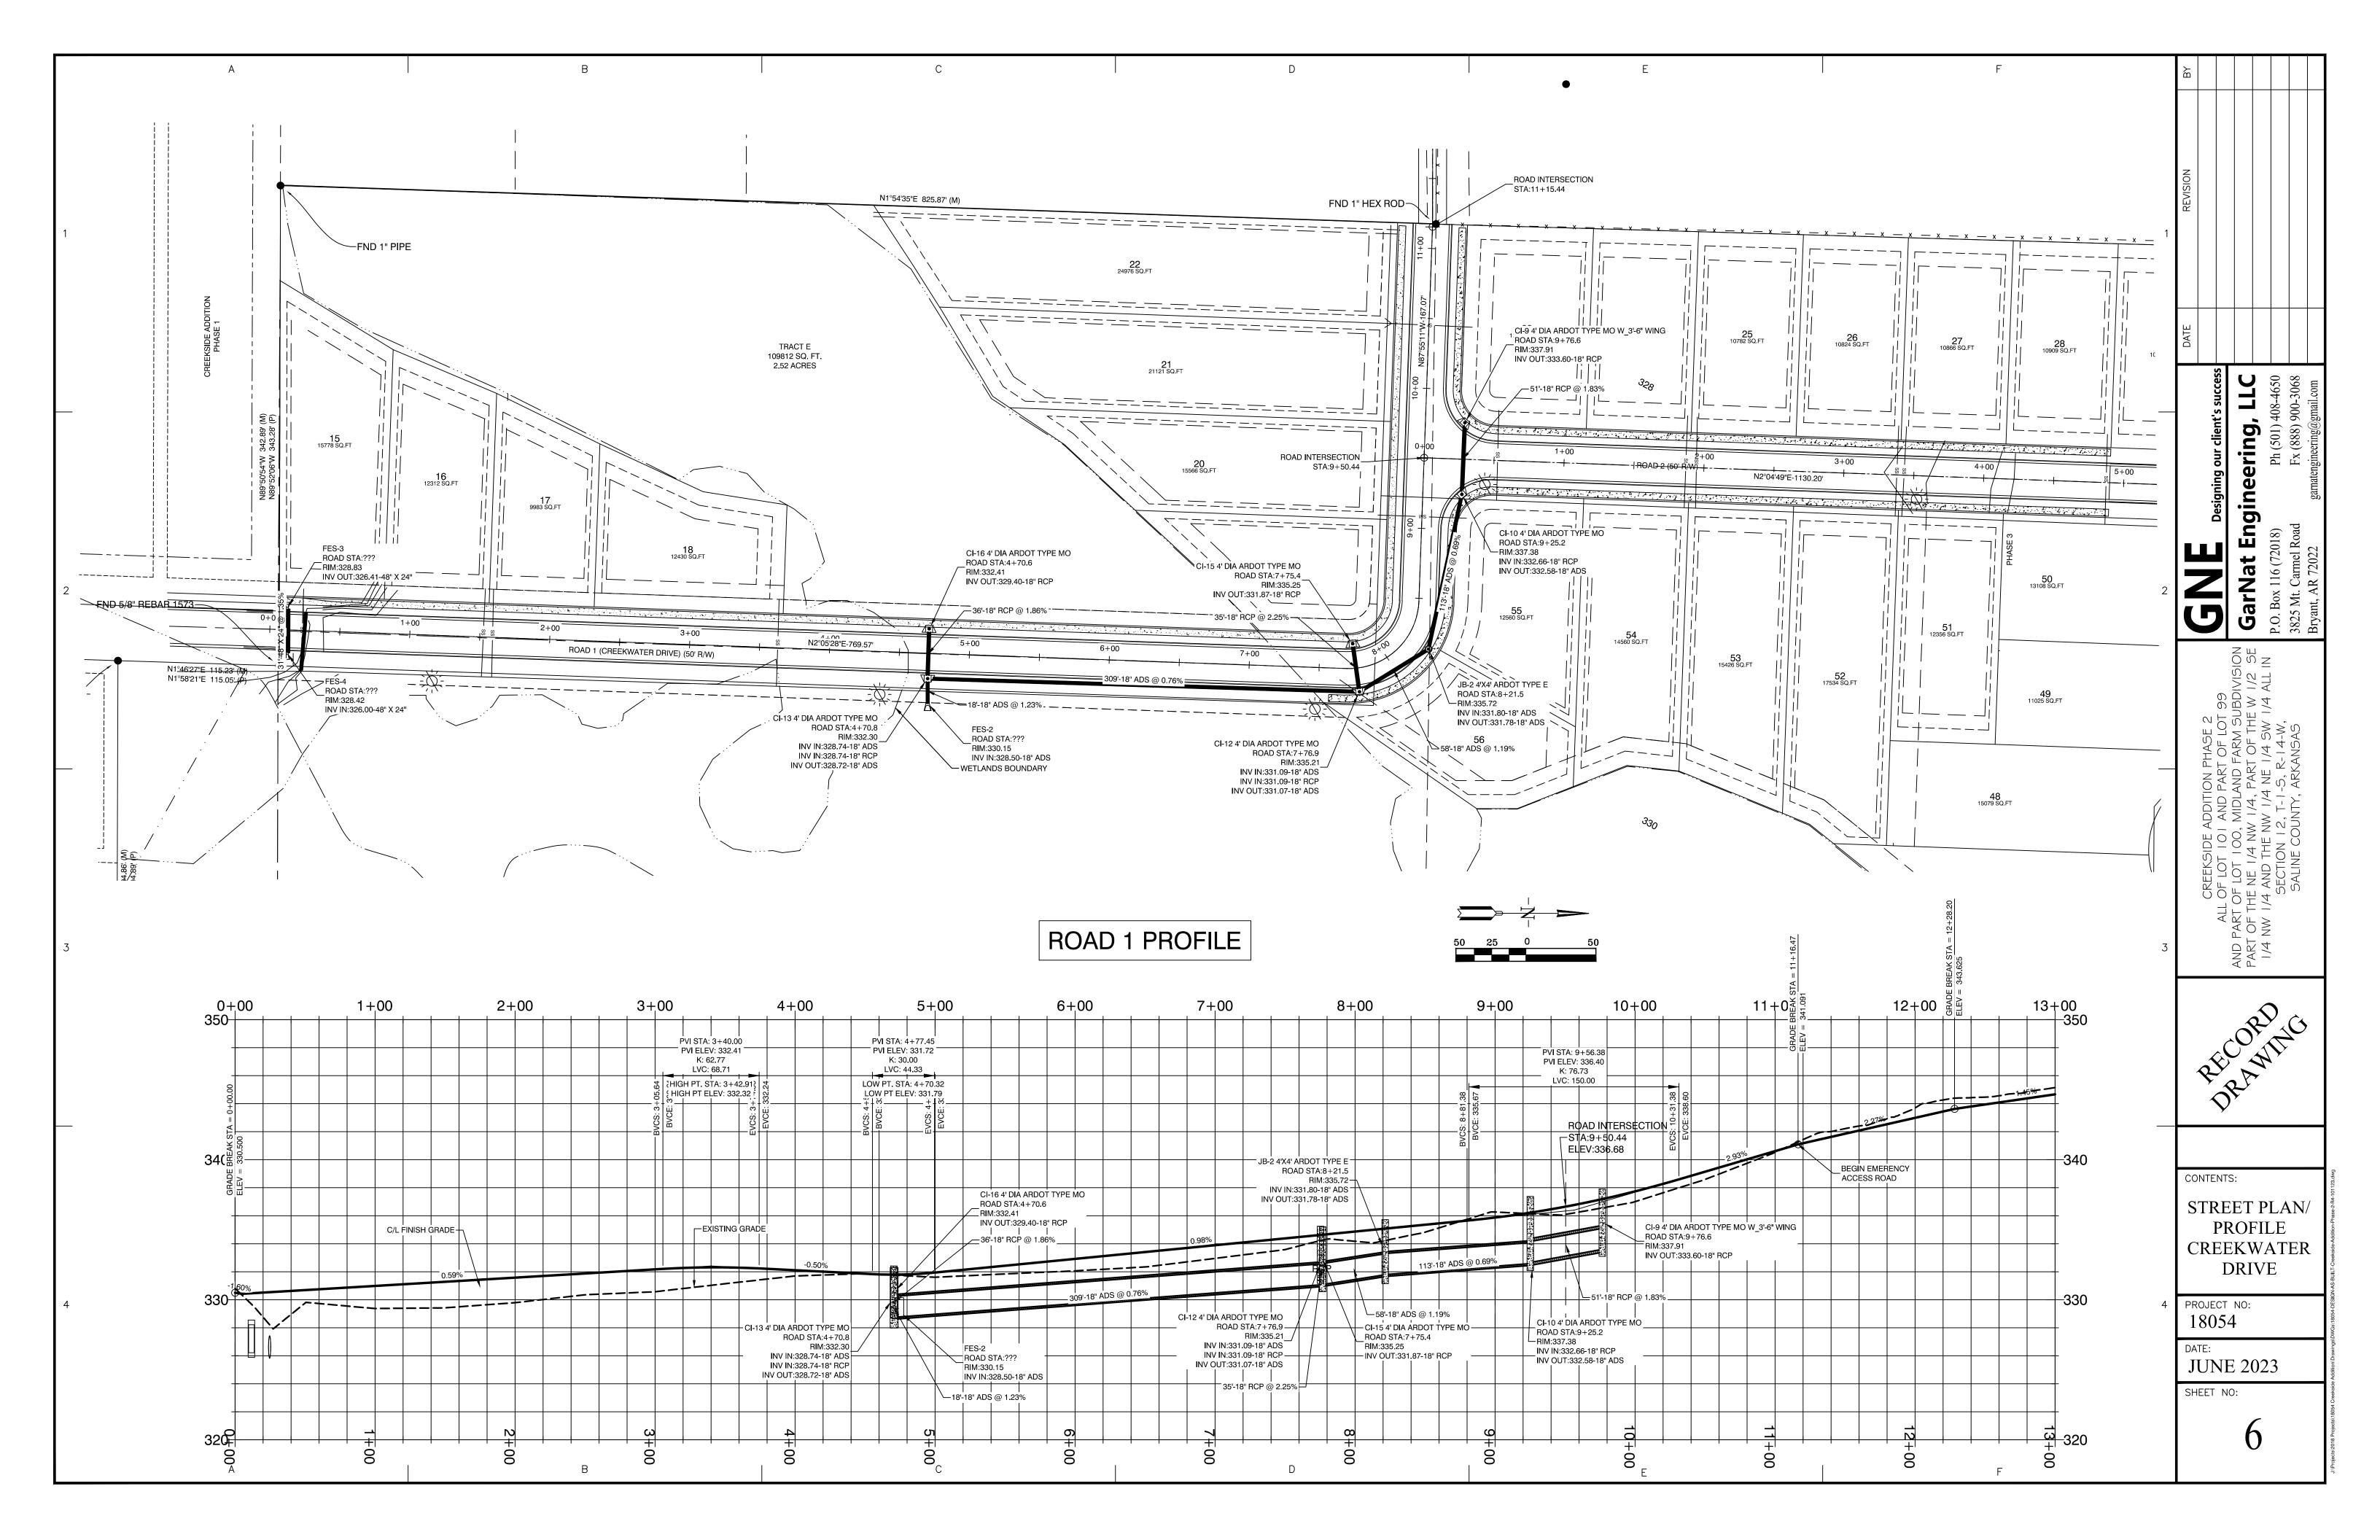



**BILL OF ASSURANCE** 

#### 2018-016747

I certify this instrument was filed on: 08/30/2018 10:49:30 AM Myka Bono Sample Saline County Circuit Clerk

Pages: 8

#### **CREEKSIDE ADDITION - PHASE I** LOTS 1 THROUGH 14 AND LOTS 77 THROUGH 99, SCHANE

#### CITY OF BRYANT, ARKANSAS

AND TRACT A

DIAMOND DEVELOPMENT II TO THE PUBLIC

#### KNOW ALL MEN BY THESE PRESENTS:

THAT Diamond Development II, its successor and assigns, hereinafter "Developer", is owner/developer of the following property situated in Saline County, Arkansas:

ALL OF LOT 101 AND PART OF LOT 99 AND PART OF LOT 100, MIDLAND FARM SUBDIVISION, SALINE COUNTY, ARKANSAS, AND PART OF THE NORTHEAST QUARTER OF THE NORTHWEST QUARTER AND PART OF THE WEST HALF OF THE SOUTHEAST QUARTER OF THE NORTHWEST QUARTER AND THE NORTHWEST QUARTER OF THE NORTHEAST QUARTER OF THE SOUTHWEST QUARTER ALL IN SECTION 12, TOWNSHIP 1 SOUTH, RANGE 14 WEST, SALINE COUNTY, ARKANSAS, DESCRIBED AS FOLLOWS:

COMMENCING AT A FOUND 5/8" REBAR AT THE SOUTHEAST CORNER OF THE NORTHWEST QUARTER OF THE NORTHEAST QUARTER OF THE SOUTHWEST QUARTER; THENCE N2°00'10"E ALONG THE EAST LINE THEREOF 318.18 FEET TO A SET 1/2" REBAR WITH CAP #1573 FOR THE POINT OF BEGINNING; THENCE N89°48'30"W 318.08 FEET TO A SET 1/2" REBAR WITH CAP #1573; THENCE N89°01'24"W 322.37 FEET TO SET 1/2" REBAR WITH CAP #1573; THENCE N2°32'37"E ALONG THE WEST LINE THEREOF 337.10 FEET TO A FOUND REBAR AND CAP AT THE NORTHWEST CORNER OF THE NORTHWEST QUARTER OF THE NORTHEAST QUARTER OF THE SOUTHWEST QUARTER; THENCE N89°44'08"W ALONG THE SOUTH LINE OF LOT 99, MIDLAND FARM SUBDIVISION FOR 1045.03 FEET TO A FOUND REBAR AND RASBURRY CAP; THENCE N1°54'51"E 330.49 FEET TO A FOUND REBAR AND RASBURRY CAP ON THE SOUTH LINE OF LOT 101, MIDLANDS FARM SUBDIVISION; THENCE N89°52'07"W ALONG THE SOUTH LINE OF LOT 101, MIDLAND FARM SUBDIVISION 265.53 FEET TO A FOUND 1" PINCH PIPE LOCATED ON THE EAST RIGHT-OF-WAY LINE OF MIDLAND ROAD SAID POINT ALSO BEING THE SOUTHWEST CORNER OF LOT 101, MIDLAND FARM SUBDIVISION; THENCE N2°16'41"E ALONG SAID EAST RIGHT-OF-WAY LINE OF MIDLAND ROAD 165.23 FEET TO A FOUND 1" PINCH PIPE AT THE NORTHWEST CORNER OF LOT 101, MIDLAND FARM SUBDIVISION; THENCE S89°47'35"E ALONG THE NORTH LINE OF LOT 101, MIDLAND FARM SUBDIVISION 1308.65 FEET TO A FOUND 1/2" PIPE AT THE NORTHEAST CORNER OF LOT 101, MIDLAND FARM SUBDIVISION AND ALSO BEING A POINT ON THE WEST LINE OF THE WEST HALF OF THE SOUTHEAST OUARTER OF THE NORTHWEST QUARTER; THENCE S89°52'06"E 343.28 FEET TO A SET 1/2" REBAR WITH CAP #1573 ON THE EAST RIGHT-OF-WAY OF CREEKWATER DRIVE; THENCE S1°58'21"W ALONG SAID RIGHT-OF-WAY 115.05 FEET TO A SET 1/2" REBAR WITH CAP #1573, THENCE S89°48'38"E LEAVING SAID RIGHT-OF-WAY 294.89 FEET TO A SET 1/2" REBAR WITH CAP #1573 LOCATED ON THE EAST LINE OF THE WEST HALF OF THE SOUTHEAST QUARTER OF THE NORTHWEST OUARTER; THENCE S1°52'38"W ALONG SAID EAST LINE OF THE WEST HALF OF THE SOUTHEAST QUARTER OF THE NORTHWEST QUARTER 385.29 FEET TO A FOUND 1/2" REBAR LOCATED AT THE NORTHEAST CORNER OF THE NORTHWEST QUARTER OF THE NORTHEAST QUARTER OF THE SOUTHWEST QUARTER; THENCE S2°00'33"W ALONG SAID EAST LINE OF THE NORTHWEST OUARTER OF THE NORTHEAST QUARTER OF THE SOUTHWEST QUARTER 337.81 FEET TO THE POINT OF BEGINNING, CONTAINING 24.37 ACRES, MORE OR LESS.

WHEREAS, it is deemed desirable that all of the above described property be subdivided into building lots (LOTS 1 THROUGH 14 AND LOTS 77 THROUGH 79, CREEKSIDE ADDITION PHASE I), common areas, tracts and streets as shown on the Plat filed in conjunction with the Bill of Assurance; and,

WHEREAS, the aforementioned property is part of the real property which is subject to a Declaration of Covenants and Restrictions filed on the 30 day of 4 day of 4, 2018, in the Office of the Circuit Clerk and Recorder of Saline County, Arkansas, as Instrument No. 2018 ("The Declaration of Covenants and Restrictions"), which establishes a community with common facilities and amenities known as **CREEKSIDE ADDITION**; and

WHEREAS, it is deemed desirable that all of the above described property be subdivided, held, owned and conveyed subject to the covenants and restrictions contained in The Declaration of Covenants and Restrictions and subject also to the easements, reservations and restrictions shown on the Plat which is filed in conjunction herewith, and subject also to the protective covenants contained in this Bill of Assurance in order to enhance the value of such property.

NOW, THEREFORE, Developer has caused said tract of land to be surveyed by GarNat Engineering, LLC,., registered professional engineers and land surveyors, and plat thereof made, which is attached hereto, showing the subdivision of said tract of land into lots and streets. The lands embraced in said plat shall be forever known as **CREEKSIDE ADDITION** (Phase I), an Addition to the City of Bryant, Saline County, Arkansas. Said Plat bears the signature of the said land surveyor and Developer, and is of record in the Office of the Circuit Clerk and Recorder of Saline County, Arkansas, in Plat Book 2018 010749, and Developer does hereby make this Bill of Assurance applicable to such property.

Developer does hereby certify that it has laid off, platted and subdivided and does hereby lay off, plat and subdivide said real estate as **CREEKSIDE ADDITION**, an Addition to the City of Bryant, Saline County, Arkansas, and each and every deed of conveyance for any lot or tract in said Addition describing the same by the number or numbers as shown on said Plat shall always be deemed a sufficient description thereof. Developer hereby dedicates to the public forever an easement of way on and over the streets as shown on said Plat to be used as public streets.

In addition to the said streets, there are shown on said Plat certain easements, including easements for drainage and utilities. Developer hereby donates and dedicates such utility easements to and for the use of public utilities, the same being, without limiting the generality of the foregoing, electrical power, cable television, gas, telephone, water and sewer, with the right hereby granted to the persons, firms or corporations engaged in the supplying of such utility services to use and occupy such easements and to have free ingress and egress thereon for the installation, maintenance, repair and replacement of such utility services. Any and all other easements and reservations shown on the Plat, such as easements and reservations for entry facilities, signs, landscaping, ingress and egress, fencing, and the like, are also hereby dedicated and donated to and for the use of the Developer, Creekside Property Owners Association, Inc. upon its formation in accordance with The Declaration of Covenants and Restrictions), and its members.

The filing of the Plat and Bill of Assurance for record in the Office of the Circuit Clerk and Recorder of Saline County, Arkansas, shall be valid and complete delivery and dedication of the streets and easements shown on said Plat, and the streets in said CREEKSIDE ADDITION shall be known by the names designated on said Plat. Said land herein platted and any interest therein shall be held, owned and conveyed subject to and in conformity with the covenants of The Declaration of Covenants and Restrictions establishing CREEKSIDE ADDITION. In addition, the following covenants and restrictions shall also apply, subject to being amended or cancelled as hereinafter provided, and shall be and remain in full force and effect until December 31, 2038, unless extended.

1. <u>LOT AREA AND WIDTH</u>. No residence shall be erected, altered or permitted to remain on any lot covered by this Bill of Assurance and shown on the P1at referenced herein if the area of the lot is less than 7,200 square feet or if the width thereof at the front building line is less than sixty feet (60'). No lot shall be

subdivided without written consent of Developer and the Bryant Planning Commission.

- 2. **LAND USE, BUILDING TYPE, AND DWELLING SIZE**. All lots shall be used for residential purposes only. No dwelling shall be erected, altered, placed or permitted to remain on any lot other than:
  - a. One detached, site-built, single-family residential structure with a minimum main floor area, exclusive of porches, patios, carports, garages and breezeways of 2,000 square feet for a single-level home and 2,400 square feet for a two-story home.
  - b. Foundations of all residential dwellings must be veneered with brick or rock.
  - c. Each residence must include, at minimum, a double enclosed garage or a separate detached garage to house, at minimum, two standard-sized, passenger motor vehicles.
  - d. All residential dwellings must have a minimum 8/12 roof pitch on at least 80% of the total roofline.
  - e. No lot as shown on the attached plat shall be subdivided, but one or more contiguous lots may be combined and utilized as a single lot.
  - f. Garages and other outbuildings are permitted, but most clearly incidental to residential use of said land, and shall only be for use by the occupants of the residence to which they are appurtenant. Garages and outbuildings must be approved by the Architectural Control Committee and have an architectural style that is complementary to the dwelling. No garage or outbuilding shall be used for residential dwelling purposes. All outbuildings shall be constructed to the rear of any residence and must be kept orderly and in good repair.
  - g. No lot shall be used for commercial purposes; however, such restriction shall not prohibit the temporary maintenance of model homes for promotional purposes by Developer or other professional builders.

No development shall take place in the areas on the plat marked "Undisturbed Area." Nor shall the areas so marked be disturbed or altered in any manner, but must remain in their natural state.

3. ARCHITECTURAL CONTROL. No construction or clearing shall be undertaken on any lot in CREEKSIDE ADDITION unless and until all plans, elevations, and materials for such construction shall be first submitted to the Architectural Control Committee for consideration and the Architectural Control Committee has approved such plans, elevations, and materials. The process of submission and approval shall be undertaken in accordance with the Declarations of Covenants and Restrictions and the Architectural Control Guidelines in effect from time to time. The Architectural Control Committee may, in its sole discretion, disapprove of any submissions, make suggested revisions for resubmittal, or take other actions in an effort to develop

- CREEKSIDE ADDITION as an integrated subdivision consisting of residences of similar size and compatible architectural style so as to create a neighborhood with common and complementary architectural elements. In the event an Architectural Control Committee has not been formed, the Developer shall assume the role of the Architectural Control Committee until such time as such committee is formed.
- 4. **BUILDING LOCATION**. No building shall be constructed on any lot nearer to the street than twenty-five feet (25') or as shown by the building line and setback lines shown on said plat. No residential structure shall be located nearer to an interior lot line than eight feet (8') in width. For purposes of this restriction, eaves, steps and open porches shall not be considered a part of the dwelling. Residential structures shall be no closer than twenty feet (20') to the rear lot line. The Architectural Control Committee may, in its sole discretion, waive or adjust these requirements on a case by case basis upon written request before any construction is undertaken, subject in all events to the receipt of a waiver from the governmental authority with jurisdiction.
- 5. **COMMON AREAS**. Shown on the plat filed in conjunction with this Bill of Assurance is an area noted as Tract A, designated as a detention facility / park area reserved for the exclusive use and enjoyment of the owners of property in **CREEKSIDE ADDITION**. Unless specific easements for access, ingress and egress are shown on the recorded plat, no common area may be used for access, ingress, egress, parking, storage of materials, dumping of debris, excavating, filling, or for any other use inconsistent with this paragraph.
- 6. MAINTENANCE OF COMMON AREAS. All common areas in CREEKSIDE ADDITION and improvements therein, including greenbelts, islands, medians, and tracts of land set aside and reserved for drainage, buffer, park and aesthetic purposes shall be maintained by Creekside Property Owners Association, Inc. upon its formation and at its sole cost. All such areas shall be dedicated, donated, or sold by the Developer to the association and will be reserved for the use and benefit of owners of lots within CREEKSIDE ADDITION.
- 7. **PROPERTY LINES AND BOUNDARIES.** Iron pins have been set on all lot comers and points of curve, and all curve data shown on said Plat referenced herein is centerline curve data. In the event of minor discrepancies between the dimensions or distances shown on the Plat and the actual dimensions or distances as disclosed by the established pins, the original pins as set shall control.
- 8. SIGN, FENCE AND LANDSCAPE EASEMENT. Sign and landscape easements may be reserved by the Developer on portions of lots or land in CREEKSIDE ADDITION. These easements permit the construction, maintenance and upkeep of permanent subdivision identification signs, fountains, fences and associated landscaping, berms and rocks, and are reserved for the use and benefit of Developer for as long as Developer holds title to any land or lots in CREEKSIDE ADDITION or in contiguous lands subsequently platted as CREEKSIDE ADDITION. Developer may assign these easements to any organization representing owners of lots in CREEKSIDE ADDITION at any time during the period

Developer holds title to any land or lots in **CREEKSIDE ADDITION**. If no assignment takes place during such period, or if Developer releases an easement, the easement shall cease to exist. The developer or its assigns retain the right to construct, maintain and keep temporary or permanent identification signs or interpretive signs on any Tract or common area in **CREEKSIDE ADDITION**.

- 9. **DRIVEWAYS.** All driveways shall be paved with concrete within 45 days from completion of the residential structure, or the move-in date (whichever occurs first). No curb cuts shall be allowed for driveways.
- 10. <u>SIDEWALKS.</u> It shall be the responsibility of all owners of lots to construct a five-foot (5') wide sidewalk, approximately sixty inches (60") from the back of curb along all street frontage, as shown on the plat, in compliance with all requirements of the Americans With Disabilities Act (ADA) and any requirement of the City of Bryant.
- 11. **FENCES.** All fencing placed, erected or altered on any lot, interior lot lines, and rear lot lines must be approved by the Developer or Architectural Control Committee prior to construction.
- 12. **MAILBOXES.** Subdivision will be served by community mailboxes. No individual mailboxes are allowed, per U.S. Postal Code.
- 13. **SIGNS.** Except for subdivision identification signs, no sign of any kind shall be placed or permitted to remain on any part of said property, except one professional sign of not more than five (5) square feet advertising the property for sale or rent, or signs used by the Developer or a builder to advertise property during the construction and sales period, or otherwise with reference to model homes.
- 14. <u>COMMENCEMENT OF CONSTRUCTION</u>. A property owner must start construction of an approved dwelling within a period of one (1) year from date of lot purchase, unless an extension is approved by the Architectural Control Committee. Lots must be kept in a well-maintained, safe, clean and attractive condition until construction commences.
- 15. **COMPLETION OF CONSTRUCTION**. Any dwelling must be completed in its entirety within a period of one (1) year from date such construction is commenced.
- 16. **PUBLIC UTILITIES.** All dwellings and other structures erected upon any lot as a residential dwelling shall be served by all public utilities, including public sewer. E-1 or equivalent grinder pump stations and service lines to the lateral must be installed on individual lots by a professional contractor and inspected/approved by the City of Bryant as determined by the city's policies and procedures. Stations are to be sealed to prevent water intrusion. Top of station shall be constructed one foot (1') below finish floor. Purchase, installation, and continued maintenance of the grinder pump station and all service lines to the lateral are the responsibility of the lot owner.

- 17. **OWNER RESPONSIBILITY.** All property owners shall ensure that any contractor performing services for the property owner shall comply with the provisions of this Bill of Assurance.
- 18. **ENFORCEMENT.** In the event of any attempt to violate any of the covenants or restrictions contained herein before the expiration date hereof, it shall be lawful for **CREEKSIDE** Community Association, Inc., any appropriate governmental authority, the Developer, or any person or persons owning a lot or lots in **CREEKSIDE ADDITION** to initiate compliance procedures pursuant to the terms of The Declaration of Covenants and Restrictions, or to pursue any other lawful remedy.
- 19. <u>AMENDMENT.</u> This Bill of Assurance may be cancelled, amended or extended in accordance with the terms set forth in The Declaration of Covenants and Restrictions. No amendment shall be effective unless and until duly enacted pursuant to the terms of The Declaration of Covenants and Restrictions and properly filed for record in the Office of the Circuit Clerk and Recorder for Saline County, Arkansas.
- 20. **SEVERABILITY.** The invalidation of any one of these covenants or restrictions by any court of competent jurisdiction or otherwise shall in no way affect any of the other provisions, which shall be independent and which shall remain in full force and effect.

Executed this 29th day of August, 2018.

DIAMOND DEVELOPMENT II

By: Hose

#### **ACKNOWLEDGMENT**

#### STATE OF ARKANSAS

#### **COUNTY OF SALINE**

On this <u>A9th</u> day of <u>August</u>, 2018, before me, a notary public, duly commissioned, qualified and acting within and for the county and state aforesaid, appeared in person <u>Tim Hastings</u>, to me well known, who stated that he was president of Hometime Builders, Inc., a partner of Diamond Development II, and was duly authorized in his capacity to execute the foregoing instrument for and in the name and on behalf of said partnership, and further stated and acknowledged that he had so signed, executed and delivered said foregoing instrument for the consideration, uses, and purposes therein mentioned and set forth.

IN TESTIMONY WHEREOF, I have hereunto set my hand and seal the day and year aforesaid.

Susan R Holdman Notary Public

My Commission Expires: 11/7/2025

SUSAN R. GOLDMAN SALINE COUNTY NOTARY PUBLIC - ARKANSAS My Commission Expires November 07, 2025 Commission No. 12692688



#### **Subdivision Checklist**

Approved by Bryant Planning Commission 07/14/2003 Revised 6/18/2007

#### Instructions

The attached checklist must be completed by the owner and subdivision engineer and must be submitted along with the Preliminary Plat Plan and other specified documentation for review and approval by the Planning Commission. The owner may not begin developing the subdivision until the review of the Preliminary Plat plan is approved.

No changes or alterations can be made to the approved Preliminary Plat Plan without Planning Commission approval.

When all lots have been surveyed, the utilities and drainage measures are in place, and roads have been constructed, the owner and engineer will submit a Final Plat Plan for approval by the Commission. This Final Plat Plan will incorporate all approved changes and will be verified by the City Engineer. No lots will be sold or rights-of-way and easements conveyed until the Final Plat has been submitted and approved.

#### Fees due to City of Bryant upon submission of Preliminary Plat application

- \$300.00 + \$3.00 per lot for Subdivision preliminary plat review
- \$250.00 or \$25.00 per lot (whichever is greater) Stormwater Detention and Drainage Plan Engineering Fee
- A Surety Bond or Cashier's check in the amount of 10% of the estimated development cost must be furnished within 10 days after Preliminary Plat approval.

#### Fees due to Bryant Water and Sewer Department upon submission of Final Plat application

- \$100 per lot Water/Sewer Impact Fee
- \$100 per Subdivision Phase Water/Sewer Flushing Fee

#### Fees due to City of Bryant upon submission of Final Plat application

\$25.00 + \$1.00 per lot - for Subdivision Final Plat review

#### City of Bryant Subdivision Checklist

Subdivision/Project Name	CREEKSIDE	ADDITION	PHASE Z
Subdivision/Project Name CREEKSIDE ADDITION PHASE Z  Contact Person VERNON WILLIAMS Phone (501) 408-4650  Mailing Address P.O. BOX II 6 BENTON, AR 72018  3825 MT CARMEL ROAD BRYANT, AR			
I BASIC INFORMATION NEE	DED ON THE DI AT		1 70 - 30

#### I. BASIC INFORMATION NEEDED ON THE PLAT

12012

- 1. Name of Subdivision/Project
- 2. Current zoning \_\_\_\_\_
- Name and Address of owner of Record **3**.
- **4**. Illustrate Source of Title giving deed record book and page number
- Name & address of the sub-divider
- **6**. Date of Survey
- **7**. Vicinity map locating streets, highways, section lines, railroad, schools, & parks within 1/2 mile
- Legal description of the property with exact boundary lines **8**.
- Acreage of property
- 10. Number of Lots
- 11. Lot area in square feet
- 12. Lot lines with appropriate dimensions
- 13. Building setback lines
- 14. Preliminary Engineering certificate seal and signature on each page
- ▲ 15. Certificate of Engineering Accuracy
- ▲ 16. Certificate of Owner
- ▲ 17. Certificate of Final Plat Approval
- ▲ 18. Certificate of Recording
- ▲ 19. Show scale (not less than 1" = 100')
- 20. North Arrow
- ▲ 21. Show Title block
- 22. Show adjoining property owners
- 23. Layout of all proposed streets including traffic control devices (stop signs, speed limit, etc.)
  - 24. Layout of all subdivision entrance street upgrades
- 25. Layout of all proposed alleys
- 26. Layout of all proposed sidewalk systems
- ▲ 27. Layout identifies any FEMA flood plain and flood way property within the 100-year flood elevation. (Provide Corp of Engineers 404 Permit if required)
- 28. Drainage easements for stormwater run-off and detention giving dimensions, locations, and purpose
- 29. Layout accommodates Master Street Plan segments within the boundaries
- 30. Street layout ties to existing adjoining subdivision stub-out streets and provides stub-out streets for future adjoining subdivisions.
- 31. Street width and right-of-way properly shown for each functional classification
- ▲ 32. Street centerlines showing angles of deflection, intersection, radii, length oftangents and arcs, and degree of curvature with basis of curve data
- ▲ 33. Typical cross section of streets
- ▲ 34. Location and name of existing streets
- ▲ 35. New street names that are not similar to existing street names
- 36. Show street lights
- ▲ 37. Show Fire Hydrant placement

- ▲ 38. Show and label all permanent & proposed easements
- ▲ 39. Any proposed open space must be shown
- ▲ 40. Show the direction and flow of all water courses entering the tract
- 41. Show the direction and flow of all water courses leaving the tract
- ▲ 42. The drainage area of all water courses above the points of entry.
- ▲ 43. The downstream drainage channel and drainage structures substantially impacted by the subdivision/project.
- ▲ 44. Show source of water supply
- ▲ 45. Show location of waste water connection to municipal main & sanitary sewer layout
- ▲ 46. A phasing plan outlining the boundaries for each phase

#### II. ADDITIONAL INFORMATION NEEDED, BUT NOT NECESSARILY ON THE PLAT

- 47. Natural features within the proposed subdivision including drainage channels, bodies of water, wooded areas, and other significant features
- ▲ 48. Existing streets, buildings, water courses, railroads. Culverts, utilities and easement on and adjacent to the tract.
- ▲ 49. Where method of disposal of wastewater is other than connection to a public waste water system, detailed information shall accompany the plat.
- ▲ 50. Calculations and field notes, including drainage calculations along with support drawing
  - 51. Stormwater detention plan approval from City Engineer (attach copy of approval)
- ▲ 52. The Certificate of Preliminary Engineering Accuracy on each set of street and drainage plans.
- ▲ 53. ADA Accessibility Standard Form completed (and attached)
- ▲ 54. A Bill of Assurance has been prepared for this subdivision (and attached)
- ▲ 55. All lots comply with minimum square footage area and minimum lot width at the front building line
- ▲ 56. Street pavement design will be as specified by City or AHTD design procedures, approved by the City Engineer.
- ▲ 57. Made the "One Call" prior to site clearance or other excavation activity

#### III. PRELIMINARY PLAT ATTACHMENTS

#### (APPLICATION WILL NOT BE ACCEPTED UNTIL ALL ATTACHMENT REQUIREMENTS ARE MET)

- ▲ 58. Letter to Planning Commission stating your request
- 59. Completed Checklist
- ▲ 60. Completed agreement to provide performance assurance
- ▲ 61. Subdivider Performance Bond or Cashier's Check for infrastructure installation
- 62. Landscaping plan of any proposed common open space
- ▲ 63. Draft of Bill of Assurance proposed for the subdivision (if applicable)
- ▲ 64. 20 copies of Preliminary Plat Plan (folded) that includes vicinity map (minimum size 17" X 34" paper)
- ▲ 65. <u>Two</u> (2) IBM compatible diskettes or CDR's with pertinent data and Plat in CAD compatible .DXF electronic file format
- ▲ 66. Copy of Stormwater Detention approval
- ▲ 67. 2 copies Plan and profile of all streets
- ▲ 68. Receipt for \$300.00 + \$3.00 per lot for preliminary Subdivision fee
- ▲ 69. Receipt for \$250.00 or \$25.00 per lot (whichever is greater) for Stormwater Detention and Drainage Plan review
- ▲ 70. Copy of ADEQ Stormwater Pollution Prevention Plan for property parcel containing one acre or larger.

#### III. FINAL PLAT ATTACHMENTS

#### (APPLICATION WILL NOT BE ACCEPTED UNTIL ALL ATTACHMENT REQUIREMENTS ARE MET)

- ▲ 71. Letter to Planning Commission stating your request
- ▲ 72. Completed Checklist
- ▲ 73. 20 copies of Final Plat Plan (folded) that includes vicinity map (minimum size 17" X 34" paper)
- ▲ 74. Two (2) IBM compatible diskettes or CDR's with pertinent data and Plat in CAD compatible .DXF electronic file format
- ▲ 75. Bill of Assurance including provisions set out in Title 15 Subdivision Regulations 15.16.01
- ▲ 76. Copy of Water & Sewer Commission approval or....
- ▲ 77. State Health Department approval of any new water supply and/or sewage system.
- ▲ 78. Letter submitted by a Registered Professional Engineer, certifying that all infrastructure

plans and drawings and the standards est 79. Infrastructure Maintenance Bond or Cash 80. Check for \$25.00 + \$1.00 per lot for fin	
CREEKSIDE ADDITION-PHASE Name of Subdivision	E 2 Surveyor P. Worden
I HAVE COMPLIED WITH THE REQUIREMENTS LISTED CHECKLIST WHICH APPLY TO THIS PROJECT SUBMIT Owner Signature	ABOVE AND HAVE CHECKED ALL OF THE BOXES ON THE TAL.  Verney J. Williams  Engineer Signature
	CITY USE
Preliminary Plat Approved	-
Planning Commission Date	- -
Final Plat Approved	_
Planning Commission Date	
Proof of Recording - County	
County Clerk	Date


# CREEKSIDE SUBDIVISION PHASE 2 BRYANT, ARKANSAS


# Prepared by: GarNat Engineering, LLC

Designing our client's success www.garnatengineering.com

P.O. Box 116
Benton, AR 72018
Ph (501) 408-4650

3825 Mt Carmel Road Bryant, AR 72022 Fx (888) 900-3068

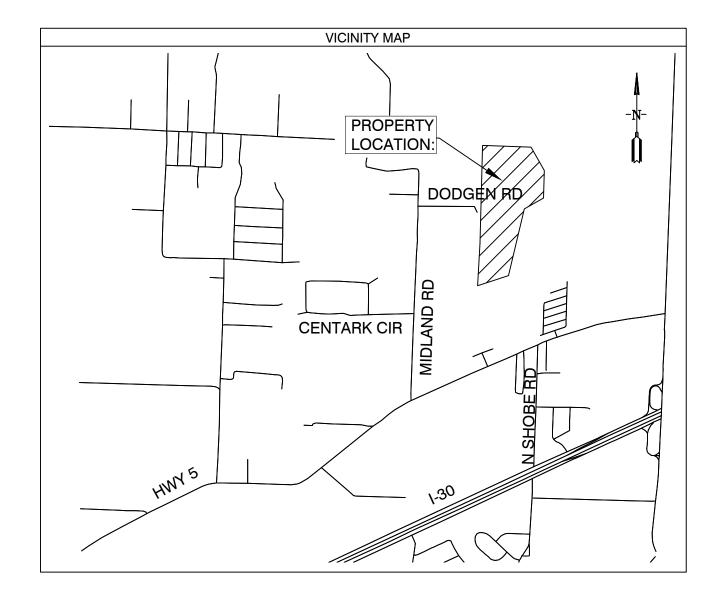

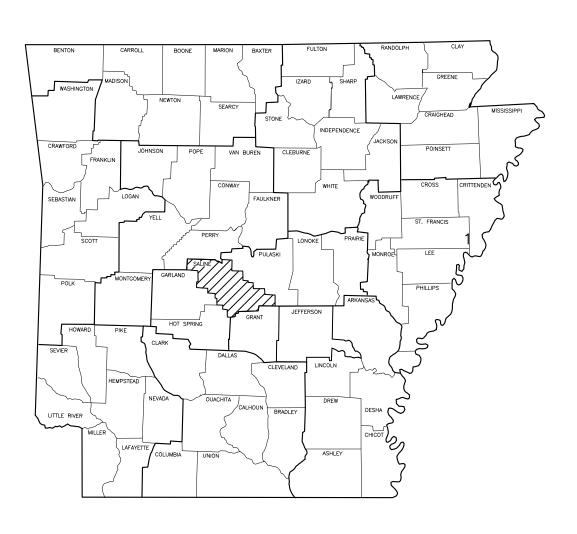


ARKANSAS





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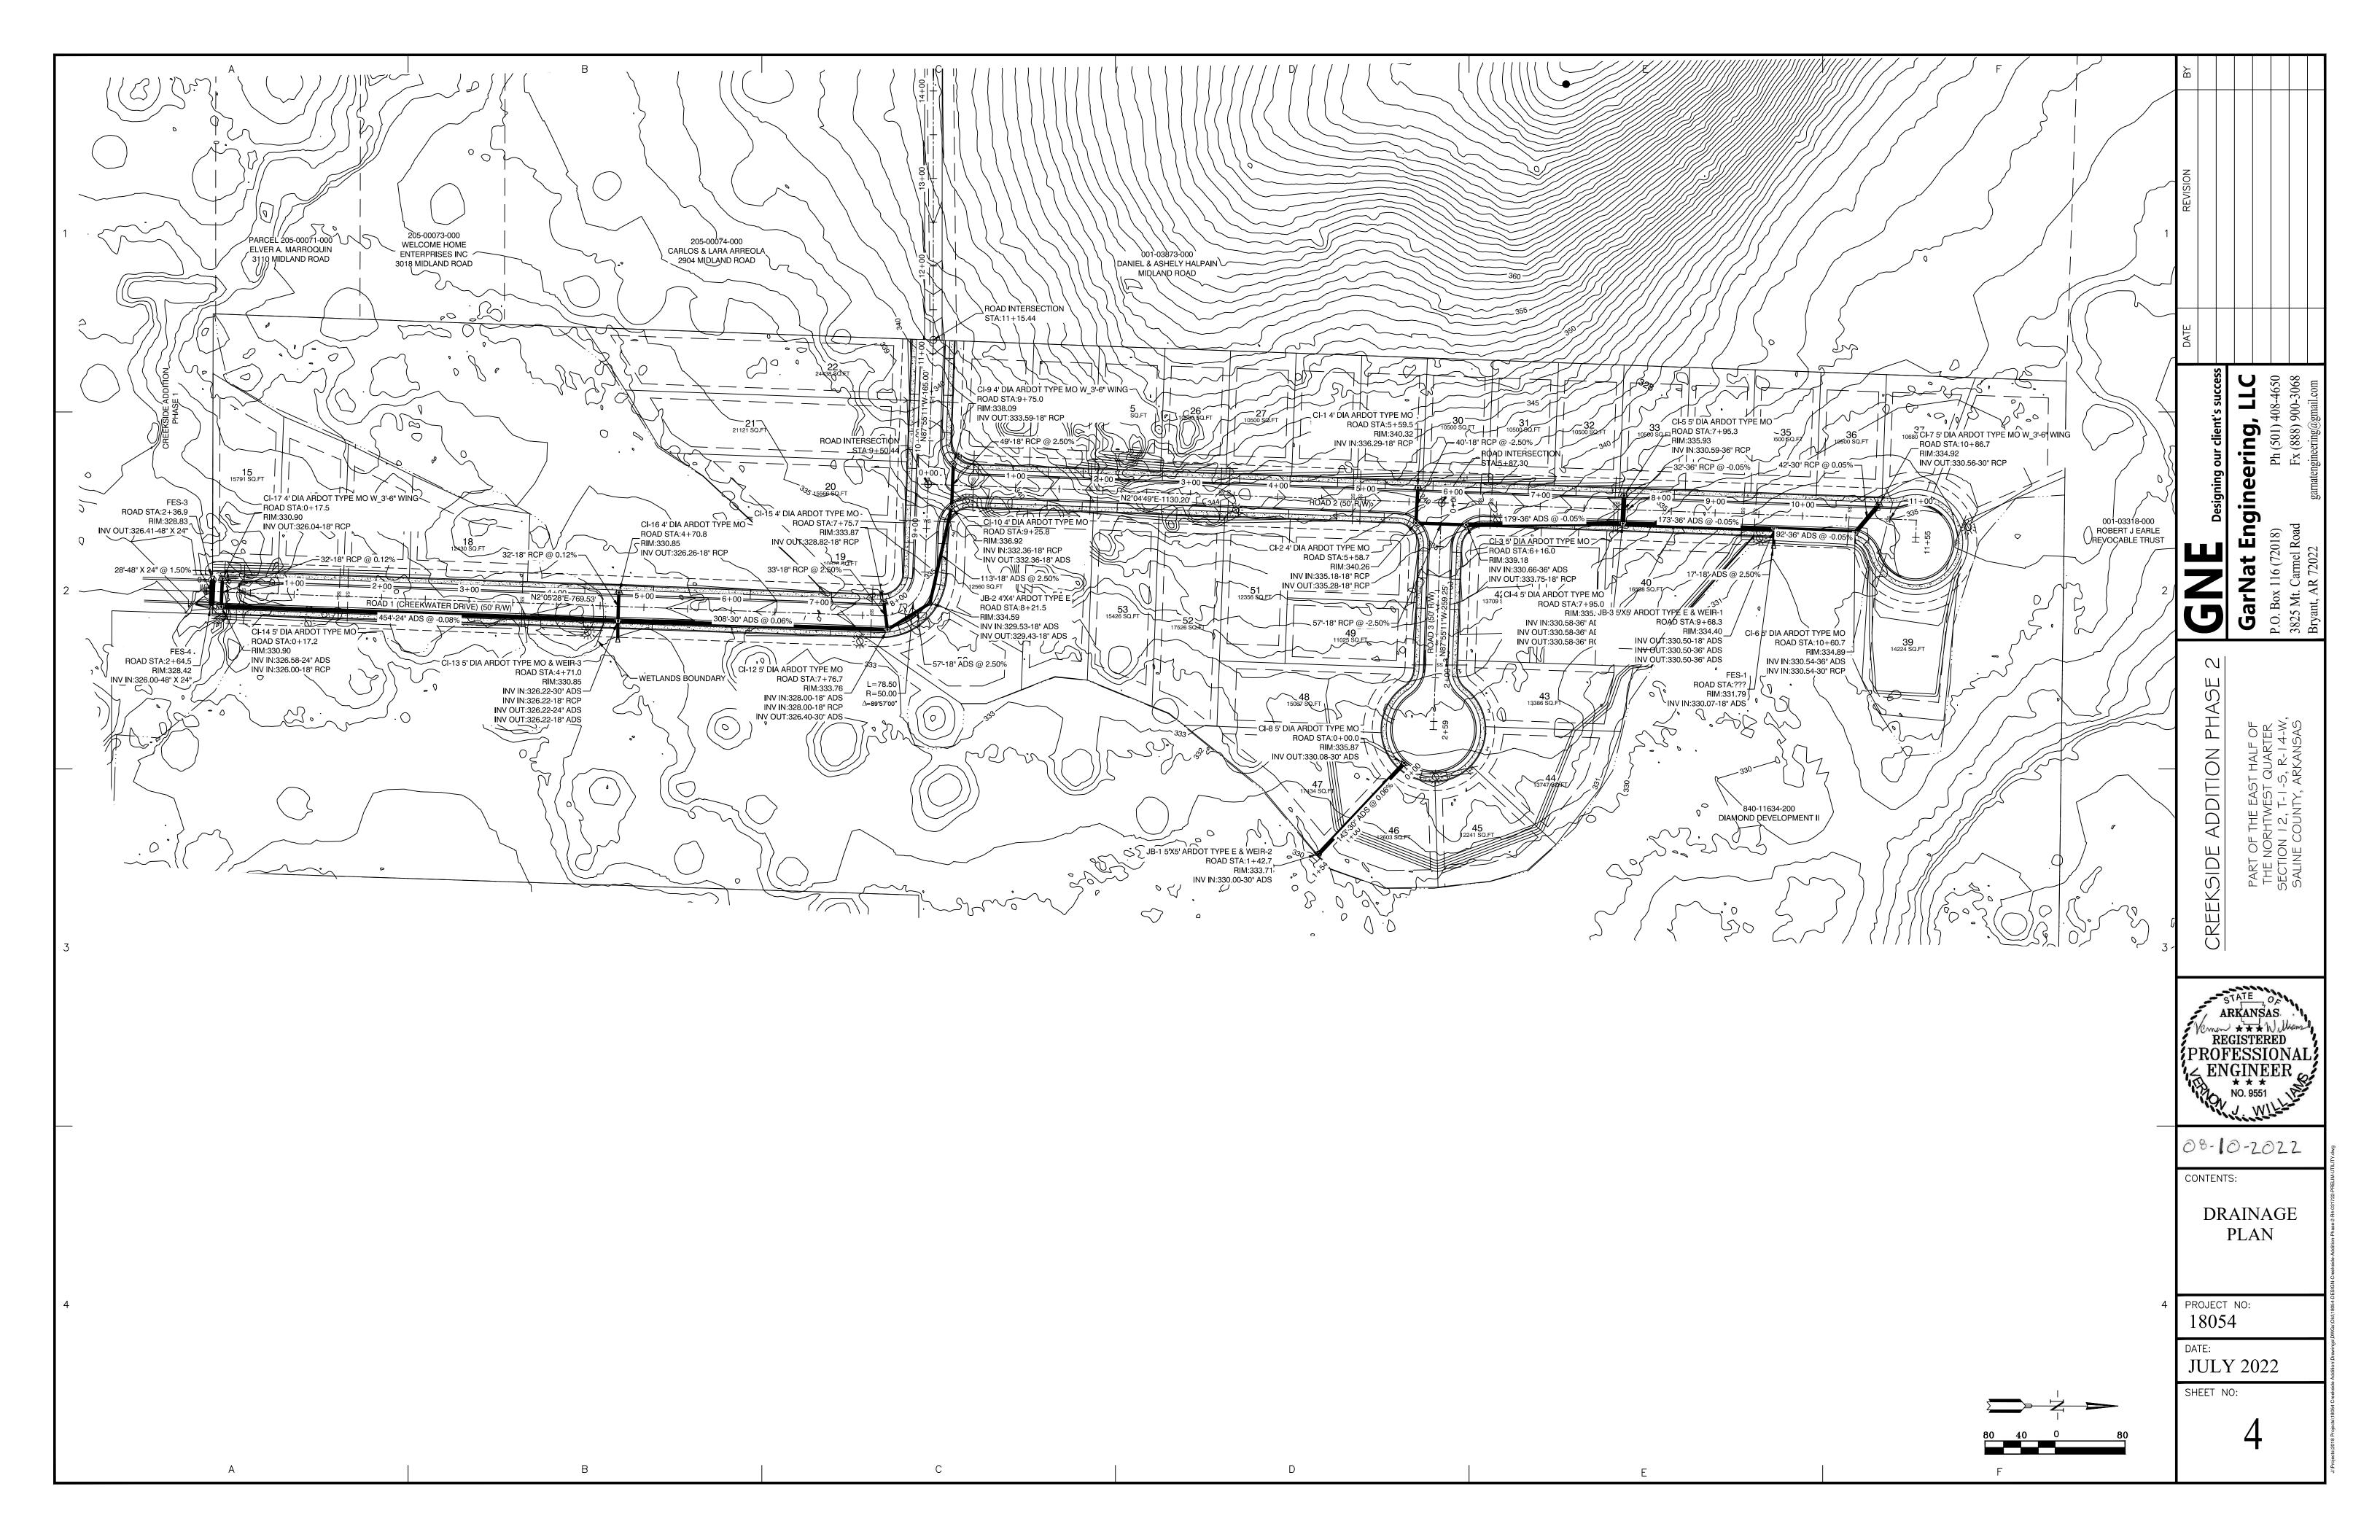
- 1 PRELIMINARY PLAT OVERALL
- 2 PRELIMINARY PLAT SOUTH HALF
- 3 PRELIMINARY PLAT NORTH HALF
- 4 DRAINAGE PLAN
- 5 ROAD PROFILES
- 6 DRAINAGE PROFILES
- 7 OVER SEWER & WATER PLANS
- 8 OULLET STRUCTURE DETAILS
- 9. EROSION CONTROL PLAN







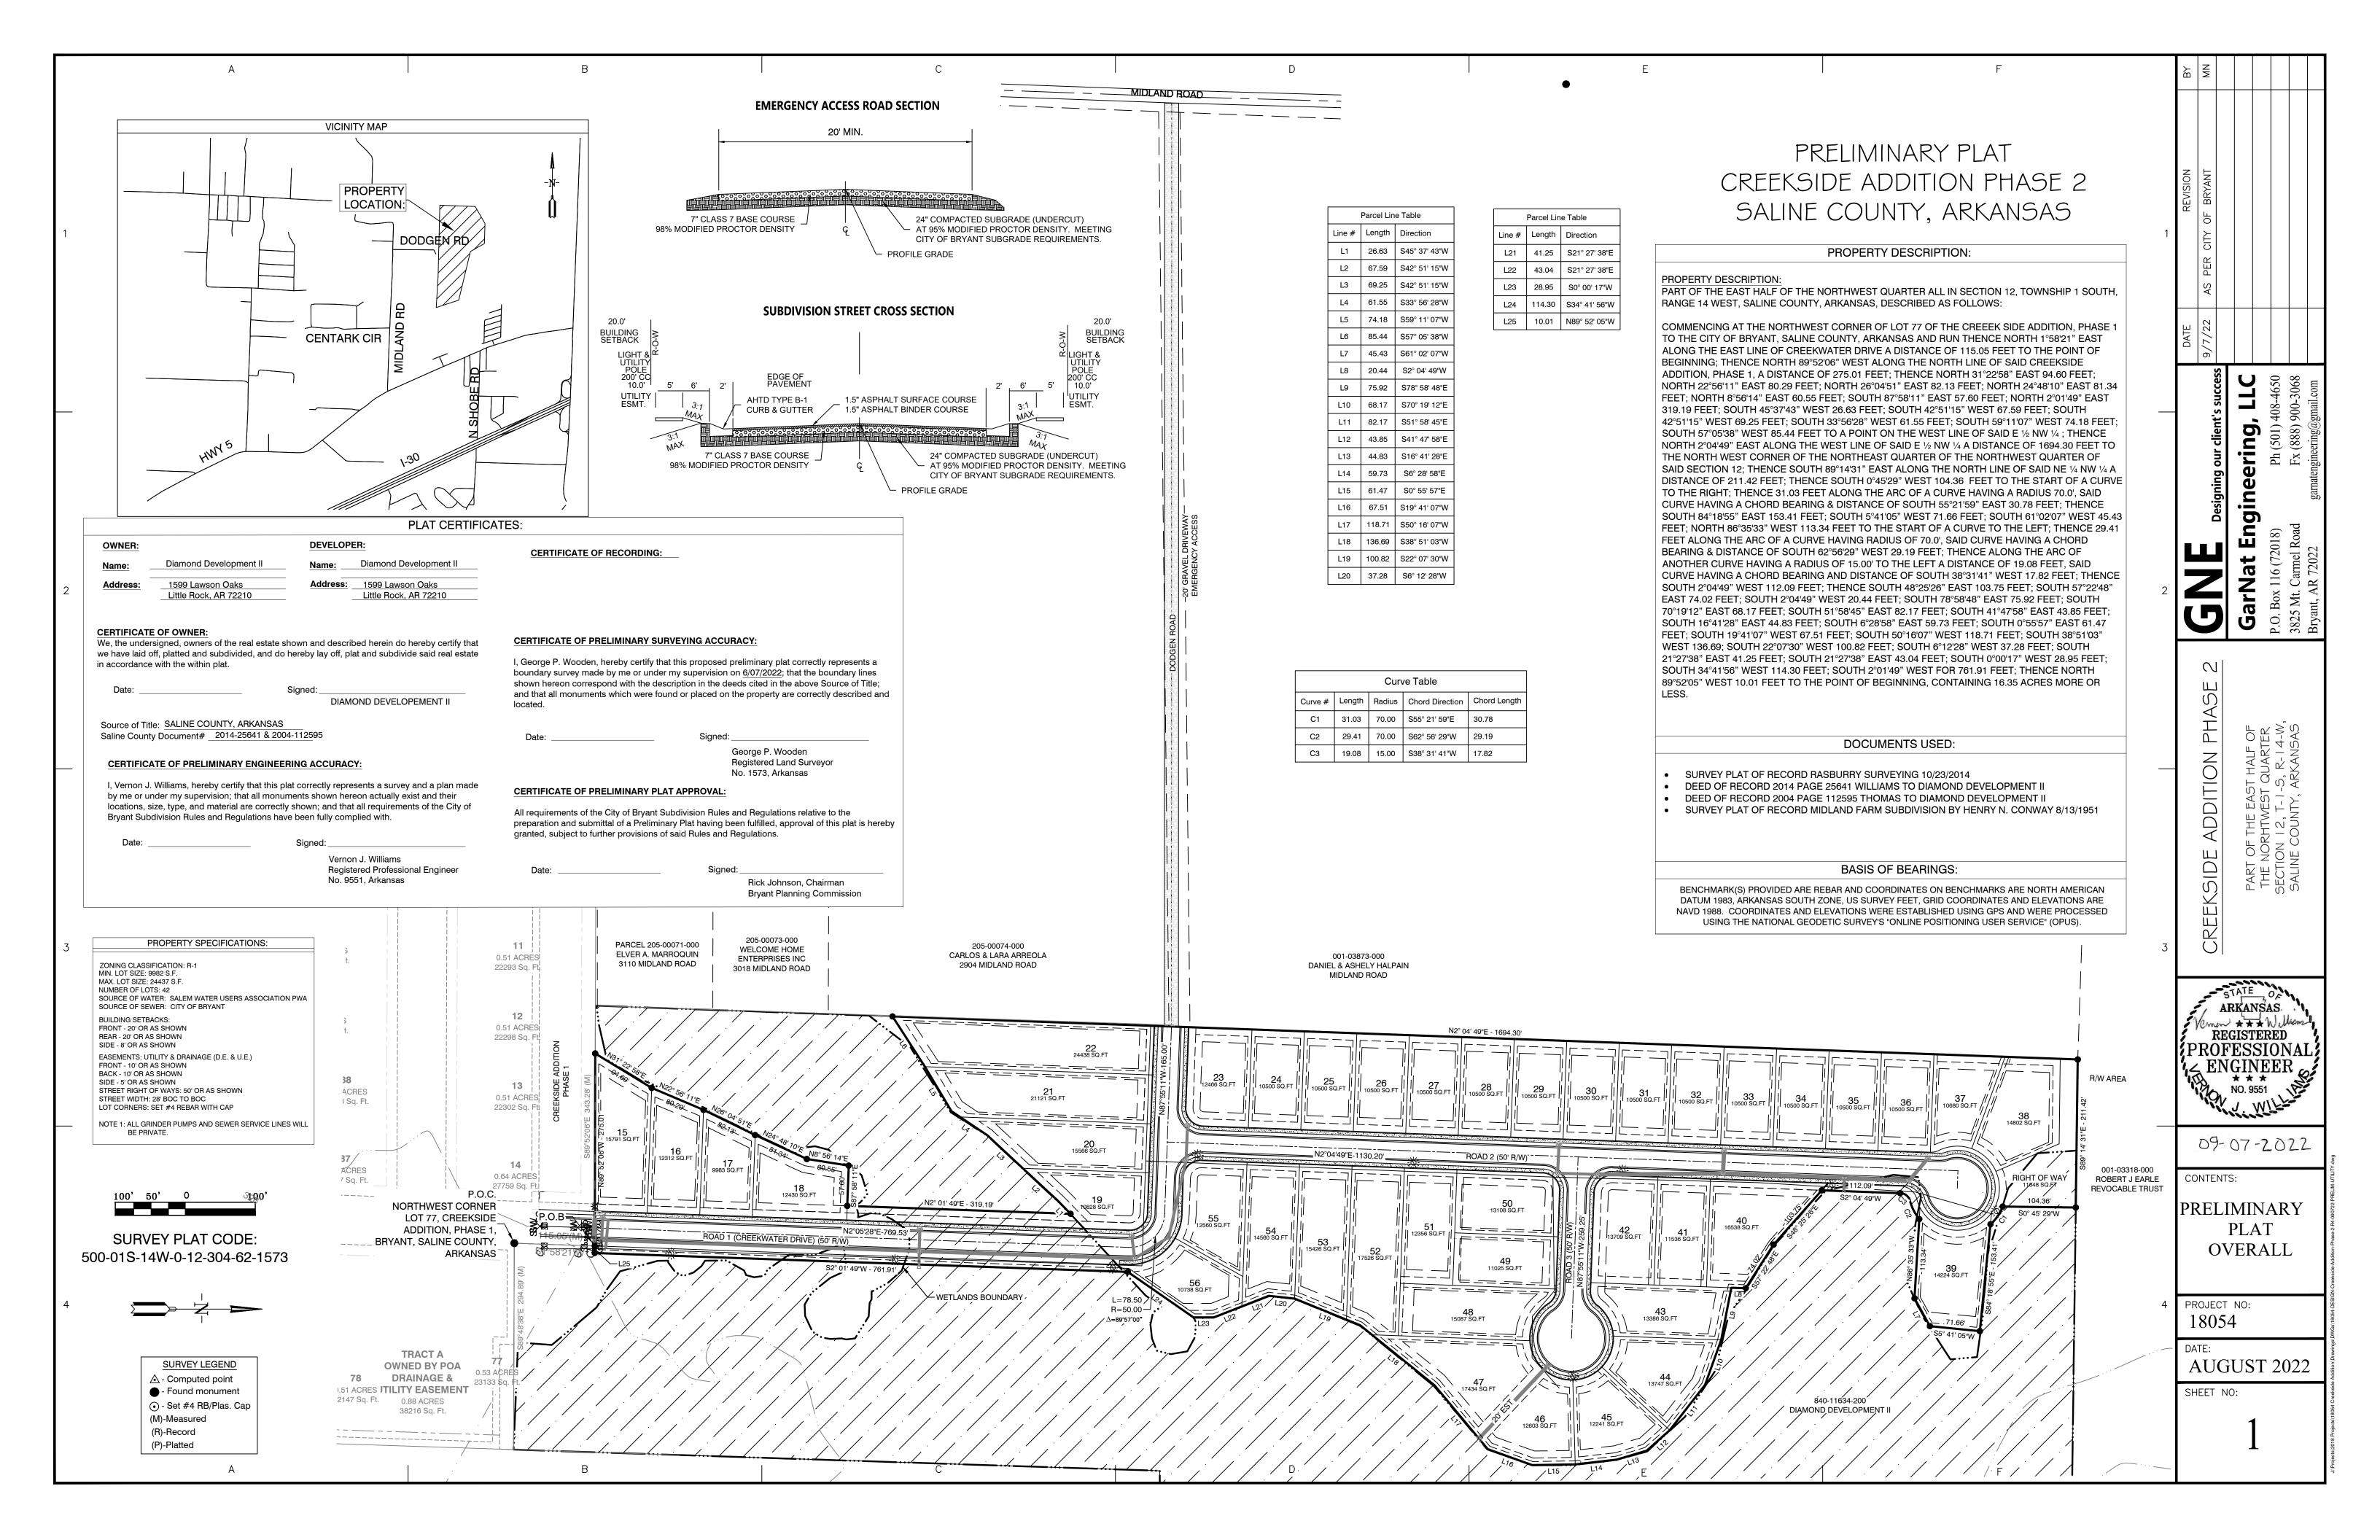


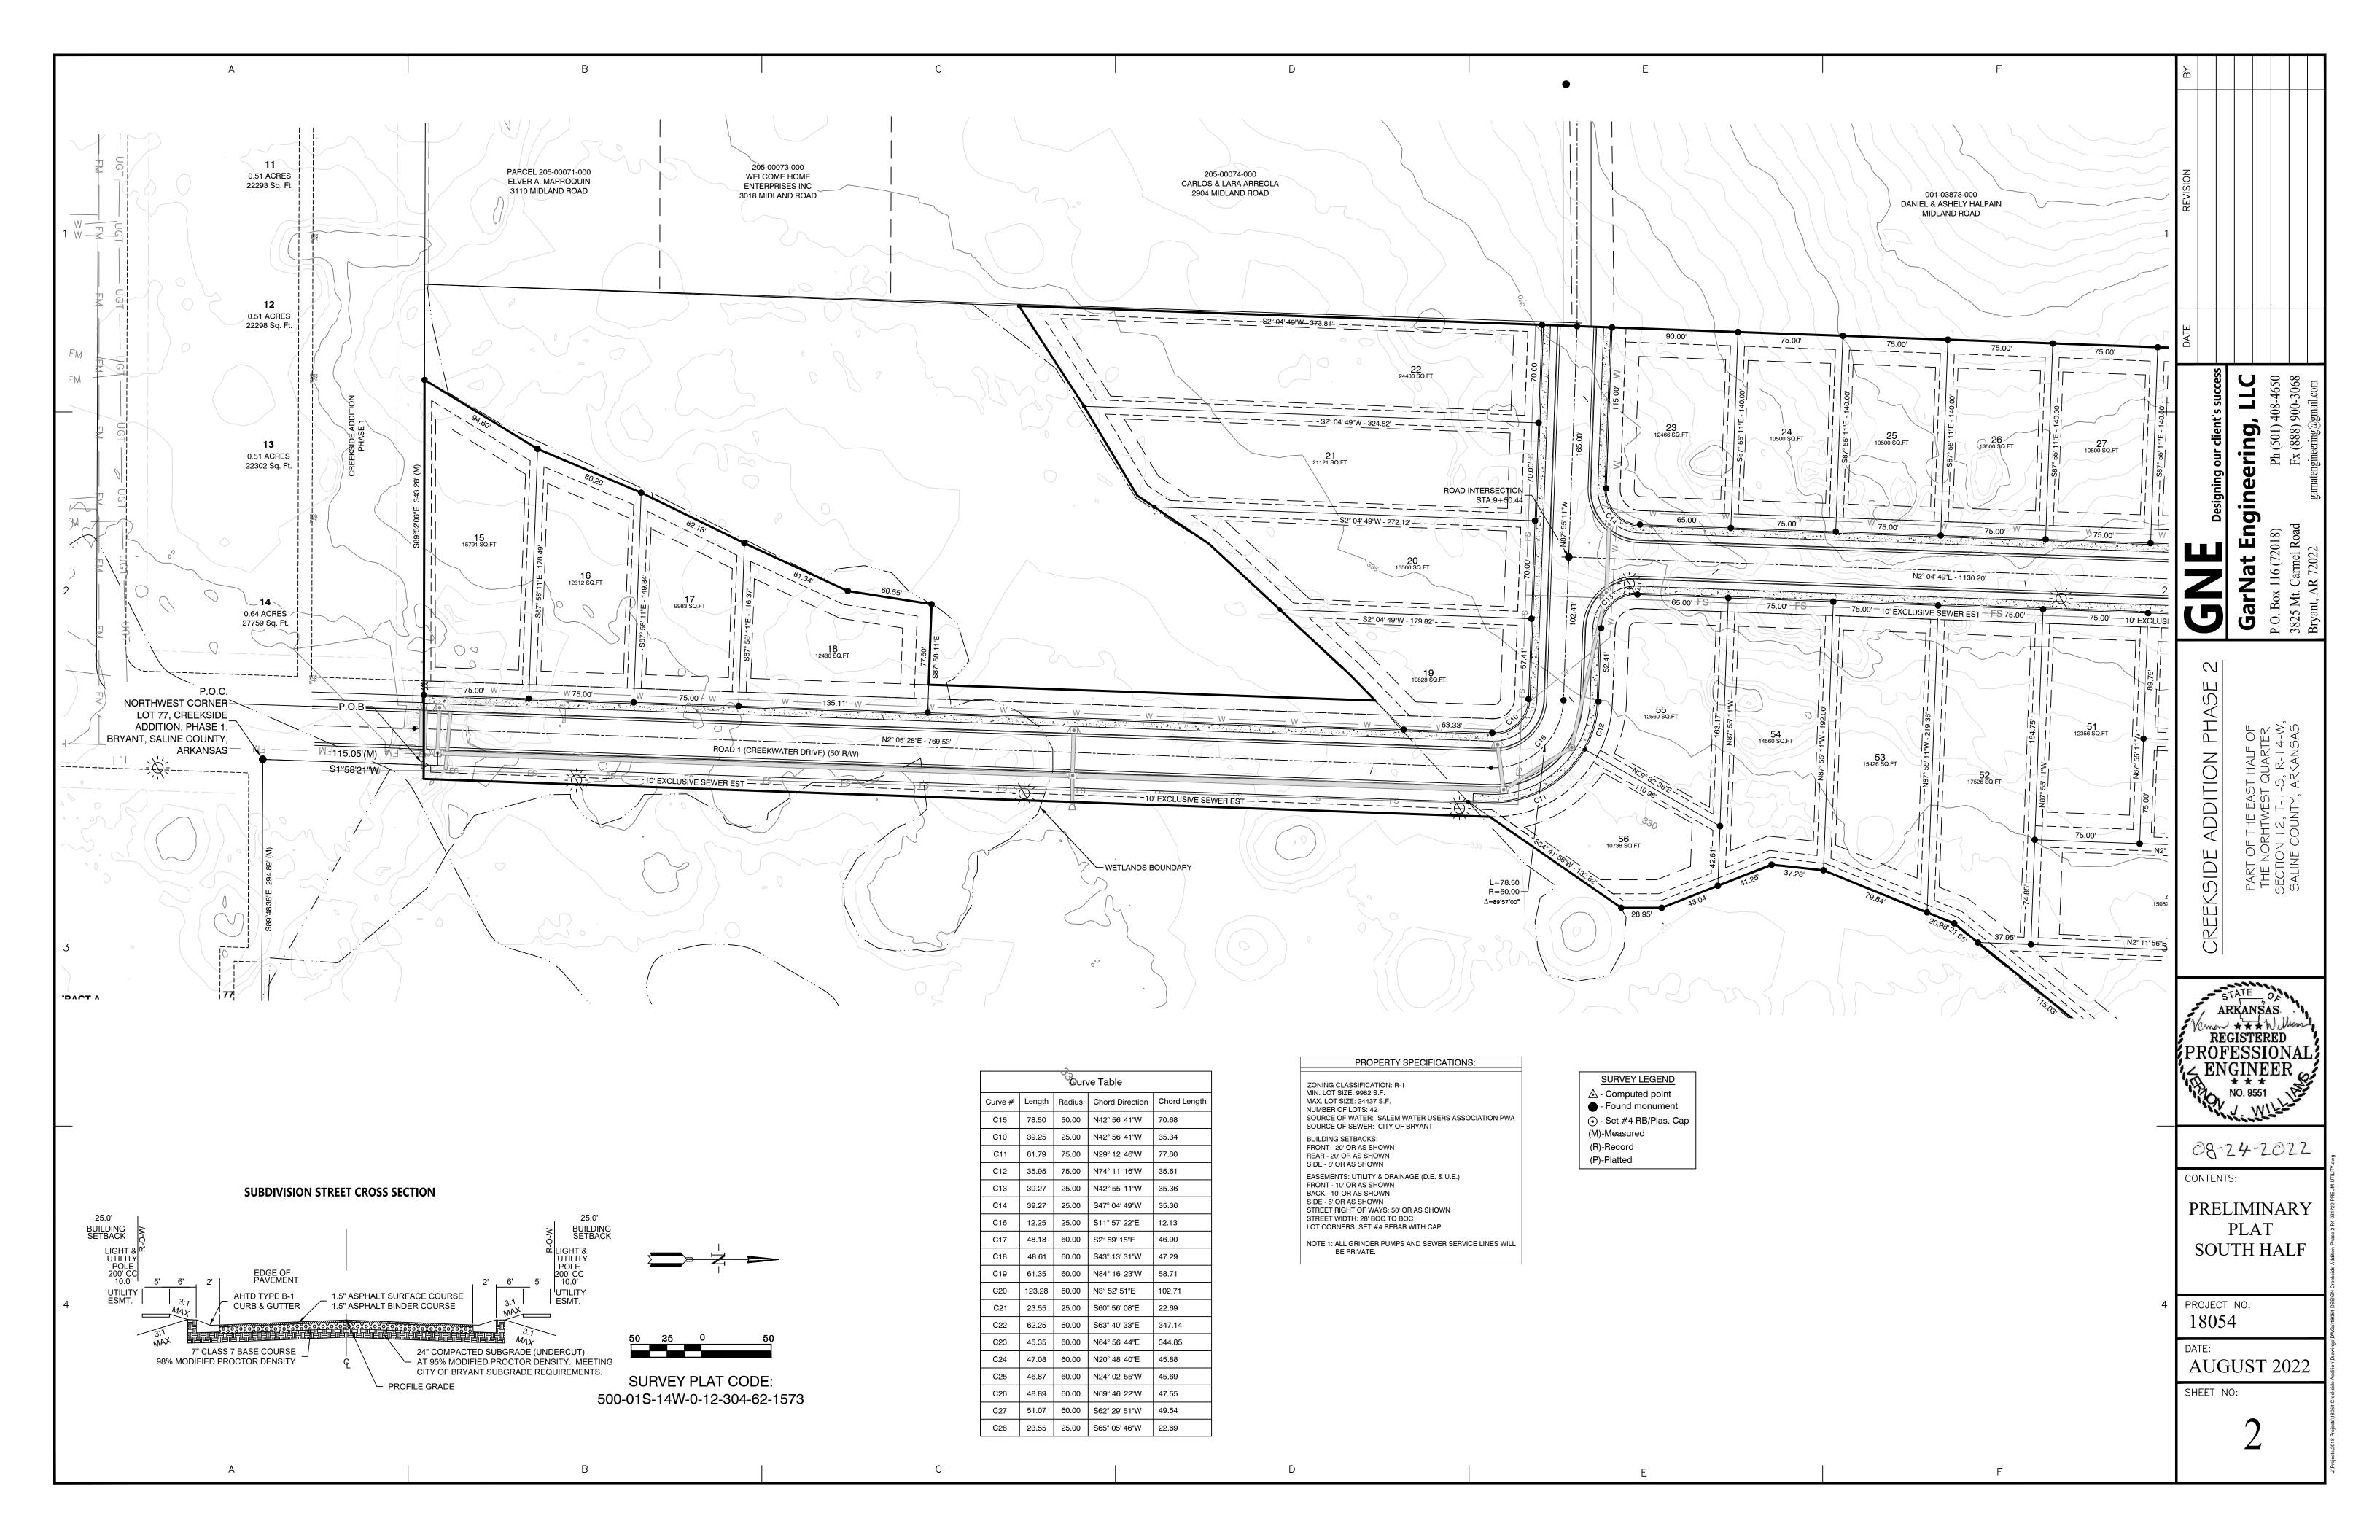

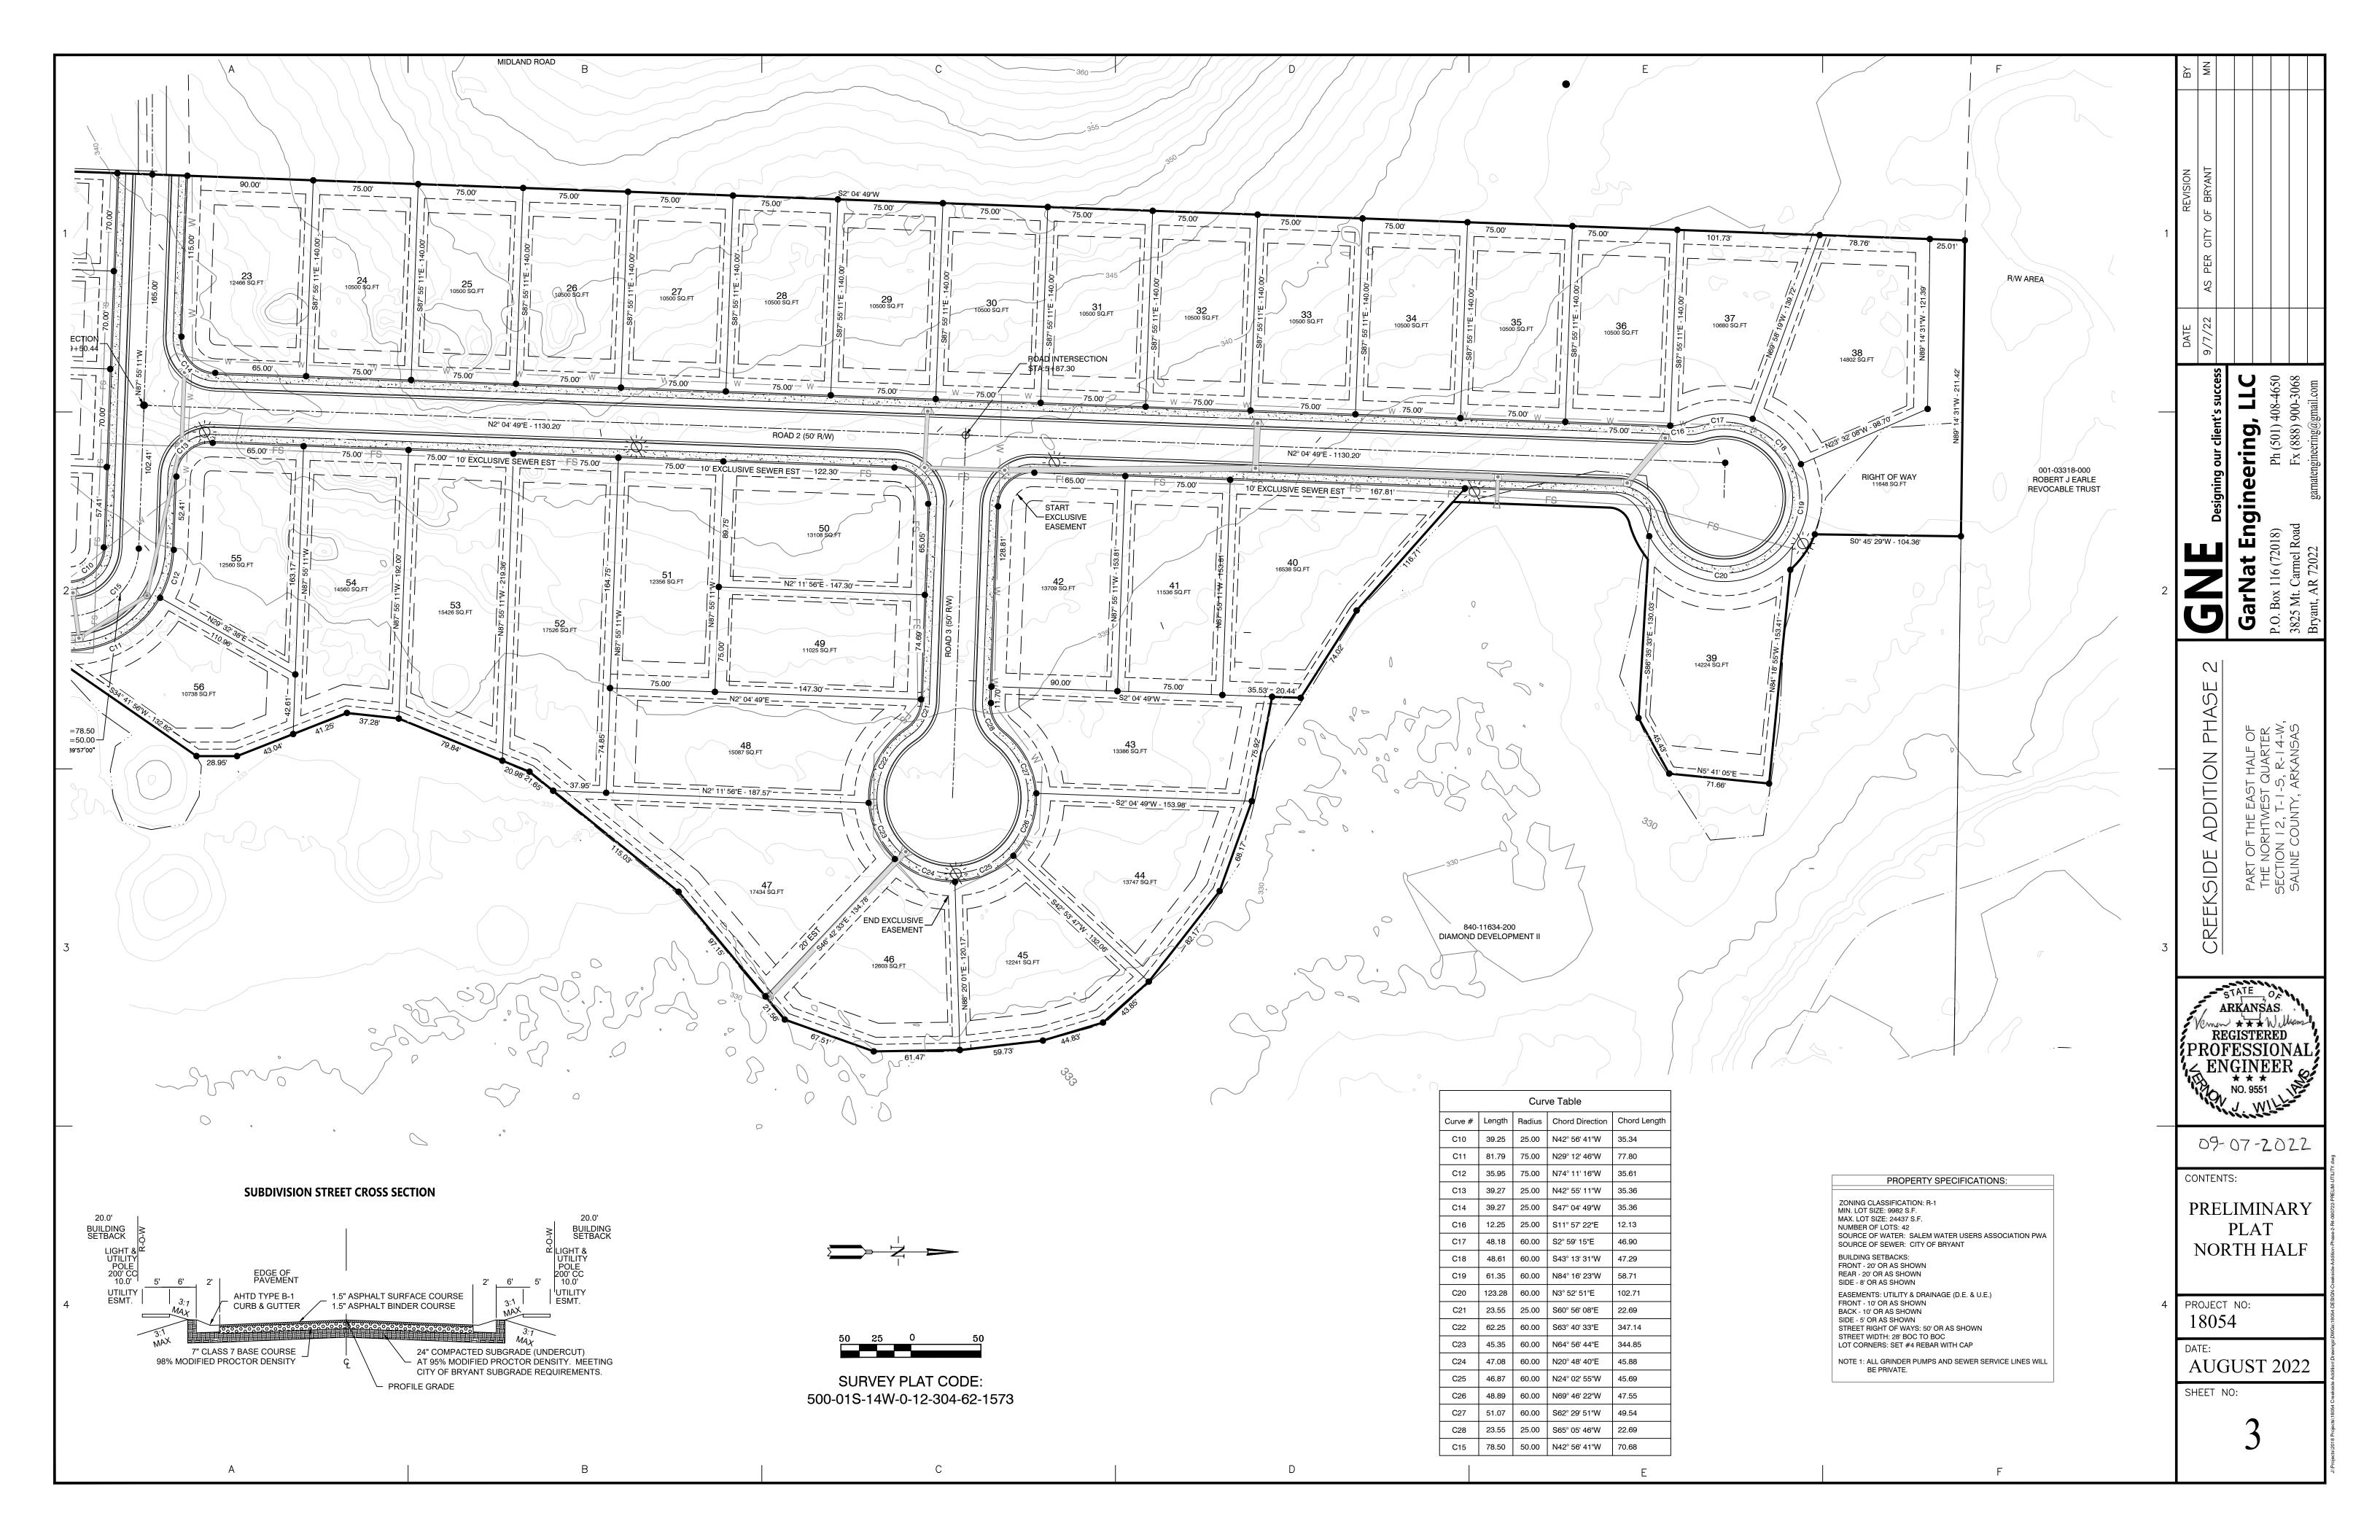

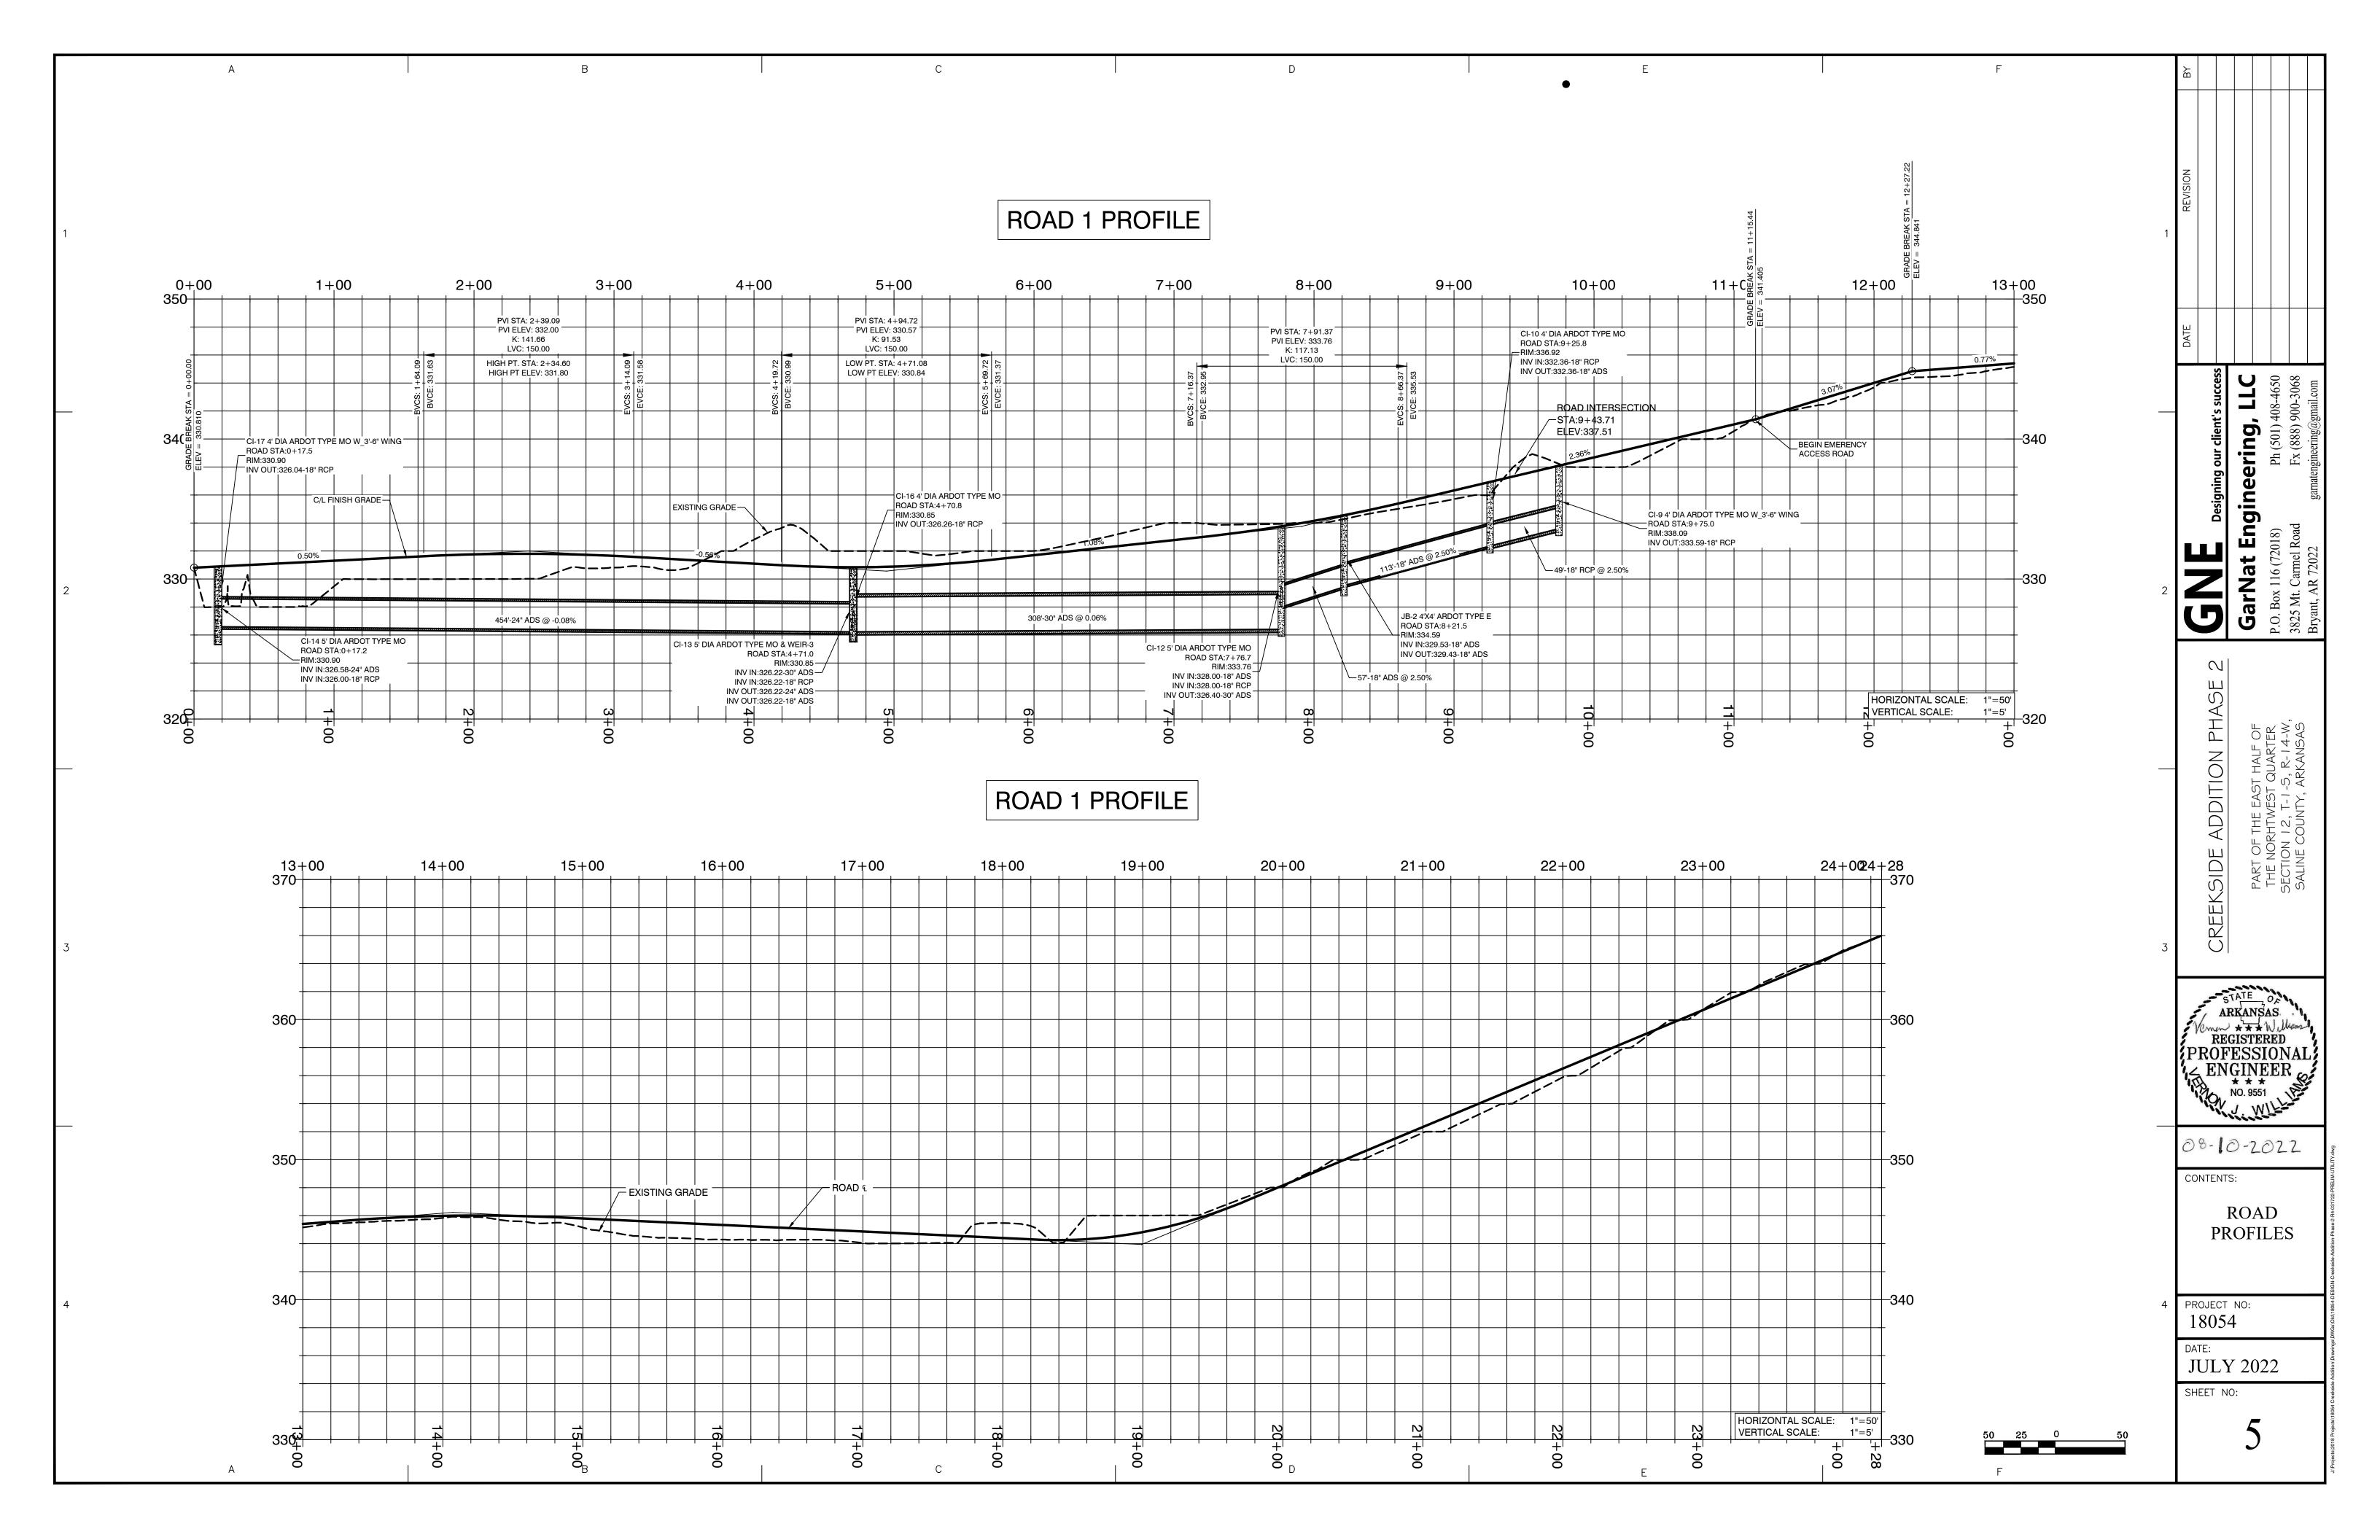

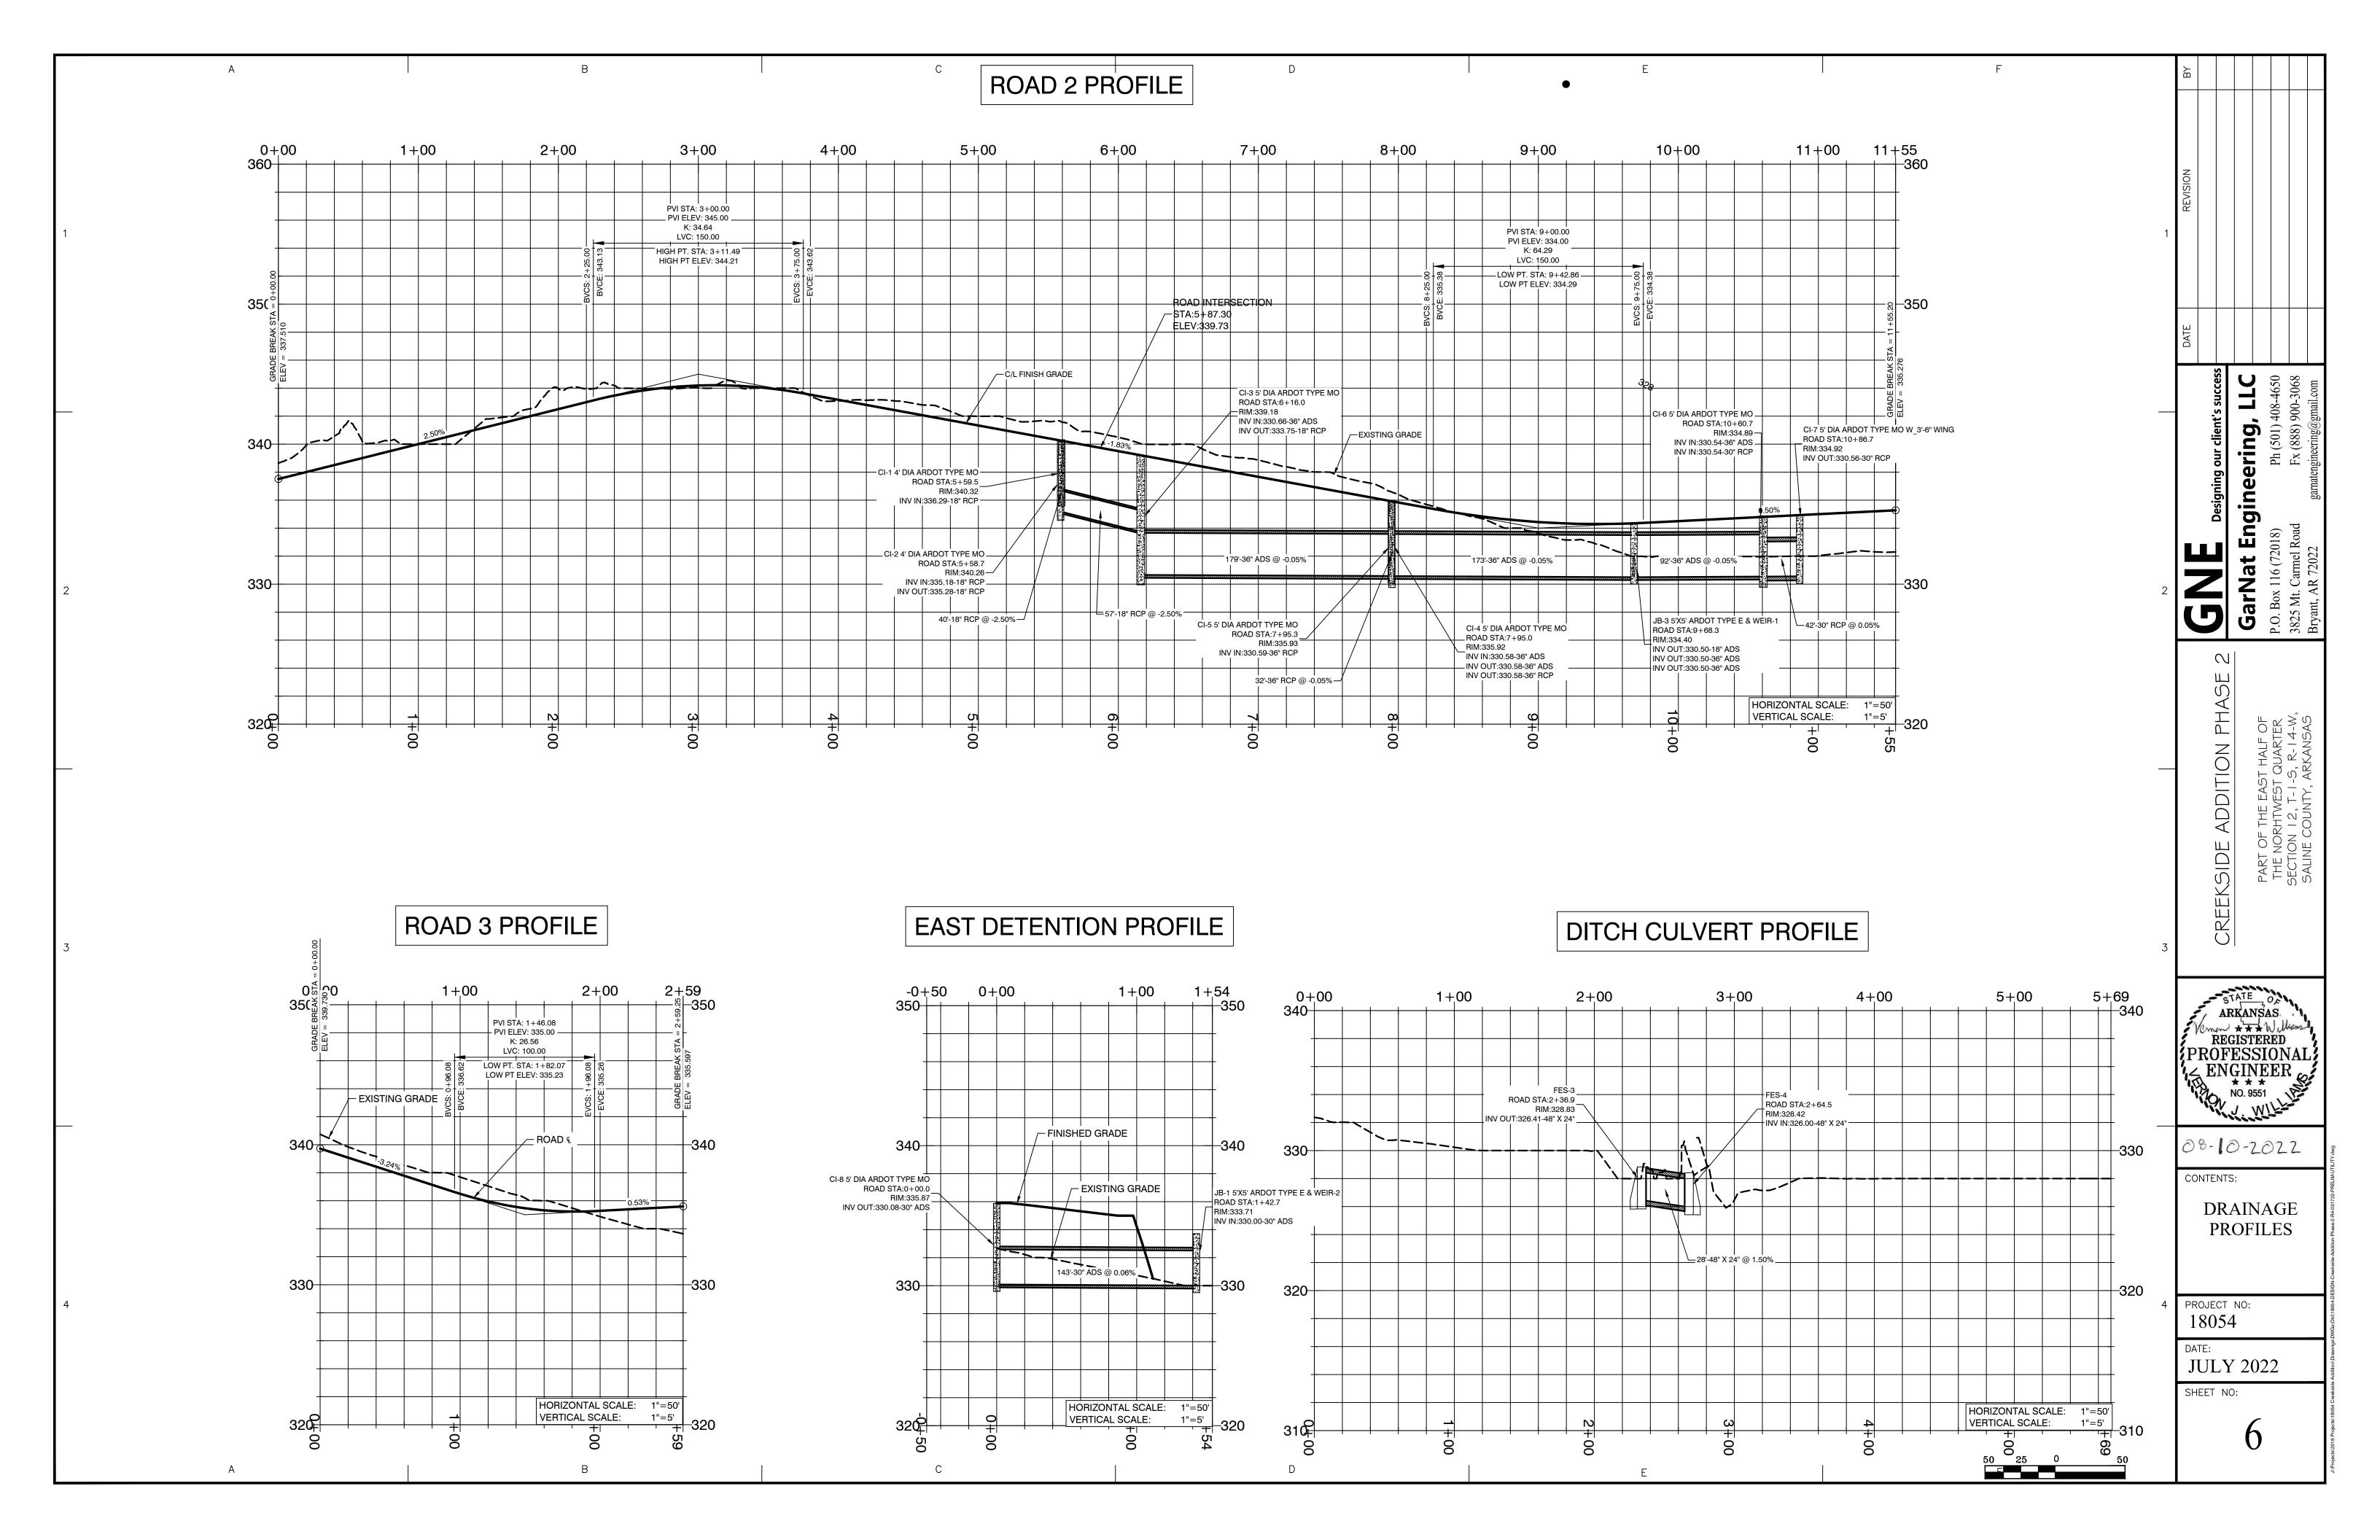

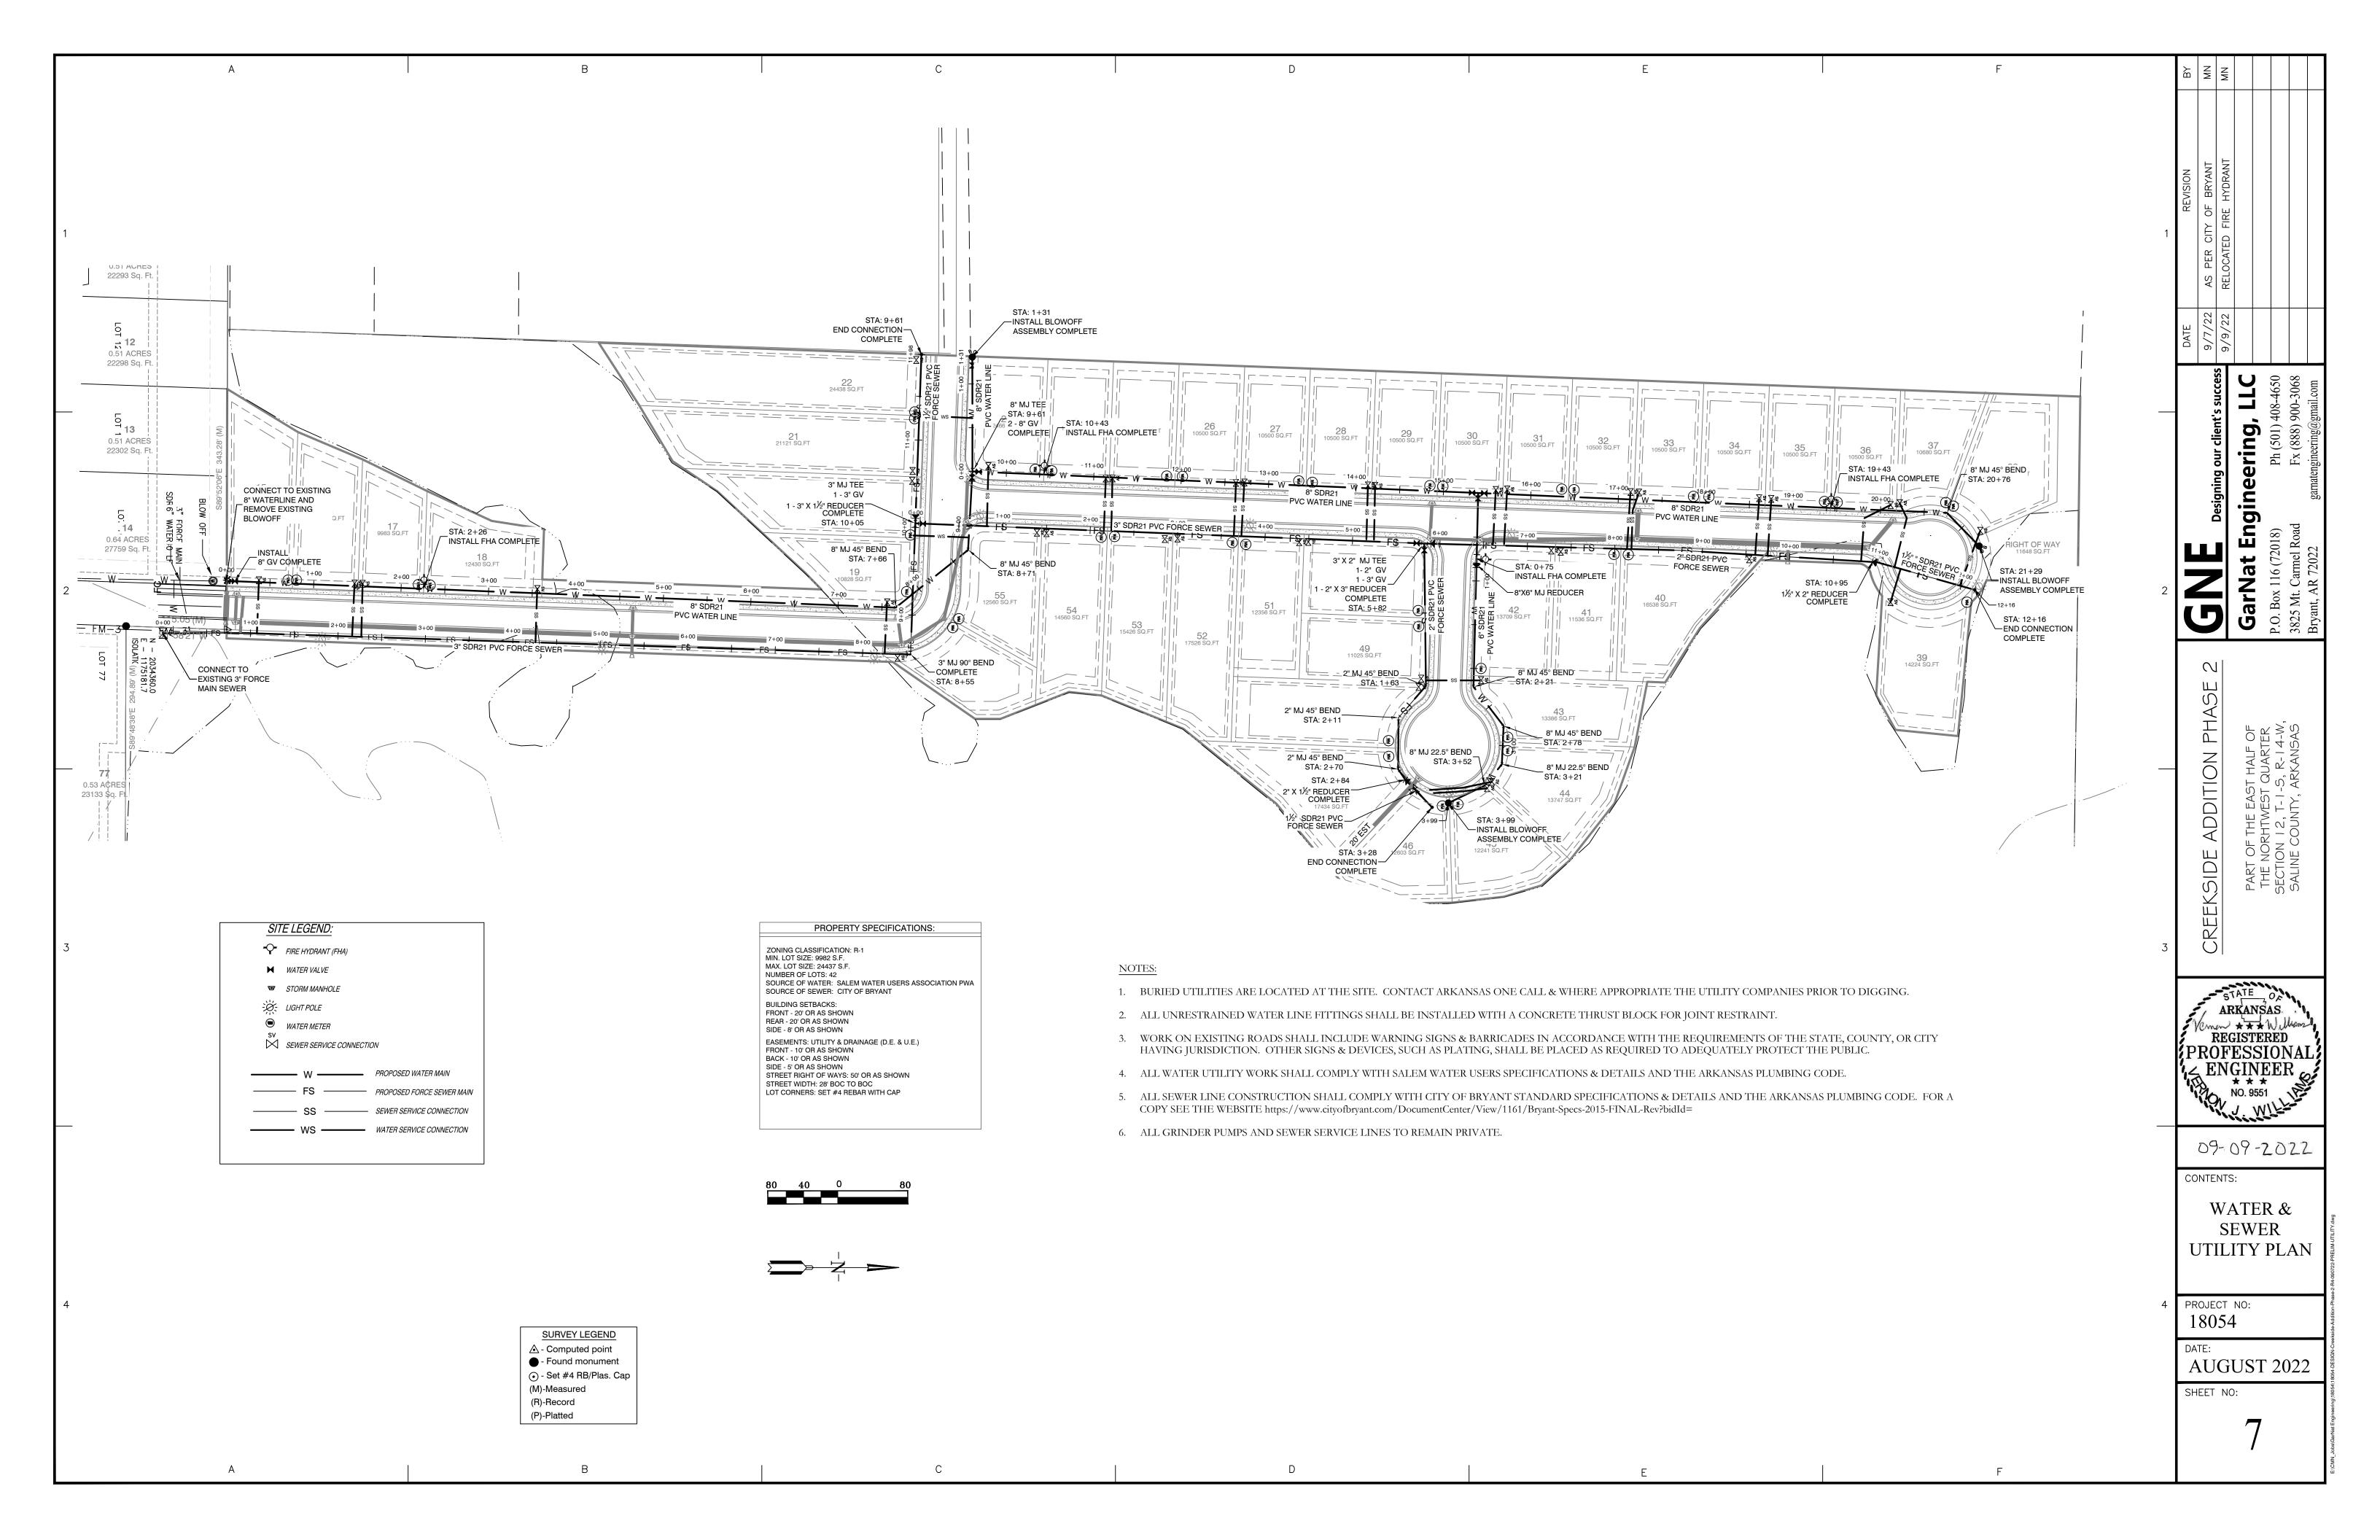

— GRATE NOT SHOWN


# INSTALL HEAVY DUTY FRP GRATING OVER OPEN TOP. ANCHOR GRATING TO WALLS WITH BOLTED CONNECTIONS WEIR OPENING


## OUTLET PIPE \_\_\_ OUTLET WEIR ELEV 1


## OUTLET STRUCTURE - WEIR 1 AND 3 PLAN VIEW

NOT TO SCALE


## OUTLET STRUCTURE - WEIR 1 AND 3 SECTION B-B

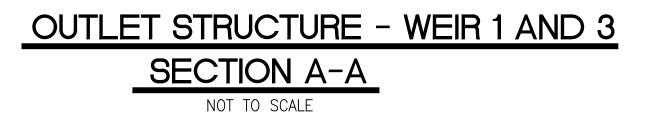

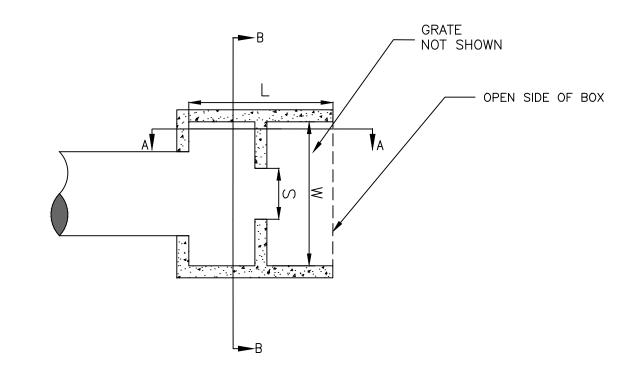

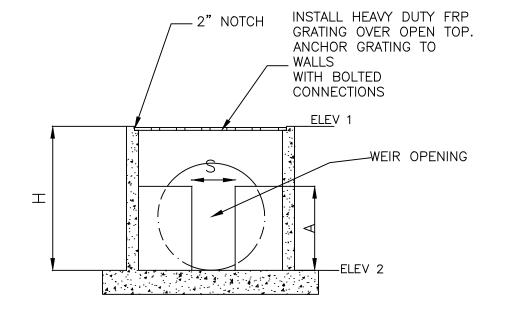

NOT TO SCALE

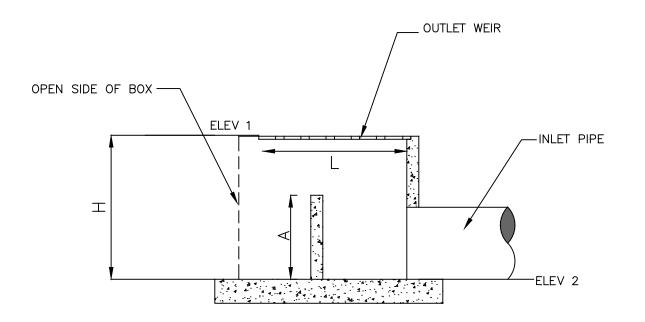

### OUTLET STRUCTURE - WEIR 2 PLAN VIEW



## OUTLET STRUCTURE - WEIR 2 SECTION A-A NOT TO SCALE

OUTLET STRUCTURE										
OUTLET STRUCTURE	L	W	Н	ELEV 1	ELEV 2	S	A	D		
WEIR #1	4'-0"	4'-0"	3'-11"	334.40	330.50	1'-3"	3'-0"	18"		
WEIR #2	4'-0"	4'-0"	3'-9"	333.71	330.00	0'-3"	2'-6"			
WEIR #3	4'-0"	4'-0"	4'-8"	330.85	326.22	1'-6"	2'-6"	18"		

#### **DETENTION OUTLET NOTES:**

- 1. ALL CONCRETE WALLS SHALL BE A MINIMUM OF 6" THICK & REINFORCED WITH #4'S @ 12"
- O.C. BOTH WAYS.
- 2. BOTTOM SLAB SHALL BE 12" THICK & REINFORCED WITH #4'S @ 12" O.C. BOTH

ADDITION DE

STATE OF ARKANSAS Verner \*\* Williams

08-10-2022


CONTENTS:


OUTLET STRUCTURE **DETAILS** 

PROJECT NO: 18054

AUGUST 2022

SHEET NO:

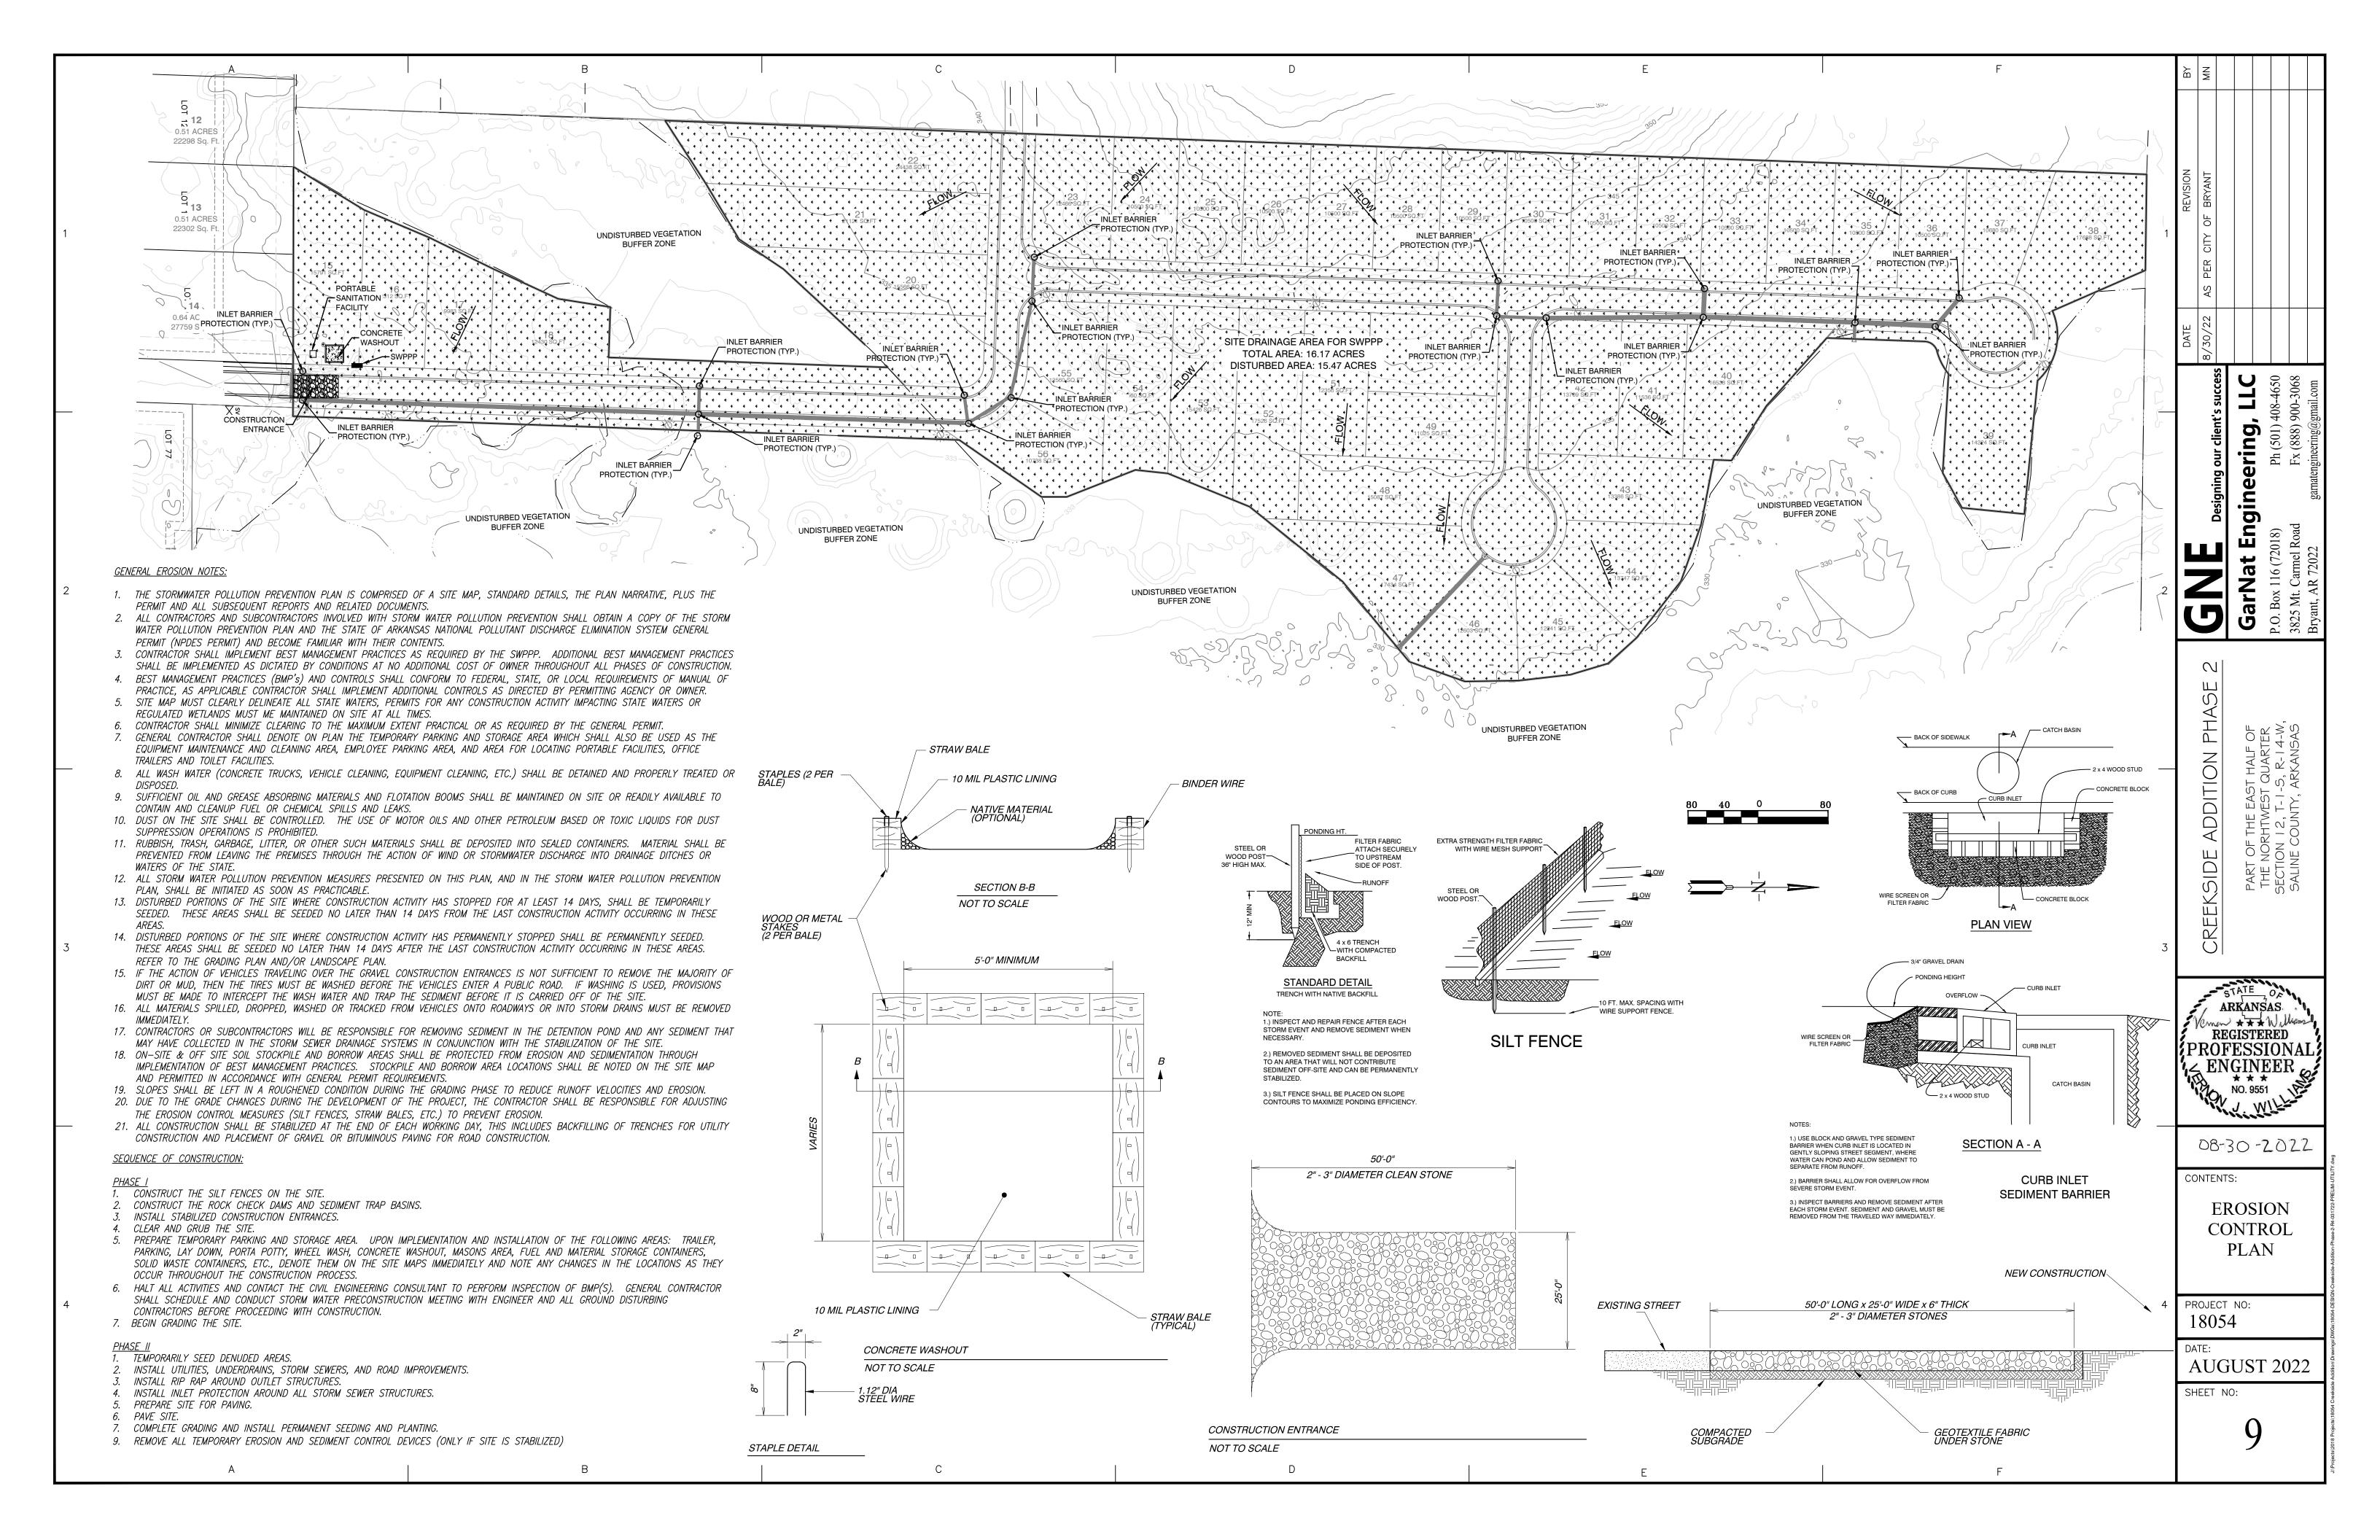

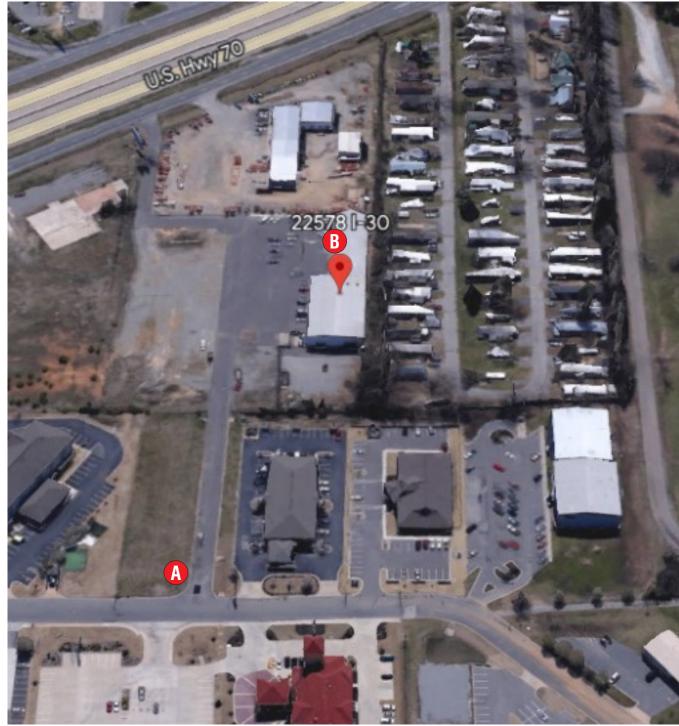

SIGN SCHEDULE

- igap A ground sign replacement face | one (1) req
- B WALL SIGN | ONE (1) REQ

#### **GENERAL NOTES**

- INSTALLER SHALL VERIFY WALL CONDITIONS IN THE FIELD
- TYPE, SIZE & QUANTITY OF FASTENERS TO BE DETERMINED
- ALL BOLT HOLES TO BE DRILLED OR PUNCHED
- ISOLATE ALL ALUMINUM FROM STEEL.

#### **NEW & REMODEL CONSTRUCTION**

ADEQUATE REHIND THE WALL BACKING AND ACCESS IS REQUIRED FOR THE INSTALLATION OF NEW SIGNAGE. CUSTOMER TO FORWARD APPROVED SIGNAGE DRAWINGS TO THE ON SITE CONTACT TO INSURE THAT THE REQUIRED PROVISIONS ARE MADE DURING CONSTRUCTION, PRIOR TO THE SIGN INSTALLATION.

#### IT IS THE RESPONSIBILITY OF THE INSTALLATION

CONTRACTOR TO PROVIDE ANY WALL SPACERS REQUIRED TO KEEP FIES WALL MATERIAL FROM BEING COMPACTED DURING INSTALLATION OF ANY MOUNTING BOLTS REQUIRED FOR SIGNAGE

#### **INSTALLER REQUIREMENTS**

ALL INSTALLATION (MOUNTING) HARDWARE AND SECONDARY WIRING COMPONENTS, CONDUIT & CONNECTORS, ETC ARE TO BE PROVIDED BY THE INSTALLATION CONTRACTOR

ALL WALL PENETRATIONS TO BE SEALED WITH SILICONE TO HELP PREVENT MOISTURE PENETRATION @ EXTERIOR LOCATIONS.

ANY DEVIATION FROM FEDERAL HEATH REQUIREMENTS MAY RESULT IN DAMAGE TO OR IMPROPER OPERATION OF SIGNAGE CAUSING DELAYS AND ADDITIONAL COSTS

#### **CUSTOMER TO PROVIDE** DEDICATED BRANCH CIRCUITS FOR **SIGNS ONLY PER NEC CODE 600.5**

ALL BRANCH CIRCUITS FOR SIGNS ALL BRANCH CIRCUITS FOR SIGNS MUST BE TOTALLY DEDICATED TO SIGNS (INCLUDING DEDICATED GROUND & NEUTRAL, PER CIRCUIT) AND SHALL NOT BE SHARED PROPERLY SIZED GROUND WIRE THAT CAN BE TRACED BACK TO THE BREAKER PANEL IS REQUIRED.

NUMBER AND SIZE OF CIRCUITS FOR EACH SIGN MUST MEET FEDERAL HEATH SIGN REQUIREMENTS.

LL ELECTRICAL SIGNS SHALL CONFORM TO HE REQUIREMENTS OF ARTICLE 600 OF THE N.E.C. AND U.L. 48 ALONG WITH OTHER APPLICABLE STATE & LOCAL CODE REQUIREMENTS. THIS INCLUDES PROPER

120V - 20 AMP (PRIMARY ELECTRICAL NUMBER AND SIZE OF CIRCUITS FOR EACH IGN TO MEET FEDERAL HEATH SIGN COMPAI

#### WARRANTY NOTICE

CERTAIN ELECTRICAL COMPONENTS OF SIGNS WILL FAIL PREMATURELY IF NOT SHUT OFF FOR A PERIOD OF TIME, ONCE EACH DAY. FOR BEST PERFORMANCE WE RECOMMEND THAT SIGNS BE CONNECTED TO AN AUTOMATIC CONTROLLING DEVICE SUCH AS AN EMERGENCY MANAGEMENT SYSTEM, TIME CLOCK OR PHOTO CELL TO CONTROL THE DAILY SHUT-OFF PERIOD. FAILURE TO FOLLOW THESE RECOMMENDATIONS CAN CAUSE DAMAGE TO ELECTRICAL COMPONENTS OF THE SIGN AND VOID THE WARRANTY. SOME DIMMING DEVICES WILL ADVERSELY AFFECT THE ELECTRICAL COMPONENTS OF THE SIGN AND VOID THE WARRANTY. SOME DIMMING DEVICES WILL ADVERSELY AFFECT THE ELECTRICAL COMPONENTS OF THE SIGN INTO STATEMENT. THE SIGN WITHOUT CONSULTATION WITH FEDERAL HEATH SIGN CO. WILL VOID THE WARRANTY.



**AERIAL SITE PLAN | NTS** 

## FEDERAL HEATH

PO BOX 153, Clinton, TN 37717

#### **Manufacturing Facilities:**

Delaware, OH - Euless, TX - Jacksonville, TX Racine, WI - Rochester Hills, MI Office Locations:

Revisions

Atlanta, GA - Brandon,FL - Indianapolis, IN Tunica, MS - Daytona Beach, FL - Delaware, OH Fuless, TX - Grafton, WI- Houston, TX Idaho Falls, ID - Louisville, KY - Ocean Ranch, CA Racine, WI - Rochester Hills, MI - San Antonio, TX Tampa, FL - Willowbrook, IL - Orlando, FL

Building Quality Signage Since 1901 Landlord Approval/Date

R1 5.18.23 R2 BW 6.12.23 Delete opt 1 & B1. olors Depicted In This Rendering May Not Match Actual Finished Materials. Refer To Product Samples For Exact Color Matc Client Approval/Date

JOHN BROWN Account Rep: KRISTI FRANKLIN Project Manage

CHRIS H CANTRELL

Underwriters Laboratories Inc.

Underwriters Laboratories Inc.

DELECTRICAL TO USE U.L. LISTED COMPONENTS AND SHALL MEET ALL N.E.C. STANDARDS ALL ELECTRICAL SIGNS ARE TO COMPLY WITH U.L. 48 AND ARTICLE 600 OF THE N.E.C. STANDARDS, INCLUDING THE PROPER GROUNDING AND BONDING OF ALL SIGNS. Project / Location:



STORE #0401 22578 I-30 BRYANT, AR 72022

23-79278-10 Job Number 05.17.23 Design Number:

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EXISTING | SIDE B | NTS





A PROPOSED | SIDE A | NTS





PO BOX 153, Clinton, TN 37717

Delaware, OH - Euless, TX - Jacksonville, TX Racine, WI - Rochester Hills, MI
Office Locations:

Atlanta, GA - Brandon,FL - Indianapolis, IN Tunica, MS - Daytona Beach, FL - Delaware, OH Euless, TX - Grafton, WI- Houston, TX Idaho Falls, ID - Louisville, KY - Ocean Ranch, CA Racine, WI - Rochester Hills, MI - San Antonio, TX Tampa, FL - Willowbrook, IL - Orlando, FL

Building Quality Signage Since 1901 Landlord Approval/Date

Revisions: R1 5.18.23 R2 BW 6.12.23 Delete opt 1 & B1. olors Depicted In This Rendering May Not Match Actual Finished Materials. Refer To Product Samples For Exact Color Matc

JOHN BROWN KRISTI FRANKLIN CHRIS H CANTRELL

Underwriters
Laboratories Inc.

ALL ELECTRICAL SIGNS ARE TO COMPLY WITH U.L. 48 AND ARTICLE 600 OF THE N.E.C. STANDARDS. INCLUDING THE PROPER GROUNDING AND BONDING OF ALL SIGNS.

Project / Location:



STORE #0401 22578 I-30 BRYANT, AR 72022

23-79278-10 05.17.23 Design Number:

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SCALE: 1/2" = 1'-0"


TW0 (2) REQ

32.04 SQ. FT

#### **SCOPE OF WORK:**

REMOVE EXISTING SIGN FACE PANEL. EXISTING CABINET AND RETAINERS TO BE PAINTED GRAY AS NOTED

FACE TO BE BLACK ALUMINUM WITH DIGITALLY PRINTED GRAPHICS ON BOTH SIDES AS SHOWN

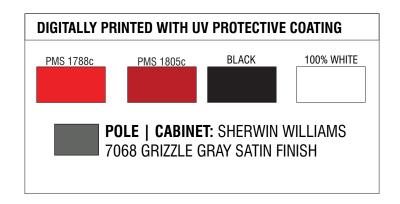



PO BOX 153, Clinton, TN 37717

Manufacturing Facilities:
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Office Locations:

ata GA - Brandon FL - Indiananolis

Atlanta, GA - Brandon,FL - Indianapolis, IN Tunica, MS - Daytona Beach, FL - Delaware, OH Euless, TX - Grafton, WI- Houston, TX Idaho Falls, ID - Louisville, KY - Ocean Ranch, CA Racine, WI - Rochester Hills, MI - San Antonio, TX Tampa, FL - Willowbrook, IL - Orlando, FL

Building Quality Signage Since 1901 Landlord Approval/Date

R1 5.18.23
R2 BW 6.12.23 Delete opt 1 & B1.

R3 CHC Update Sign B to CCWS-L-26
Colors Depicted In This Rendering May Not Match Actual Finished Materials. Refer To Product Samples For Exact Color Match.
Client Approval/Date:
Landlord Approval/Date:

Account Rep: JOHN BROWN

Project Manager: KRISTI FRANKLIN

Drawn By: CHRIS H CANTRELL

Drawn By:

CHRIS H CANTRELL

Laboratories Inc.

ALL ELECTRICAL SIGNS ARE TO COMPTOWNENTS AND SHALL MEET ALL N.E.C. STANDARDS.

ATTICLE 600 OF THE N.E.C. STANDARDS. INCLUDING THE PROPER GROUNDING AND BONDING OF ALL SIGNS.

Project / Location:



STORE #0401 22578 I-30 BRYANT, AR 72022 
 Job Number:
 23-79278-10

 Date:
 05.17.23

 Sheet Number:
 3 Of 8

 Design Number:
 23-79278-10 R3

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#### **LEAVE ENTERPRISE SIGN- DO NOT REMOVE**



**EXISTING | SCALE: 3/32" = 1'-0"** 

SCOPE OF WORK: REMOVE EXISTING LOGO WALL SIGN (SERVICE KING)- CLEAN WALL, FILL HOLED WITH MATCHING SILICONE AND PAINT IMMEDIATE FOOTPRINT. INSTALL NEW SIGN. CHANNEL LETTERSET (COLLISION REPAIR CENTER) - REMOVE CHANNEL LETTERSET AND RACEWAY. CLEAN WALL, FILL HOLES WITH MATCHING SILICONE AND PAINT IMMEDIATE FOOTPRINT.



**PROPOSED | SCALE: 3/32" = 1'-0"** 



PO BOX 153, Clinton, TN 37717

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Tunica, MS - Daytona Beach, FL - Delaware, OH Euless, TX - Grafton, WI- Houston, TX Idaho Falls, ID - Louisville, KY - Ocean Ranch, CA Racine, WI - Rochester Hills, MI - San Antonio, TX Tampa, FL - Willowbrook, IL - Orlando, FL

olors Depicted In This Rendering May Not Match Actual Finished Materials. Refer To Product Samples For Exact Color Matc Client Approval/Date Building Quality Signage Since 1901 Landlord Approval/Date

Revisions

R1 5.18.23

R2 BW 6.12.23 Delete opt 1 & B1.

JOHN BROWN Account Rep: KRISTI FRANKLIN Project Manage CHRIS H CANTRELL Underwriters necessary Laboratories Inc.


| Underwriters | Property | Components and shall meet All N.E.C. STANDARDS ALL ELECTRICAL SIGNS ARE TO COMPLY WITH U.L. 48 AND ARTICLE 600 OF THE N.E.C. STANDARDS, INCLUDING THE PROPER GROUNDING AND BONDING OF ALL SIGNS.

Project / Location:


STORE #0401 22578 I-30 BRYANT, AR 72022

23-79278-10 Job Number 05.17.23 Design Number:

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NOTE: BACKGROUND PANEL WILL BE SEAMED AT 12'-0" INCREMENTS

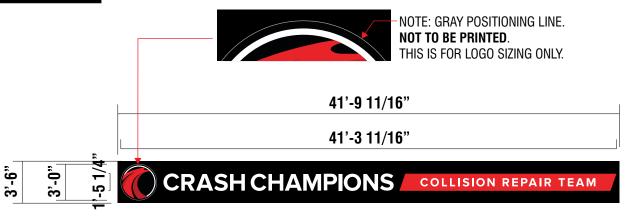

### INTERNALLY ILLUMINATED LOGO & LETTERSET ON PANEL | ONE (1) REQ

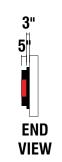SCALE: 1/8" = 1'-0"

#### SCOPE OF WORK:

CHANNEL LOGO: 5" DEEP .040 PRE-FINISHED ALUMINUM LOGO CABINET. SATIN BLACK RETURNS & TRIMCAP 3/16" WHITE ACRYLIC FACE. DIGITAL PRINT OVERLAY, BLACK PRINTED BORDER TO BE ON FACE AND RUN UNDER TRIMCAP. WHITE LEDS. INSTALL FLUSH TO BACKER.

CRASH CHAMPIONS CHANNEL LETTERS: 5" DEEP .040 PRE-FINISHED ALUMINUM CHANNEL LETTERS. SATIN BLACK RETURNS AND TRIM CAP. 3/16" WHITE ACRYLIC FACE. WHITE LEDS. INSTALL FLUSH TO BACKER.

COLLISION REPAIR TEAM TAG LINE CABINET: 5" DEEP .040 PRE-FINISHED ALUMINUM CHANNEL TAG LINE. SATIN RED RETURNS AND TRIM CAP. 3/16" WHITE ACRYLIC FACE WITH DIGITAL PRINT OVERLAY PMS 1788C. COPY WILL REVERSE OUT WHITE. INTERNAL WHITE LEDS. CABINET INSTALL FLUSH TO BACKER.

**ALUMINUM BACKER:** 3" DEEP ALUMINUM BACKER PANEL/WIREWAY TO BE PAINTED BLACK PC AND INSTALLS FLUSH TO WALL

### 2. ACM BACKS / LETTER LOCKED TO RETURNS 4. TRIM CAP TO BE 1" PRE-FINISHED JEWELITE CHEMICALLY BONDED TO FACES (SEAMS AT THE TOP) LOGO: BLACK TRIM CAP

5. WHITE LED MODULES

**CRASH: BLACK TRIM CAP** 

**CHAMPIONS: BLACK TRIM CAP** 


6. RIGID PASS-THRU FOR LOW VOLTAGE LED WIRING

**COLLISION REPAIR TEAM CABINET: RED TRIM CAP** 

**FABRICATION TO BE AS NOTED TO MATCH** 

**CUSTOMER SIGN PROGRAM AND EXISTING SITES** 

- 7. 1/4" WEEP HOLES WITH LIGHT BAFFLES (EXTERIOR APPLICATIONS ONLY)
- 8. ETL COMPLIANT ENCLOSURE FOR LED POWER SUPPLIES +/- 18"L X 7"H. REMOTE LOCATED
- 9. DISCONNECT SWITCH
- 10. LED POWER SUPPLIES
- 11. PRIMARY ELECTRICAL
- 12. CORROSION RESISTANT FASTENERS PER CONDITIONS
- 13. ALUM. BACKGROUND PANEL/WIREWAY

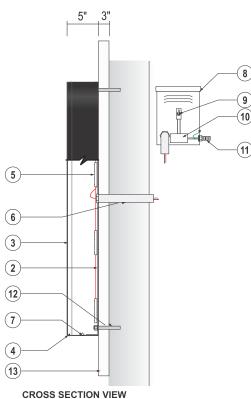

SCALE: NTS



#### DIGITALLY PRINTED COLORS

DP-2 PRINT TO MATCH PMS 1788C ON 3M WHITE TRANSLUCENT VINYL

PRINT TO MATCH PMS 1805C ON 3M WHITE TRANSLUCENT VINYL

PRINT TO MATCH BLACK PC ON 3M WHITE TRANSLUCENT VINYL

### **INSTALLER NOTE: INSTALLER RESPONSIBLE TO CHOOSE THE**

APPROPRIATE FASTENERS PER CONDITIONS

Total: T.B.D. Amps

# of 120V, 20A Circuits Reg'd T.B.D.

ALL BRANCH CIRCUITS SHALL BE DEDICATED TO SIGNS (INCLUDING GROUND AND NEUTRAL) AND SHALL NOT BE SHARED WITH OTHER LOADS

REFER TO PAGE 1 FOR ADDITIONAL **ELECTRICAL AND** INSTALLATION INFORMATION & REQUIREMENTS

INSTALLATION OF THIS SIGN SHALL CONFORM TO ARTICLE 600 OF THE NEC, UL 48 AND OR OTHER APPLICABLE LOCAL CODES, INCLUDING THE PROPER GROUNDING AND BONDING OF THE SIGN

THE LOCATION OF THE DISCONNECT SWITCH, AFTER INSTALLATION SHALL COMPLY WITH ARTICLE 600.6(A) OF THE NEC




PO BOX 153, Clinton, TN 37717


### **Manufacturing Facilities:**

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Building Quality Signage Since 1901 Landlord Approval/Date





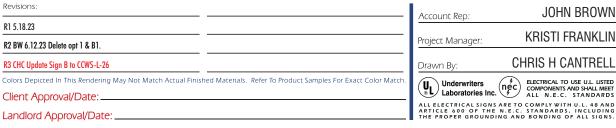

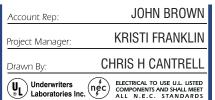BRYANT, AR 72022

Job Number:		23-792	78-10
Date:		05	.17.23
Sheet Number:	5	Of	8
Design Number:	23	-79278-	10 R3

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#### THE FOLLOWING SIGNS ARE TYPICAL ON ALL SITES

INSTALL AGENT TO REMOVE SIGN(S), REMOVE HARDWARE AND TURN INTO THE FRONT DESK IF SIGNS ARE STILL ON SITE





Revisions

R1 5.18.23



Production Board Month of Jan Metrics That I atter 100 100 89 923 100 124 923 951 95.8 104,000 NED Tuku Branlley 719-243-5352

**RATES SIGN** 

PRODUCTION BOARDS

**ANY SANDWICH BOARDS** 



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R2 BW 6.12.23 Delete opt 1 & B1. olors Depicted In This Rendering May Not Match Actual Finished Materials. Refer To Product Samples For Exact Color Mat Building Quality Signage Since 1901 Landlord Approval/Date

JOHN BROWN Account Rep: KRISTI FRANKLIN Project Manager CHRIS H CANTRELL Underwriters Laboratories Inc. ALL ELECTRICAL SIGNS ARE TO COMPLY WITH U.L. 48 AND ARTICLE 600 OF THE N.E.C. STANDARDS, INCLUDING THE PROPER GROUNDING AND BONDING OF ALL SIGNS.

Project / Location:




STORE #0401 22578 I-30 BRYANT, AR 72022


23-79278-10 Job Number: 05.17.23 Sheet Number: 23-79278-10 R3 Company, LEC G. . . authorized agent. ©FHSC Design Number:

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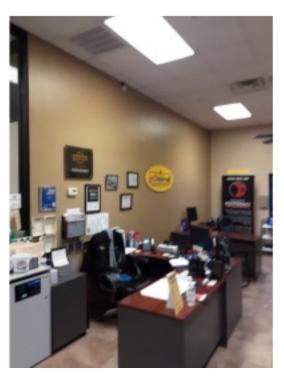






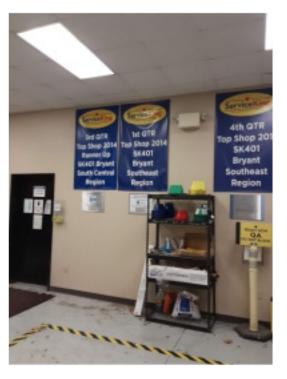

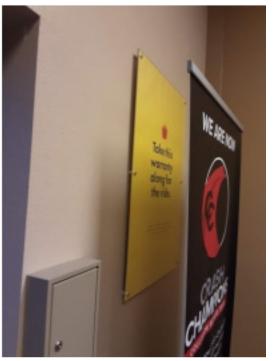Revisions:







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STORE #0401 22578 I-30 BRYANT, AR 72022

23-79278-10 Job Number: 05.17.23 Design Number:

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#### **SCOPE: REMOVAL ONLY**

WALL SIGNS- PRO MODEL, CROWN LOGO OR AREA ID'S LIKE REFINISHING DEPT, BODY, SANITATION STATION, ETC. REMOVE SIGNS AND FILL HOLES WITH WATER RESISTANT SILICONE IF ON A WALL.

- -IF ON A CHAIN, REMOVE CHAINS ALONG WITH SIGN.
- -IF ON A POLE AND BOLTED DOWN REMOVE THE POLE.
- -IF IT IS A MOVABLE SIGN THE KIND WITH THE BIG BASE THAT GETS FILLED WITH WATER OR SAND, WE WILL WANT TO RECOMMEND REMOVAL OF THE ENTIRE SIGN.
- -IF SIGNS ARE IN A GRASSY AREA, CUT POLE TO GRADE AND COVER WITH DIRT.










Revisions:

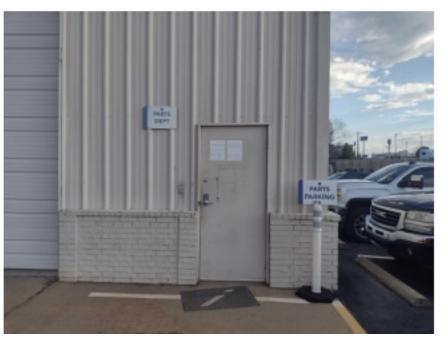



Delaware, OH - Euless, TX - Jacksonville, TX
Racine, WI - Rochester Hills, MI
Office Locations:
Office Adapts | Indiagonalis IN

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Building Quality Signage Since 1901 Landlord Approval/Date:

R1 5.18.23

R2 BW 6.12.23 Delete opt 1 & B1.

R3 CHC Update Sign B to CCWS-L-26

Colors Depicted In This Rendering May Not Match Actual Finished Materials. Refer To Product Samples For Exact Color Match Approval/Date:

Landlord Approval/Date:

Account Rep:

Project Manager:

CHRIS H CANTRELL

Drawn By:

CHRIS H CANTRELL

Of the Components and Shall Meet all N.E.C. STANDARDS, INCLUDING THE PROPER GROUNDING AND BONDING OF ALL SIGNS.

Project / Location:



STORE #0401 22578 I-30 BRYANT, AR 72022 
 Job Number:
 23-79278-10

 Date:
 05.17.23

 Sheet Number:
 8 Of 8

 Design Number:
 23-79278-10 R3

23-79278-10

23-79278-10


05.17.23

8 of 8

23-79278-10 R3


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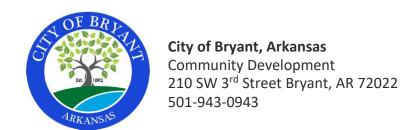
Sign A Size: 174"w x 18"h

Building Face Size: 800"w x 250"h

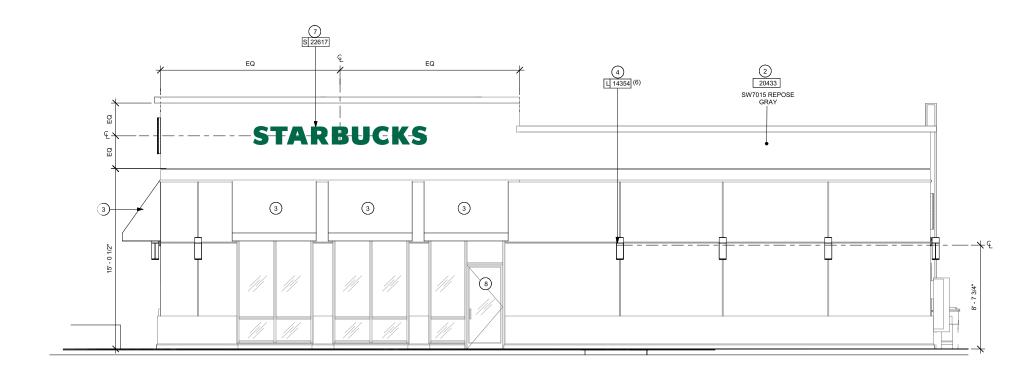

Sign A Size: 36" x 36"

Building Face Size: 320"w x 250"h

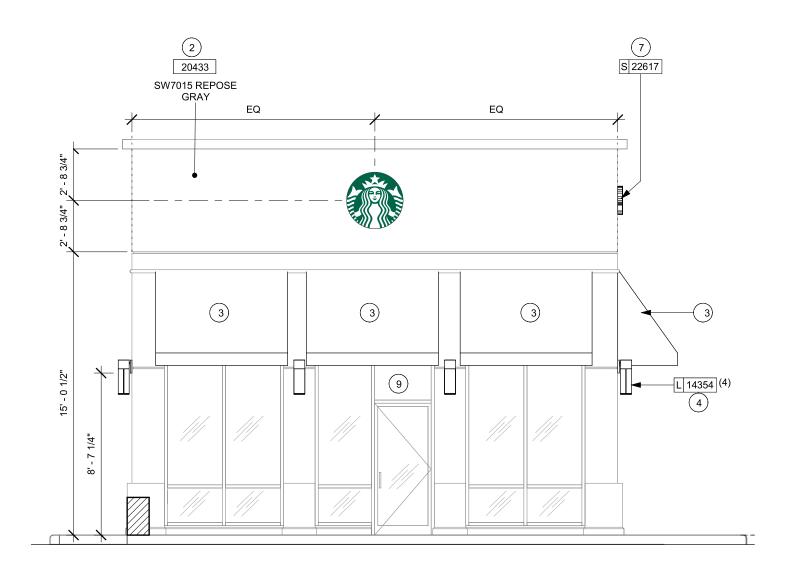

### **SIGN PERMIT APPLICATION**

Applicants are advised to read the Sign Ordinance prior to completing and signing this form.

The Sign Ordinance is available at <a href="https://www.cityofbryant.com">www.cityofbryant.com</a> under the Planning and Community

Development tab.


Developi	Herre tab.	
Date:9/27/2023		Note: Electrical Permits may be Required, Please contact the Community Development Office for more information.
Sign Co. or Sign Owner	Property Owner	
NameSign Installation Group, Inc. Dba National Signs and Service	Name Murphy Oil US	SA
Address Po Box 240	Address 200 E Peac	h St
City, State, Zip Fate, Tx 75132		rado, AR
Phone 972-772-4901		
Email Address pauline@national signs and service.net	Email Address	
GENERAL INFORMATION  Name of Business Murphy USA  Address/Location of sign 403 Bryant Avenue		
Zoning Classification		
Please use following page to provide details on the provided on this application, a Site Plan showing please property is required to be submitted. Renderings of required to be submitted with the application. A the collected at the time of permit issuance. According special sign permit request shall be one hundred do required by Sign Administrator.	lacement of sign(s) and of the sign(s) showing the hirty-five dollar (\$35) per to the Sign Ordinance a	any existing sign(s) on the se correct dimensions is also r sign payment will be a fee for and sign variance or
READ CAREFULLY BEFORE SIGNING		
Sandra Pauline Wright do hereby certify	y that all information containe	ed within this application is true
and correct. I fully understand that the terms of the Sign Ordinal signs must fully comply with all terms of the Sign Ordinance rega	nce supersede the Sign Admir	nistrator's approval and that all

authorized by the owner of the property and that I am authorized by the property owner to make this application. I understand

that no sign may be placed in public right of way. I understand that I must comply with all Building and Electrical Codes and that it is my responsibility to obtain all necessary permits.

# Use table below to enter information regarding each sign for approval. Please use each letter to reference each sign rendering.

SIGN	<b>Type</b> (Façade, Pole, Monument, other)	<b>Dimensions</b> (Height, Length, Width)	Sqft (Measured in whole as rectangle)	_	t of Sign rom lot surface)	Column for Admin Certifying Approval
				Top of Sign	Bottom of Sign	
Α	Canopy Sign Murphy USA (N)	2'-0" x 16'-9 1/4"	33.54	18'-9"	14'-6"	
В	Canopy Sign Diesel (N)	4'-3 1/4" x 9'-10"	42.00	18'-9"	14'-6"	
С	Canopy Sign Unleaded (N)	4'-3 1/4" x 9'-10"	42.00	18'-9"	14'-6"	
E	Canopy Sign Unleaded (W)	2'-10 1/8" x 6'-2"	17.54	18'-9"	14'-6"	
F	Canopy Sign Diesel (W)	2'-10 1/8" x 6'-2"	17.54	18'-9"	14'-6"	
G	Canopy Sign Unleaded (S)	3'-7 1/8" x 8'-1"	29.05	18'-9"	14'-6"	
Н	Canopy Sign Murphy USA (S)	2'-0" x 16'-9 1/4"	33.54	18'-9"	14'-6"	
I	Canopy Sign Unleaded (E)	4'-3 1/4" x 9'-10"	42.00	18'-9"	14'-6"	
J	Canopy Sign Diesel (E)	4'-3 1/4" x 9'-10"	42.00	18'-9"	14'-6"	

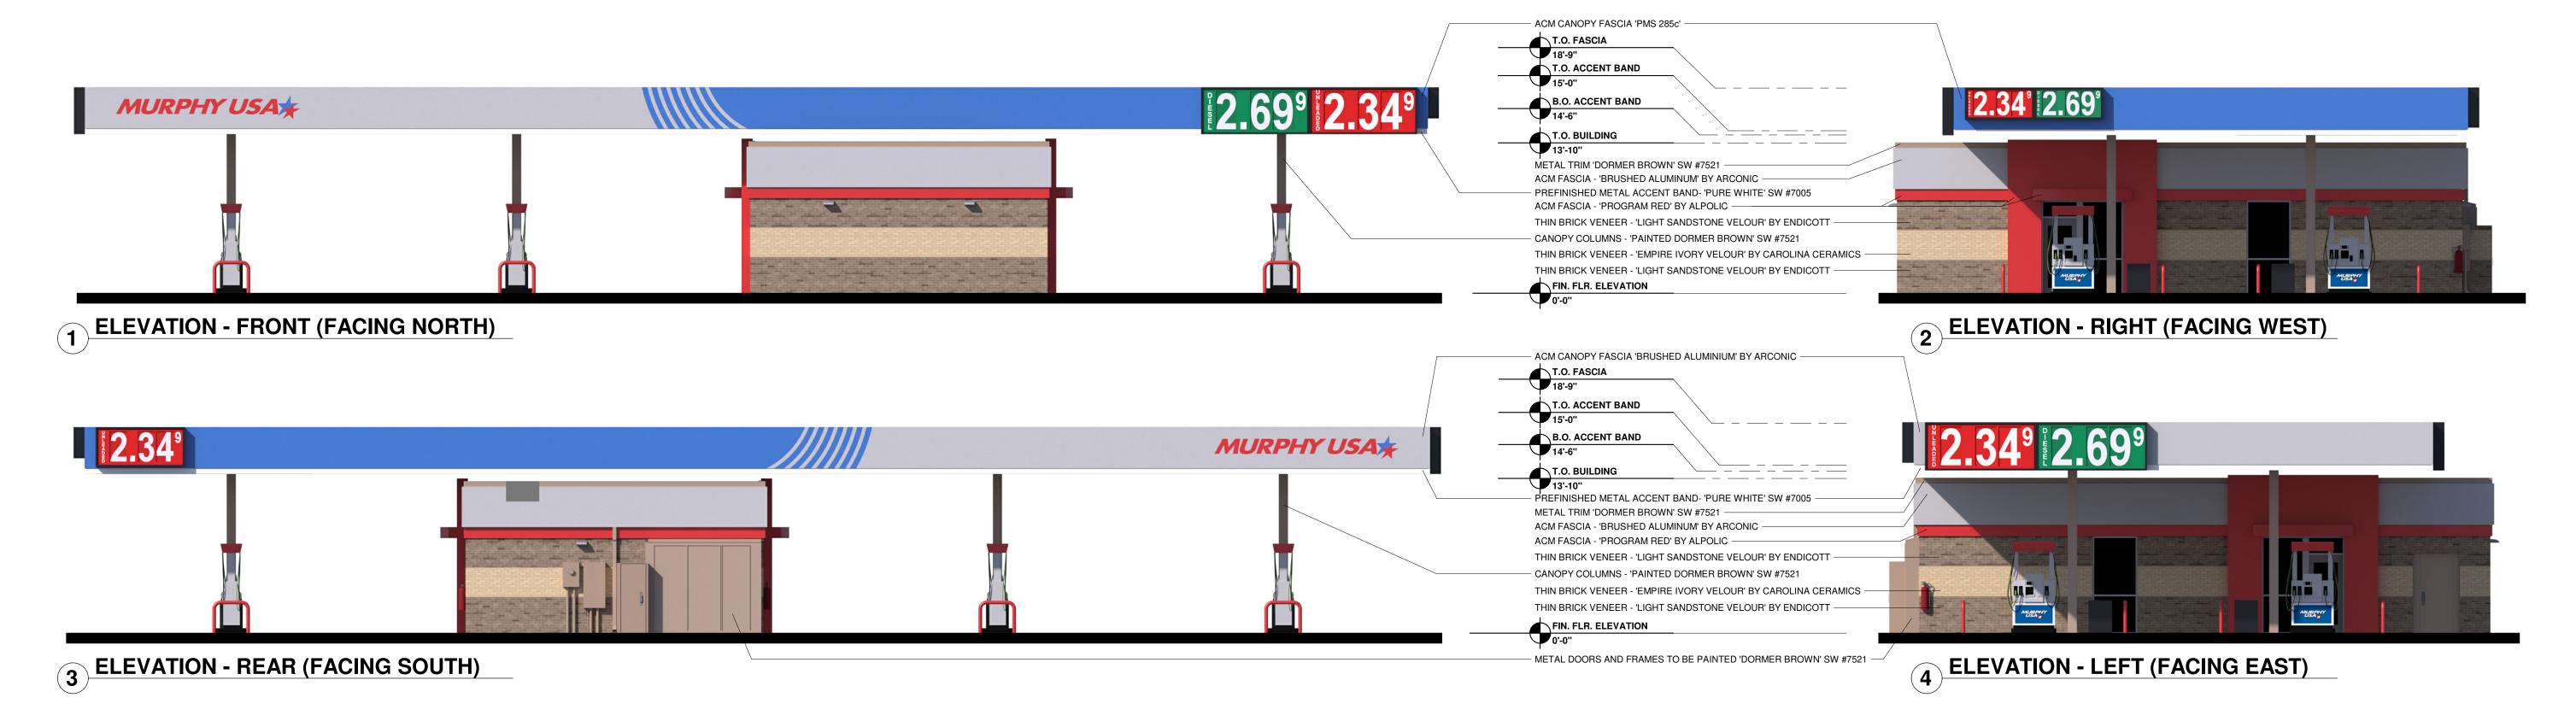






# 5 TRASH ENCLOSURE

SIGNAGE	COL	OR	CHART		
	BUILDING - ROUTED SIGNS FURNISHED AND NSTALLED BY FMS				
MUDDUVUGA	BLUE	PANT	MAN BLUE, ONE 287 BLUE 330-87 ROYAL BLUE		
STAR LOGO	RED	PANT	GRAM RED, ONE 485 RED 630-43 RED		
	WHITE	EAST	MAN WHITE		
CANOPY - PRICE SIGNS FURNISHED AND INSTALLED BY THE SIGN VENDOR					
UNLEADED	RED		3M 3632-73		
	WHIT	Έ	3M 3632-20		
	DIGIT	-	RED/WHITE		
	CABI	NET	BLACK		
DIESEL	GREE	EN	3M 3632-26		
	WHIT	Έ	3M 3632-20		
	DIGIT	•	GREEN/WHITE		
	CABI		BLACK		

CANOPY SIGNS :	QTY.	HEIGHT	WIDTH	AREA S.F.	TOTAL S.F.
MURPHY USA CANOPY LOGO SIGN	2	GRAPHIC	CAREA	33.54	67.08
LARGE CANOPY PRICE SIGN (UNL/DSL)	4	51.25"	118.00"	42.00	168.00
MEDIUM CANOPY PRICE SIGN (UNL)		43.13"	97.00"	29.05	29.05
SMALL CANOPY PRICE SIGN (UNL/DSL)	2	34.13"	74.00"	17.54	35.08
CANOPY SIGNS TOTAL SIGNAGE :				299.21 S.F.	
TOTAL SIGN AREA :			299.21 S.F.		





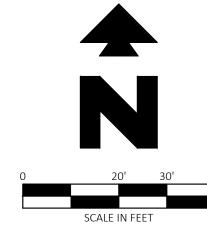





CEI ENGINEERING ASSOCIATES, INC. 3030 LBJ FREEWAY, SUITE 920 DALLAS, TX 75234 PHONE: (972) 488-3737 FAX: (972) 488-6732


MURPHY

USA

MURPHY

THESE DRAWINGS DO NOT INCLUDE COMPONENTS FOR CONSTRUCTION SAFETY

THE LOCATION OF EXISTING UNDERGROUND UTILITIES ARE SHOWN IN AN APPROXIMATE WAY ONLY. THE CONTRACTOR SHALL DETERMINE THE EXACT LOCATION OF ALL EXISTING UTILITIES BEFORE COMMENCING WORK. HE AGREES TO BE FULLY RESPONSIBLE FOR ANY AND ALL DAMAGES WHICH MIGHT BE OCCASIONED BY HIS FAILURE TO EXACTLY LOCATE AND PRESERVE ANY AND ALL UNDERGROUND UTILITIES.

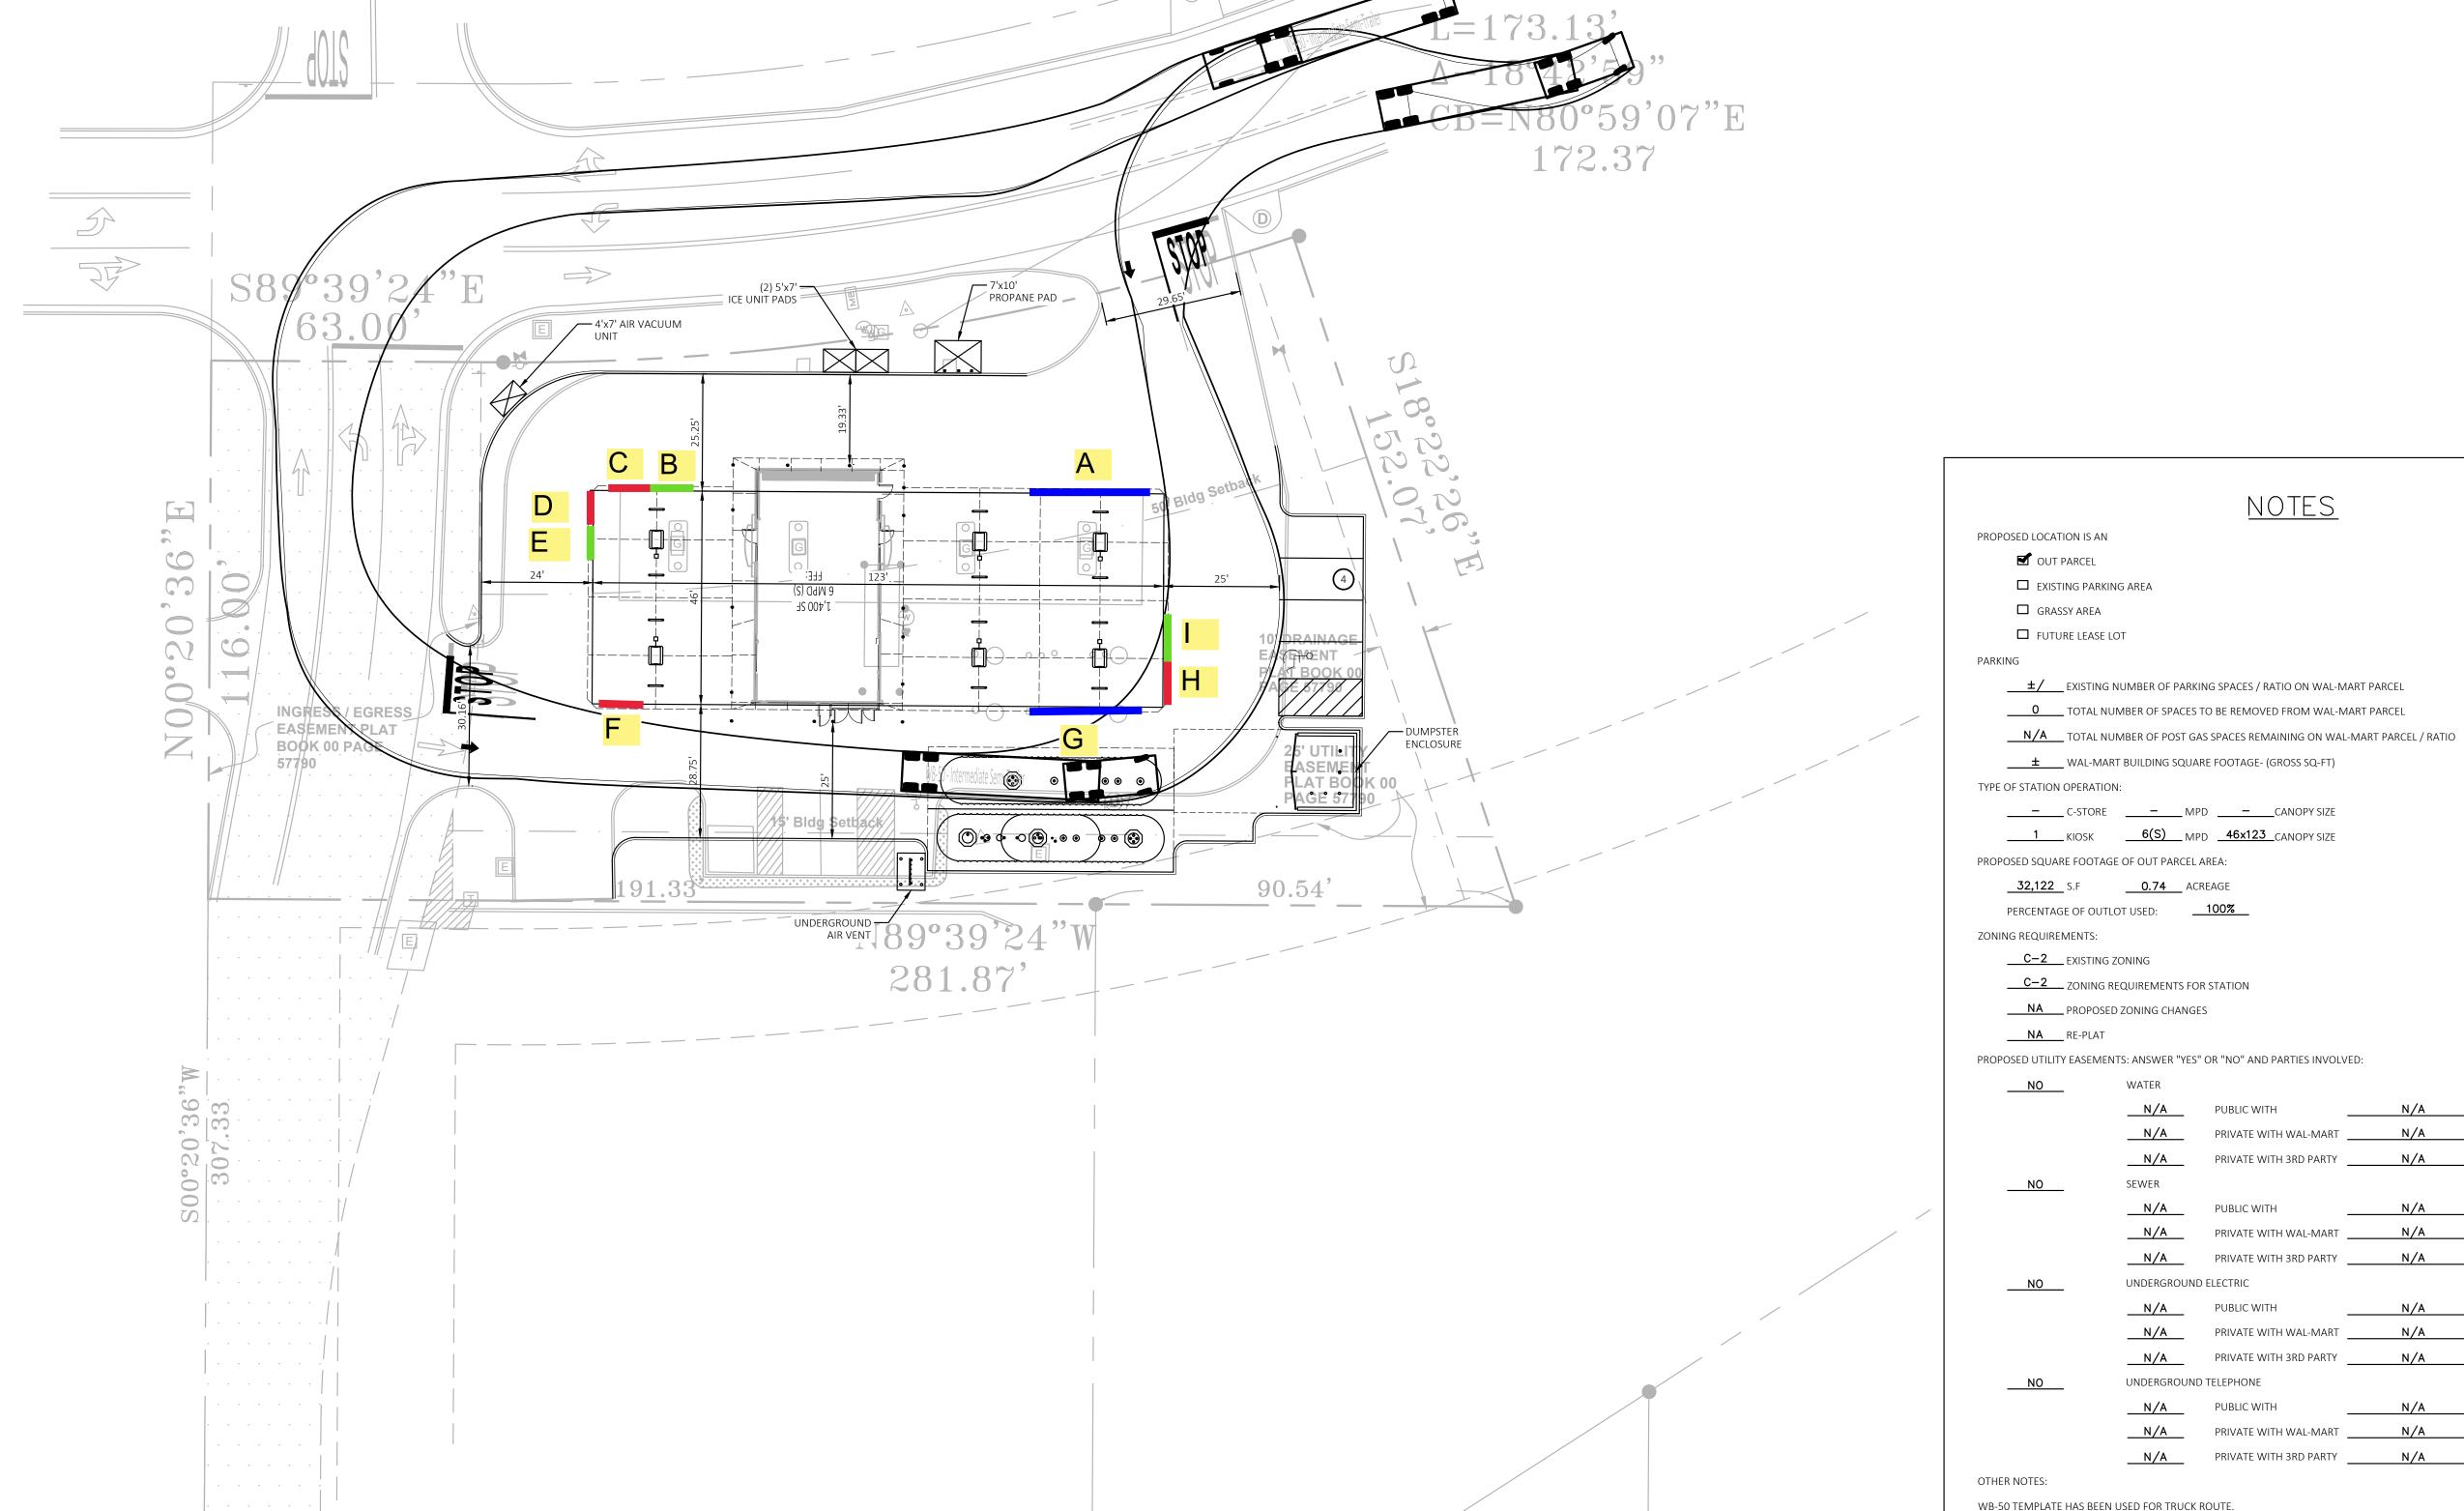

	******			
	N/A	PUBLIC WITH	N/A	
	N/A	PRIVATE WITH WAL-MART	N/A	
	N/A	PRIVATE WITH 3RD PARTY	N/A	
NO	SEWER			
	N/A	PUBLIC WITH	N/A	
	<u>N/A</u>	PRIVATE WITH WAL-MART	N/A	
	N/A	PRIVATE WITH 3RD PARTY	N/A	
NO	UNDERGROUN	D ELECTRIC		
	<u> N/A</u>	PUBLIC WITH	N/A	
	N/A	PRIVATE WITH WAL-MART	N/A	
	N/A	PRIVATE WITH 3RD PARTY	N/A	
NO	UNDERGROUN	D TELEPHONE		
	N/A	PUBLIC WITH	N/A	
	N/A	PRIVATE WITH WAL-MART	N/A	
	N/A	PRIVATE WITH 3RD PARTY	N/A	
OTHER MOTEC				

SHEET NUMBER

PROFESSIONAL OF RECORD

RKN

3/9/2023

PROJECT MANAGER

CEI PROJECT NUMBER

DESIGNER

REVISION

© 2023 CEI ENGINEERING ASSOCIATES, INC.

EXISTING LEGEND

STORM DRAIN

— OHE — OVERHEAD ELECTRIC

PROPOSED LEGEND

---  $\chi''G$  --- GAS

EAST OR ELECTRIC

SOUTH OR SEWER

UNDERGROUND

**WEST OR WATER** 

PROPERTY LINE

—— OHE&T —— OVERHEAD ELECTRIC AND TELEPHONE

PROPERTY LINE/RIGHT OF WAY LINE

DETAIL 01A

(PER ARCH, PLANS)

RIGHT OF WAY LINE

NORTH

OVERHEAD

TELEPHONE



—— OHT —— OVERHEAD TELEPHONE

--- UGE --- UNDERGROUND ELECTRIC

*UGT — UNDERGROUND TELEPHONE* 

TREE INFO

.5 = DIAMETER OF TRUNK IN FEET

11 = CANOPY DIAMETER IN FEET

50.5 = ELEVATION AT BASE OF TREE

10 = HEIGHT OF TREE IN FEET

— UGE&T — UNDERGROUND ELECTRIC AND TELEPHONE

— OHTV — OVERHEAD TV

—— X"SS —— SANITARY SEWER

--- UGTV --- UNDERGROUND TV

.5-10-11 50.5

**Solutions for Land and Life** 

> CEI ENGINEERING ASSOCIATES, INC. 3108 SW REGENCY PKWY BENTONVILLE, AR 72712 PHONE: (479) 273-9472

FAX: (479) 273-0844

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05/09/2023 CRM

PROFESSIONAL OF RECORD PROJECT MANAGER ASM DESIGNER CEI PROJECT NUMBER 33155 5/9/2023 DATE REVISION REV-0

SITE PLAN

SHEET NUMBER

SITE BENCHMARK chmark #1: A 5/8" rebar with cap CEI set northwes of the subject area, 175' northwest of a sewer manhole found south of the subject area, and 119' northwest of a fire hydrant found est of said access drive. Northing: 2024315.13' Easting: 1163448.93' Benchmark #2: A 5/8" rebar with cap CEI set north of the ubject area, 25' northwest of a drainage manhole found north of Bryant Ave. and 71' northwest of a drainage manhole found south of Bryant Ave.

Northing: 2024393.20' Easting: 1163694.72' Elevation: 417.55' SEE ARCHITECTURAL PLANS FOR EXACT LOCATIONS AND DIMENSIONS OF PORCHES, RAMPS, VESTIBULE, SLOPED PAVING, TRUCK DOCKS, BUILDING ITILITY ENTRANCE LOCATIONS AND PRECISE BUILDING DIMENSIONS.

ZONING: C-2 (HIGHWAY COMMERCIAL)

BUILDING SETBACKS:				
FRONT (STREETS): SIDE: REAR:	REQUIRED 0' 0' 15'	PROVIDED O' O' 15'		

CONTRACTOR SHALL BE RESPONSIBLE FOR AND HIRE A ARKANSAS REGISTERED LAND SURVEYOR TO ESTABLISH PROPERTY CORNERS, CANOPY, ETC. AS REQUIRED FOR CONSTRUCTION LAYOUT

CURB TO PREVENT THE VEHICLES STRIKING THE LIGHT POLE OR HANDICAP PARKING SIGN. CONTRACTOR TO ENSURE THAT THE CONSTRUCTION FENCE

NCOMPASSES THE ENTIRE WORK AREA. (RE: DETAIL 2F)

CONTRACTOR TO ENSURE THE LIGHT POLE AND HANDICAP

PARKING SIGNS ARE AT LEAST 2' FROM THE BACK OF THE

SEE SHEET C-4.1 FOR BUILDING ROOF AND CANOPY DRAINAGE

THE MURPHY STATION WILL NOT DROP THE WAL-MART GREEN

3. GC TO ENSURE THAT TRAFFIC THROUGH MAIN WAL-MART DRIVES

ACTIVITIES. ENSURE A MINIMUM TEMPORARY LANE WIDTH OF 10'

CONSTRUCTION FENCE EXTEND INTO THE DRIVE MORE THAN 2'

4. IF DEMOLITION OR CONSTRUCTION ON SITE WILL INTERFERE WITH

THE WAL-MART TRAFFIC FLOW OR ADJACENT PROPERTY OWNER'S

TRAFFIC FLOW THE CONTRACTOR SHALL COORDINATE WITH THE

PROPERTY OWNER. TO MINIMIZE THE IMPACT ON TRAFFIC FLOW.

USING DOT APPROVED TRAFFIC BARRICADES, BARRELS, AN/OR CONES. TEMPORARY SIGNAGE AND FLAGMEN MAY ALSO BE

5. ALL WAL-MART PROPERTY DAMAGED DUE TO CONSTRUCTION

EROSION CONTROL MEASURES IMPLEMENTED INSIDE THE

ACTIVITIES MUST BE REPLACED/RESTORED TO MATCH THE EXISTING TYPE AND QUALITY OF WORK AND MATERIALS, AND IS

UTILITY WORK DONE ON WAL-MART PARCEL, WHETHER BY THE

GC, CITY OR THE UTILITY COMPANIES, SHALL BE REPAIRED BACK

WAL-MART DRIVE ISLES AND PARKING LOT SHALL INCLUDE ONLY

SILT BAGS (OR WAL-MART PRE-APPROVED EQUAL) TO ENSURE

DEVICES SHALL NOT BE ALLOWED INSIDE THE WAL-MART DRIVE

TRAFFIC CIRCULATION IS NOT IMPEDED. GRAVEL INLET PROTECTION

WAL-MART CONSTRUCTION/STORE MANAGER AND/OR ADJACENT

TEMPORARY RE-ROUTING OF TRAFFIC IS TO BE ACCOMPLISHED BY

IS NOT INTERRUPTED AT ANY TIME DUE TO CONSTRUCTION

(EACH DIRECTION) IS AVAILABLE AT ALL TIMES, FREE OF OBSTRUCTIONS TO VEHICLES. AT NO TIME SHALL THE

SPACE BELOW CITY REQUIREMENTS.

2. ALL PERMANENT TURF AREAS MUST BE SODDED.

FROM THE FACE OF THE CURB OR DRIVE.

SUBJECT TO WAL-MART APPROVAL.

TO EXISTING CONDITIONS.

ISLES OR PARKING LOT.

NECESSARY.

# **GENERAL SITE NOTES**

A. ALL DIMENSIONS SHOWN ARE TO THE FACE OF CURB UNLESS OTHERWISE NOTED.

LIMITS OF SIDEWALKS AND CONCRETE APRONS

CONCRETE CURB AND GUTTER. SEE

**BUILDING CONTROL POINT** 

- B. ALL CURB RETURN RADII SHALL BE 3' AS SHOWN TYPICAL ON THIS PLAN, UNLESS OTHERWISE NOTED.
- C. UNLESS OTHERWISE SHOWN, CALLED OUT OR SPECIFIED HERON: ALL CURB AND GUTTER ADJACENT TO EXISTING PAVING SHALL BE INSTALLED PER SHEET C-8
  - PAVEMENT SHALL BE INSTALLED IN ACCORDANCE WITH THE PAVING PLAN OVER THE ENTIRE PARKING LOT AREA AND ALL APPROACH DRIVES.
  - SEE ASSOCIATED PLANS FOR CANOPY, COLUMN, PUMP ISLAND DETAILS AND LAYOUT.
- D. CONTRACTOR SHALL BEGIN CONSTRUCTION OF ANY LIGHT POLE BASES FOR RELOCATED LIGHT FIXTURES AND RELOCATION OF ELECTRICAL SYSTEM AS SOON AS DEMOLITION BEGINS. CONTRACTOR SHALL BE AWARE THAT INTERRUPTION OF POWER TO ANY LIGHT POLES OR SIGNS SHALL NOT EXCEED 24 HOURS.
- . IF DEMOLITION OR CONSTRUCTION ON SITE WILL INTERFERE WITH THE WAL-MART TRAFFIC FLOW OR ADJACENT PROPERTY OWNER'S TRAFFIC FLOW, THE CONTRACTOR SHALL COORDINATE WITH THE WAL-MART CONSTRUCTION/STORE MANAGER AND/OR ADJACENT PROPERTY OWNER. TO MINIMIZED THE IMPACT ON TRAFFIC FLOW. TEMPORARY RE-ROUTING OF TRAFFIC IS TO BE ACCOMPLISHED BY USING DOT APPROVED TRAFFIC BARRICADES, BARRELS, AND/OR CONES. TEMPORARY SIGNAGE AND FLAGMEN MAY BE ALSO NECESSARY.
- F. ALL WAL-MART PROPERTY DAMAGED DUE TO CONSTRUCTION ACTIVITIES MUST BE REPLACED/RESTORED TO MATCH THE EXISTING TYPE AND QUALITY OF WORK AND MATERIALS, AND IS SUBJECT TO WAL-MART APPROVAL.
- G. CONTRACTOR TO PROTECT EXISTING LANDSCAPE/IRRIGATION MATERIAL.
- H. ALL SLOPES AND AREAS DISTURBED BY CONSTRUCTION SHALL BE GRADED SMOOTH AND FOUR INCHES OF TOPSOIL APPLIED. IF ADEQUATE TOPSOIL IS NOT AVAILABLE ON SITE, THE CONTRACTOR SHALL PROVIDE TOPSOIL, APPROVED BY THE OWNER, AS NEEDED. THE AREA SHALL THEN BE SEEDED/SODDED, FERTILIZED, MULCHED, WATERED AND MAINTAINED UNTIL HARDY GRASS GROWTH IS ESTABLISHED IN ALL AREAS. ANY AREAS DISTURBED FOR ANY REASON PRIOR TO FINAL ACCEPTANCE OF THE PROJECT SHALL BE CORRECTED BY THE CONTRACTOR AT NO ADDITIONAL COST TO THE OWNER.
- I. THE MURPHY STATION WILL NOT DROP THE WAL-MART GREEN SPACE BELOW CITY REQUIREMENTS.
- J. CONTRACTOR IS TO VERIFY LOCATION OF WAL-MART IRRIGATION SYSTEM, VALVE BOXES, CONTROL BOXES, BACKFLOW PREVENTION DEVICE AND OTHER ITEMS WHICH ARE PART OF THE SYSTEM, IF DAMAGES OCCUR THEY MUST BE REPAIRED AT CONTRACTORS'S COST.
- K. THE LOCATION OF THE CONSTRUCTION FENCE ON THE DRAWING IS FOR GRAPHICAL REPRESENTATION ONLY. THE CONTRACTOR IS TO ENSURE THAT THE CONSTRUCTION FENCE ENCOMPASSES THE ENTIRE WORK AREA.
- L. CONTRACTOR SHALL PURCHASE AND INSTALL A MAILBOX, AND SHALL COORDINATE LOCATION OF MAILBOX WITH MURPHY CONSTRUCTION MANAGER AND/OR ON-SITE REPRESENTATIVE AND LOCAL POSTMASTER.
- M. ALL PROPOSED PAVEMENT STRIPING OR MARKINGS SHALL FOLLOW THE SPECIFICATIONS FOR PAINT INCLUDED IN

### ☐ SITE DETAILS

- 1A TYPE A CONCRETE CURB AND GUTTER 1B TYPE B CONCRETE INTEGRAL CURB AND GUTTER
- 1P RAISED CURB AND GUTTER
- 2E DUMPSTER ENCLOSURE CONSTRUCTION FENCE
- 3K CONCRETE SIDEWALK 3N WHEELCHAIR RAMP IN SIDEWALK (TYPICAL AT EACH DRIVEWAY CURB RETURN)
- 5F GUARD POST (SINGLE) 9U ACCESSIBLE PARKING SYMBOL (SEE PAINT COLOR INDICATED AT SYMBOL)
- 9V ACCESSIBLE / VAN PARKING SIGN MOUNTED IN BOLLARD
- 10A TRAFFIC FLOW ARROW (TYP.) 10B STOP BAR (TYP.)
- 12F SIGN BASE
- 12G STOP SIGN 13A SITE LIGHT POLE (SEE PHOTOMETRIC PLANS FOR POLE BASE DETAIL, FIXTURE TYPE, AND MOUNTING DETAILS)
- 18G CONSTRUCTION CAMERA COORDINATE WITH MUSA PM FOR LOCATION) 21G AIR VACUUM UNIT WITH 4'X7' CONCRETE SLAB.
- 21P 5'X7' ICE UNIT. SEE NUMBER INDICATED AT SYMBOL.
- 21T MAILBOX (CONTRACTOR SHALL COORDINATE WITH MURPHY PM POSTMASTER PRIOR TO INSTALLATION) 21U CONCRETE PAD FOR PROPANE RACK.

# SITE NOTES

- 2B TRANSFORMER PAD 2G DRILL (2) 3/4" X 5/8" DIA. HOLES (1) EACH FOR OPEN POSITION & CLOSED POSITION OF GATES. TO BE USED
- ON BOTH SIDES OF GATE. SEE DUMPSTER DETAIL. 8B OVERHEAD CANOPY - (TYP. PER ARCH. PLANS).
- 12A 4 INCH TRAFFIC YELLOW LANE STRIPE (SEE LENGTH INDICATED AT SYMBOL).
- 12D 4 INCH WIDE PAINTED STRIPES. 2.0 FOOT O.C. @ 45 DEGREES (SEE SIZE INDICATED AT SYMBOL). 14J GC TO INSTALL (1) 4" PVC SLEEVE FOR IRRIGATION LINE. SEE UTILITY PLAN FOR INSTALLATION REQUIREMENTS.
- 14K GC TO INSTALL (2) 4" PVC SLEEVE FOR FUTURE USE. SEE UTILITY PLAN FOR INSTALLATION REQUIREMENTS.
- 21A TAPER CURB TO MATCH EXISTING CURB.
- 21D EDGE OF CONCRETE SLAB (PER TANK AND PIPING PLANS). 21E UNDERGROUND STORAGE TANKS (1) 25,000 GAL.-REGULAR, (1) 8,000 GAL.-PREMIUM, (1) 10,000
- GAL.-DIESEL, (1) 8,000 GAL-E-O. 21K MURPHY USA ID SIGN PER APPROVED ELEVATION.
- 21L PRICE SIGN PER APPROVED ELEVATION. 24D PROPOSED ELECTRIC TRANSFORMER 51B LIMITS OF SAWCUT AND PAVEMENT REMOVAL

1A

ERVIOUS SITE RATIO (ISR) SQUARE FEET )US 24,564 78% AVING) 6,996 32,122 100%

**REQUIRED:** BUILDING DESCRIPTION AREA (S.F) RATIO SPACES 1,400 REGULAR ACCESSIBLE | VAN ACCESSIBLE **TOTAL** MURPHY OIL 1/300 S.F STALL DIMENSIONS: PROVIDED: 9' X 18' RATIO ACCESSIBLE VAN ACCESSIBLE REGULAR 1/300 S.F TOTAL

─ 25' UTILITY EASEMENT

PARKING INFORMATION MURPHY OIL

PER PLAT BK. 00, PG. 57790

SUBJECT TRACT-

PARCEL #840-11300-005

OUTLOT #3R

WAL-MART SUPERCENTER

PLAT BK. 2000, PG. 57790

MURPHY OIL USA INC.

DEED BK. 2009, PG. 82202

ZONE: C-2

32,119 SQ. FT.±

OR 0.74 AC.±

BRYANT AVE.

PUBLIC (ASPHALT) 60' R/W

PER PLAT BK. 2000, PG. 57790

S87°41'22"E 63.00' 146.63°

12F | 12G |

FASFMFNT

PG. 34513

NO. OF FUEL ISLANDS: 8

EXISTING —

5/8" REBAR CAP CEI N - 2024315.13'

E - 1163448.93'

Elev.= 419.42'

ACCESS EASEMENT ~

1/2" REBAR

N: 2024191.95'

E: 1163496.67'

PER PLAT BK. 00, PG. 57790

PARCEL #840-12237-012

BRYANT AVENUE CENTER LLC

DEED BK. 2001, PG. 41233

ZONE: C-2

TRACT A

**WAL-MART SUPERCENTER** 

PARCEL #840-11300-000

WALMART REAL ESTATE BUSINESS TRUST

DEED BK. 2008, PG. 82137

ZONE: C-2

1,400 SF

6 MPD (S)

FFE: 417.45

15' REAR SETBACK

N87°40'5Ŏ'"W 281.88'

OUTLOT #2R

**WAL-MART SUPERCENTER** 

PARCEL #840-11300-002

TUESDAY INVESTMENT LLC

DEED BK. 2019, PG. 007468

NO. OF VEHICLE FUELING POINTS: 16

ZONE: C-3

5/8" REBAR CAP CEI

N - 2024393.20'

Elev.= 417.55'

E - 1163694.72'

PRE-C	ONSTRUCTION	POST-0	CONSTRUCTION	
IMPERVIO	US SITE RATIO (IS	IMPERVIC	US SITE RATIO (IS	
AREA SQUARE FEET %			AREA	SQUARE FEET
IMPERVIOUS (ROOF AND PAVING)	22,754	71%	IMPERVIOUS (ROOF AND PAVING)	24,564
GREEN SPACE	9,368	29%	GREEN SPACE	6,996
GROSS SITE	32,122	100%	GROSS SITE	32,122

DETENTION POND **WAL-MART SUPERCENT**I

PARCEL #840-11300-00

**WAL-MART STORES INC** 

N: 2024180.58' E: 1163778.31'


PLAT BK. 2000, PG. 5775


· 10' DRAINAGE ZONE: C-3

EASEMENT PER PLAT

BK. 00, PG. 57790

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"SIGN SPECIFICATION & CUT-SHEET"

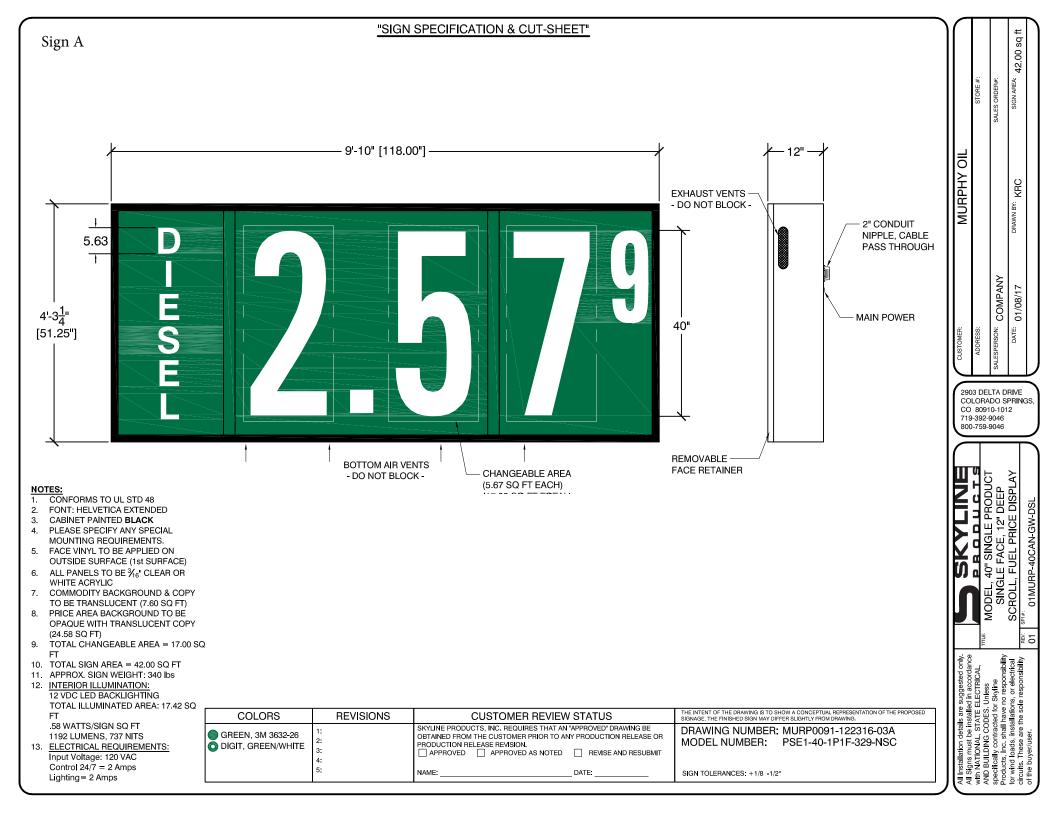
- CONFORMS TO UL STD 48
- FONT: HELVETICA EXTENDED
- CABINET PAINTED BLACK
- PLEASE SPECIFY ANY SPECIAL MOUNTING REQUIREMENTS.
- FACE VINYL TO BE APPLIED ON OUTSIDE SURFACE (1st SURFACE)
- ALL PANELS TO BE 3/6" CLEAR OR WHITE ACRYLIC
- COMMODITY BACKGROUND & COPY TO BE TRANSLUCENT (7.60 SQ FT)
- PRICE AREA BACKGROUND TO BE OPAQUE WITH TRANSLUCENT COPY (24.58 SQ FT)
- TOTAL CHANGEABLE AREA = 17.00 SQ
- 10. TOTAL SIGN AREA = 42.00 SQ FT
- 11. APPROX. SIGN WEIGHT: 340 lbs
- 12. INTERIOR ILLUMINATION: 12 VDC LED BACKLIGHTING TOTAL ILLUMINATED AREA: 17.42 SQ
  - .58 WATTS/SIGN SQ FT 1192 LUMENS, 737 NITS
- ELECTRICAL REQUIREMENTS: Input Voltage: 120 VAC Control 24/7 = 2 Amps Lighting= 2 Amps

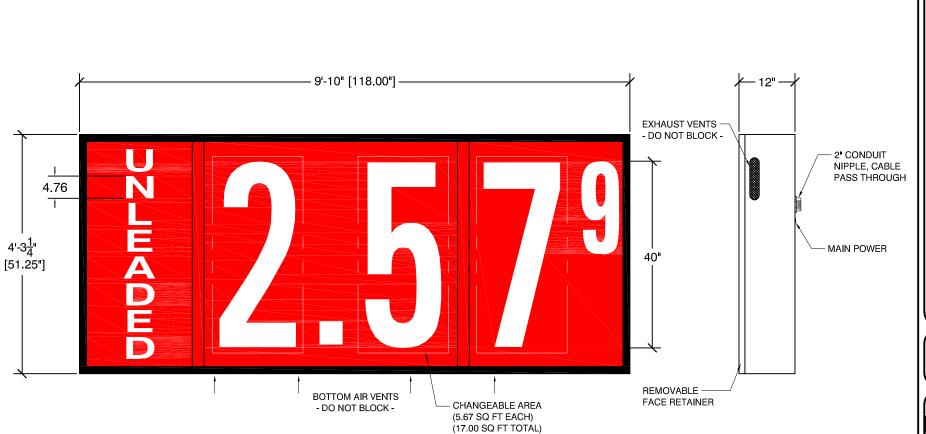
L	COLORS	REVISIONS	CUSTOMER REVIEW STATUS	SIGNAGE, THE FINISHED SIGN MAY DIFFER SLIGHTLY FROM DRAWING.
	RED, 3M 3632-73 DIGIT, RED/WHITE	2.	SKYLINE PRODUCTS, INC. REQUIRES THAT AN "APPROVED" DRAWING BE OBTAINED FROM THE CUSTOMER PRIOR TO ANY PRODUCTION RELEASE OR PRODUCTION RELEASE REVISION.  APPROVED APPROVED REVISE AND RESUBMIT	DRAWING NUMBER: MURP0091-122316-03A MODEL NUMBER: PSE1-40-1P1F-329-NSC
		5:	NAME: DATE:	SIGN TOLERANCES: +1/8 -1/2"

			42.00	
	STORE #:	SALES ORDER#:	SIGN AREA:	
MURPHY OIL			DRAWN BY: KRC	
CUSTOMER:	ADDRESS;	SALESPERSON: COMPANY	DATE: 01/08/17	_
290	3 DEI	TAD	RIVE	
2903 DELTA DRIVE COLORADO SPRINGS, CO 80910-1012 719-392-9046 800-759-9046				

) sq ft

P B O D U C T S , 40" SINGLE PRODUCT SLE FACE, 12" DEEP , FUEL PRICE DISPLAY MODEL, 40" SINGLE F.

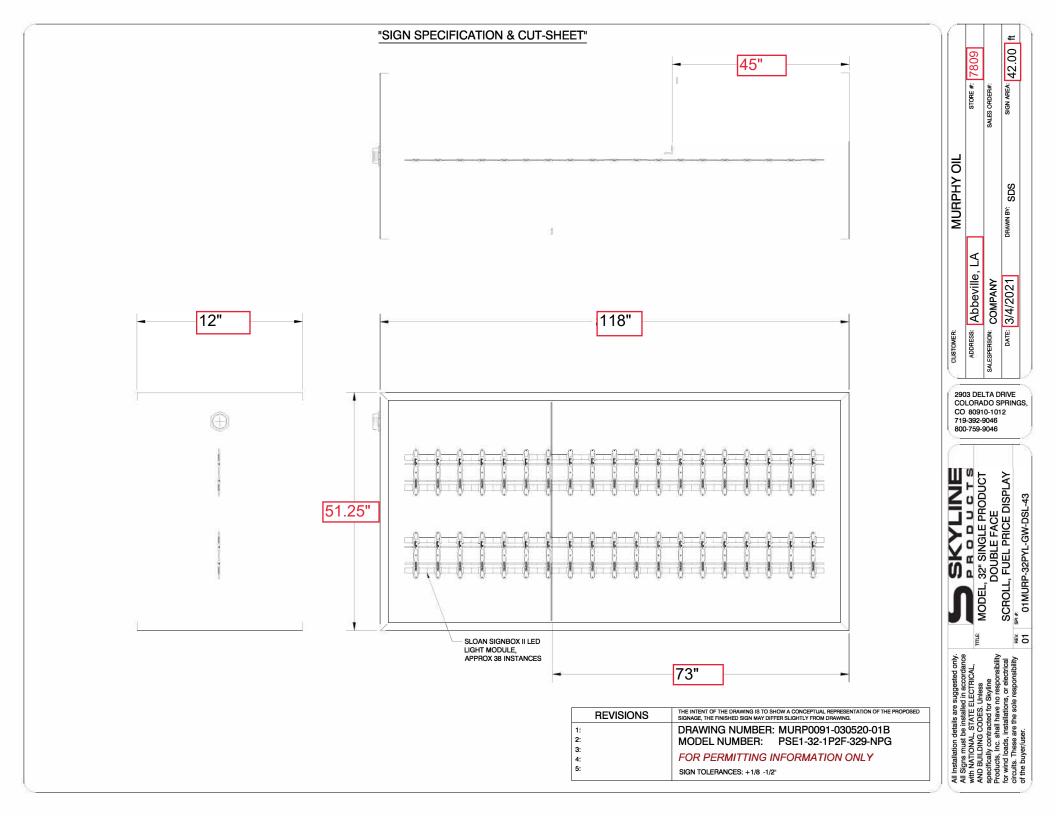

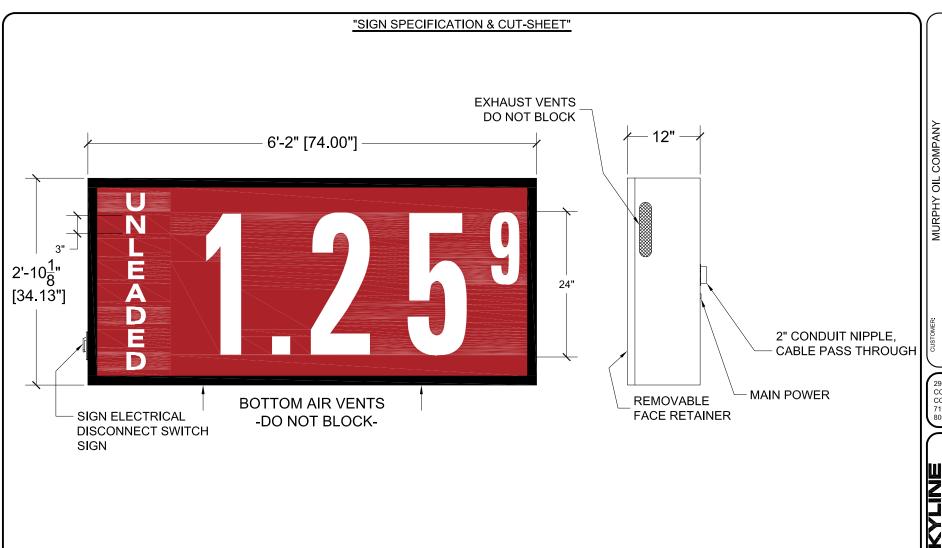

- 1. CONFORMS TO UL STD 48
- 2. FONT: HELVETICA EXTENDED BOLD
- CABINET PAINTED BLACK
- PLEASE SPECIFY ANY SPECIAL MOUNTING REQUIREMENTS.
- SIGN HOUSING NOT DESIGNED TO BE LOAD **BEARING**
- FACE VINYL TO BE APPLIED ON OUTSIDE SURFACE (1st SURFACE)
- ALL PANELS TO BE 3/16" CLEAR
- COMMODITY BACKGROUND TO BE TRANSLUCENT WITH TRANSLUCENT COPY
- PRICE AREA BACKGROUND TO BE OPAQUE
- WITH TRANSLUCENT COPY

TOTAL = 3.2 Amps

10. INTERIOR ILLUMINATION: LED BACKLIGHTING **ELECTRICAL REQUIREMENTS:** Input Voltage: 120 VAC Control 24/7 = 2 Amps Lighting= 1.2 Amps

COLORS
RED, 3M 3632-73 WHITE, 3M 3632 ODIGIT, RED/WHI

#### - REAR MOUNTING ONLY -

### MOUNTING STRUCTURE & SUPPORTS BY OTHERS


COLORS	REVISIONS	CUSTOMER REVIEW STATUS	SIGNAGE, THE FINISHED SIGN MAY DIFFER SLIGHTLY FROM DRAWING.	-O3ED
RED, 3M 3632-73 WHITE, 3M 3632-20	1:	SKYLINE PRODUCTS, INC. REQUIRES THAT AN "APPROVED" DRAWING BE OBTAINED FROM THE CUSTOMER PRIOR TO ANY PRODUCTION RELEASE OR PRODUCTION RELEASE REVISION. APPROVED REVISE & RE-SUBMIT		
O DIGIT, RED/WHITE	5: 4: 5:	NAME:DATE:		CS

DRAWN BY: JJB COMPANY 2903 DELTA DRIVE COLORADO SPRINGS CO 80910-1012 719-392-9046 800-759-9046

17.54 sq ft

CHECKED BY: KRC

SCROLL FUEL PRICE DISPLAY 01MURP-24CAN-RW-UNI

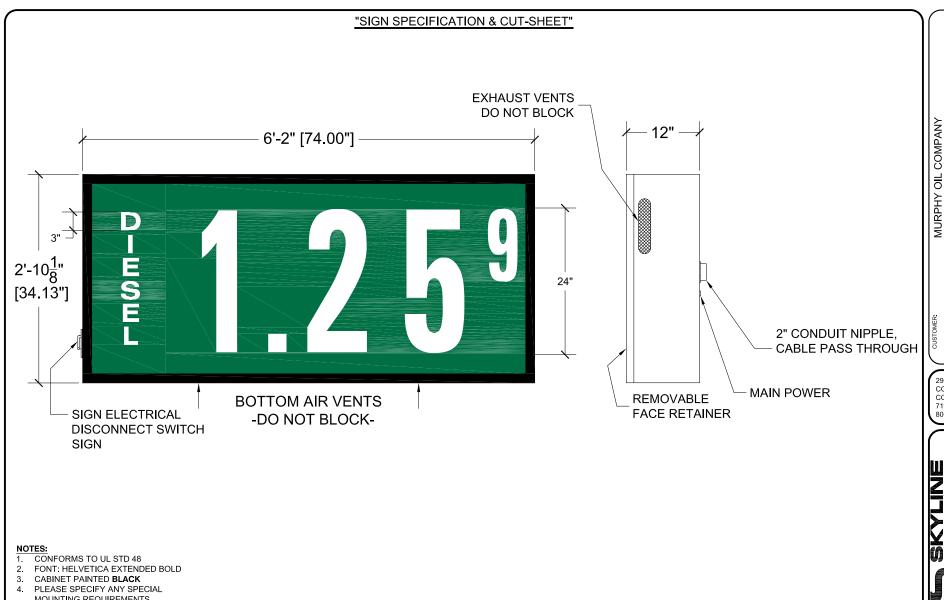

- MOUNTING REQUIREMENTS.
- SIGN HOUSING NOT DESIGNED TO BE LOAD **BEARING**
- FACE VINYL TO BE APPLIED ON OUTSIDE SURFACE (1st SURFACE)
- ALL PANELS TO BE 3/16" CLEAR
- COMMODITY BACKGROUND TO BE TRANSLUCENT WITH TRANSLUCENT COPY
- PRICE AREA BACKGROUND TO BE OPAQUE
- WITH TRANSLUCENT COPY 10. INTERIOR ILLUMINATION: LED BACKLIGHTING **ELECTRICAL REQUIREMENTS:**

Input Voltage: 120 VAC Control 24/7 = 2 Amps Lighting= 1.2 Amps TOTAL = 3.2 Amps

### - REAR MOUNTING ONLY -


### MOUNTING STRUCTURE & SUPPORTS BY OTHERS

COLORS	REVISIONS	CUSTOMER REVIEW STATUS	SIGNAGE, THE FINISHED SIGN MAY DIFFER SLIGHTLY FROM DRAWING.	OSED
GREEN, 3M 3632-26  WHITE, 3M 3632-20	1: 2:	SKYLINE PRODUCTS, INC. REQUIRES THAT AN "APPROVED" DRAWING BE OBTAINED FROM THE CUSTOMER PRIOR TO ANY PRODUCTION RELEASE OR PRODUCTION RELEASE REVISION. APPROVED REVISE & RE-SUBMIT		
O DIGIT, GREEN/WHITE	4: 5:	NAME:DATE:		ASS. CS

CHECKED BY: KRC COMPANY 2903 DELTA DRIVE COLORADO SPRINGS CO 80910-1012 719-392-9046 800-759-9046

17.54 sq ft

SCROLL FUEL PRICE DISPLAY 01MURP-24CAN-GW-DSI

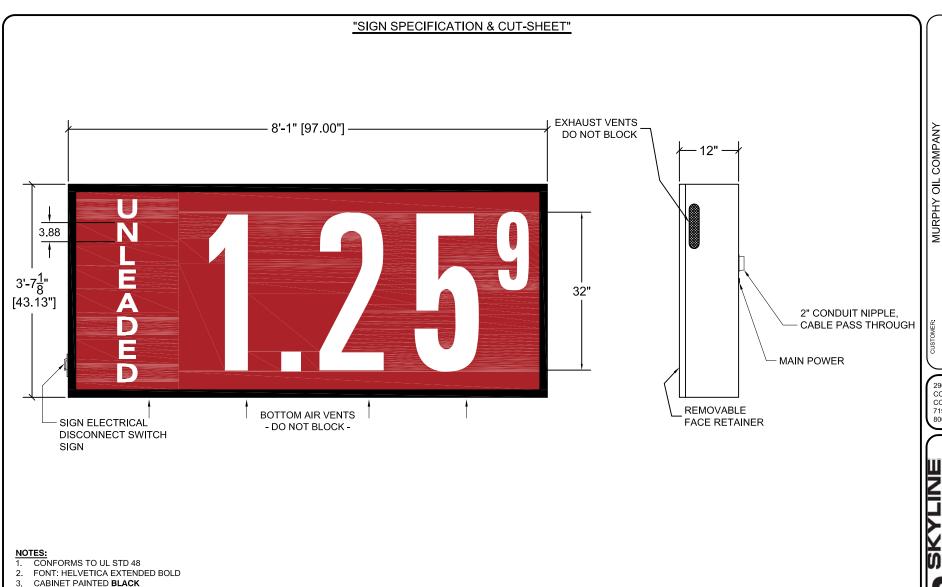

- PLEASE SPECIFY ANY SPECIAL MOUNTING REQUIREMENTS.
- SIGN HOUSING NOT DESIGNED TO BE LOAD BEARING
- 6. FACE VINYL TO BE APPLIED ON OUTSIDE SURFACE (1st SURFACE)
- ALL PANELS TO BE 3/16" CLEAR
- COMMODITY BACKGROUND TO BE TRANSLUCENT WITH TRANSLUCENT COPY
- PRICE AREA BACKGROUND TO BE OPAQUE
- WITH TRANSLUCENT COPY 10. INTERIOR ILLUMINATION: LED BACKLIGHTING **ELECTRICAL REQUIREMENTS:** Input Voltage: 120 VAC Control 24/7 = 2 Amps Lighting= 2.4 Amps

TOTAL = 4.4 Amps

MOUNTING	STRUCTUR	E & SUPPOR	RTS BY	OTHER:

- REAR MOUNTING ONLY -

### S

COLORS	REVISIONS	CUSTOMER REVIEW STATUS	THE INTENT OF THE DRAWING IS TO SHOW A CONCEPTUAL REPRESENTATION OF THE PROPOSED SIGNAGE, THE FINISHED SIGN MAY DIFFER SLIGHTLY FROM DRAWING.
RED, 3M 3632-73 WHITE, 3M 3632-20	1: 2:	SKYLINE PRODUCTS, INC. REQUIRES THAT AN "APPROVED" DRAWING BE OBTAINED FROM THE CUSTOMER PRIOR TO ANY PRODUCTION RELEASE OR PRODUCTION RELEASE REVISION. APPROVED REVISE & RE-SUBMIT	DRAWING NUMBER: MURP0091-060920-01A MODEL NUMBER: PSE1-32-1P1F-329-NSC
O DIGIT, RED/WHITE	3: 4: 5:	NAME:DATE:	SIGN TOLERANCES: +1/8 -1/2" CLASS.

.05 sq ft 29. COMPANY 6/10/2020 ADDRESS:

2903 DELTA DRIVE COLORADO SPRINGS CO 80910-1012 719-392-9046 800-759-9046

SKYLINE PRODUCTS FUEL PRICE DISPLAY 01MURP-32CAN-RW-UNI



